




NOTE: Verify all dimensions with the architectural drawings.

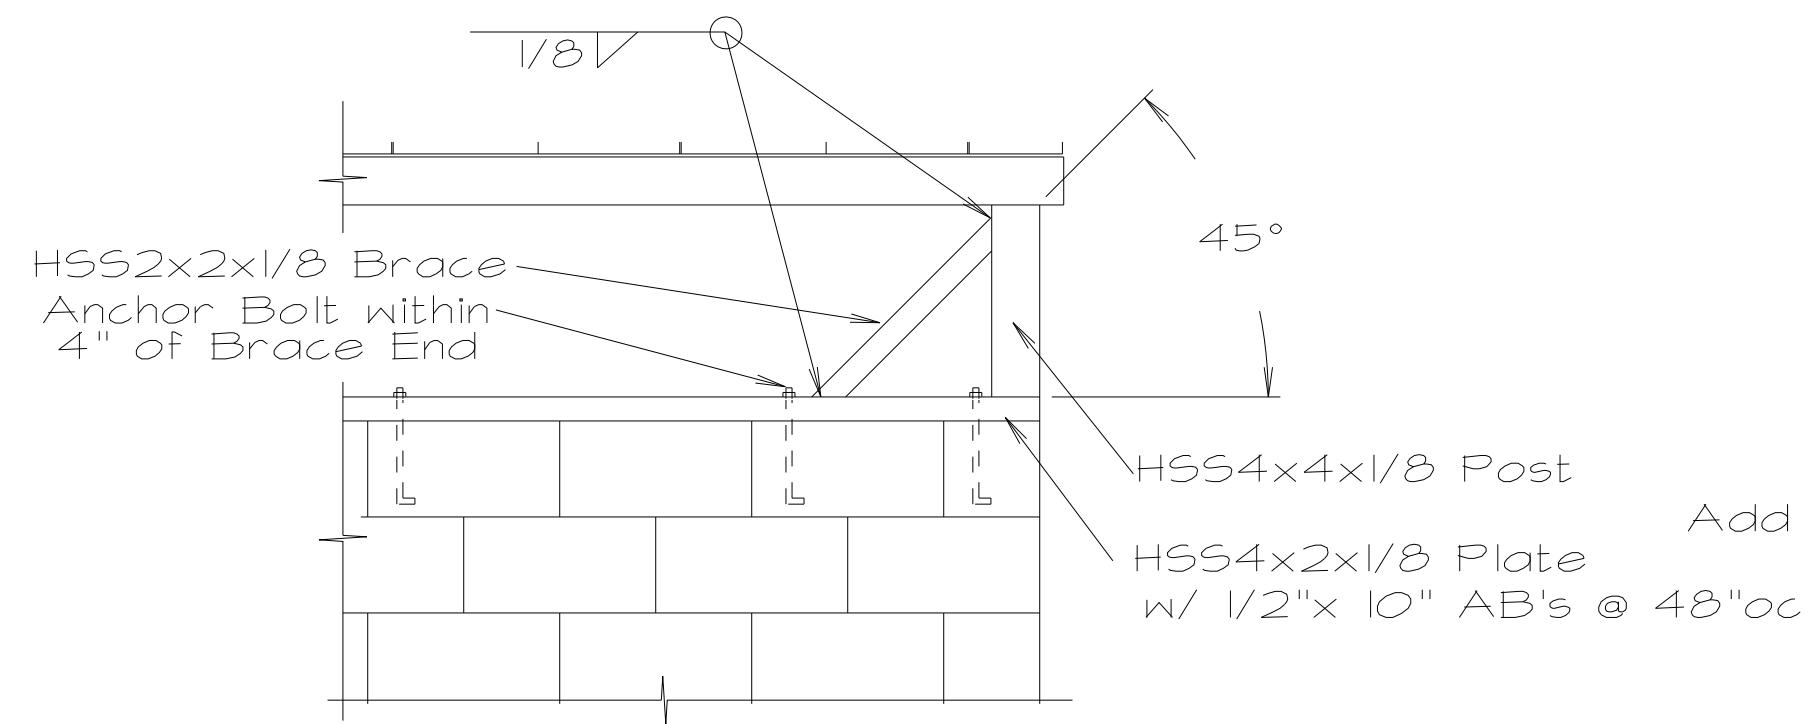


**AB ANGLE BRACE DETAIL TYP.**  
3/4" = 1'-0"

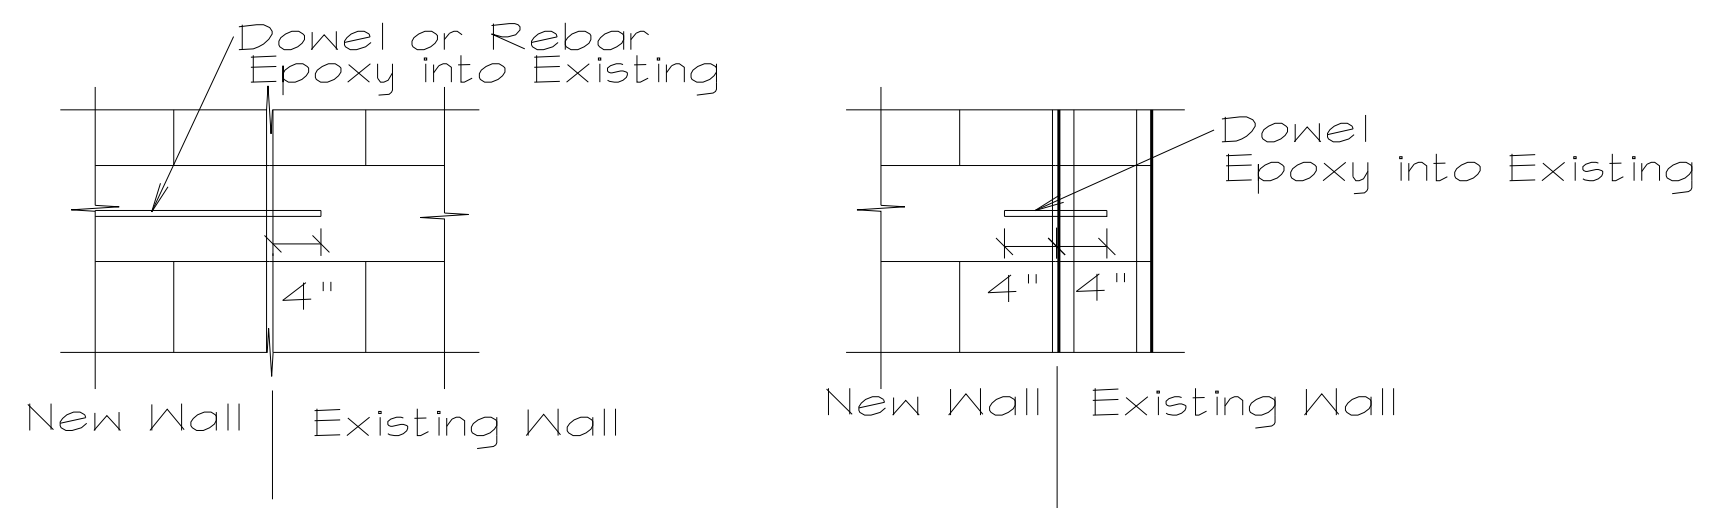


**TD TYPICAL DOWEL DETAIL**  
3/4" = 1'-0" USE: Simpson SET Epoxy System

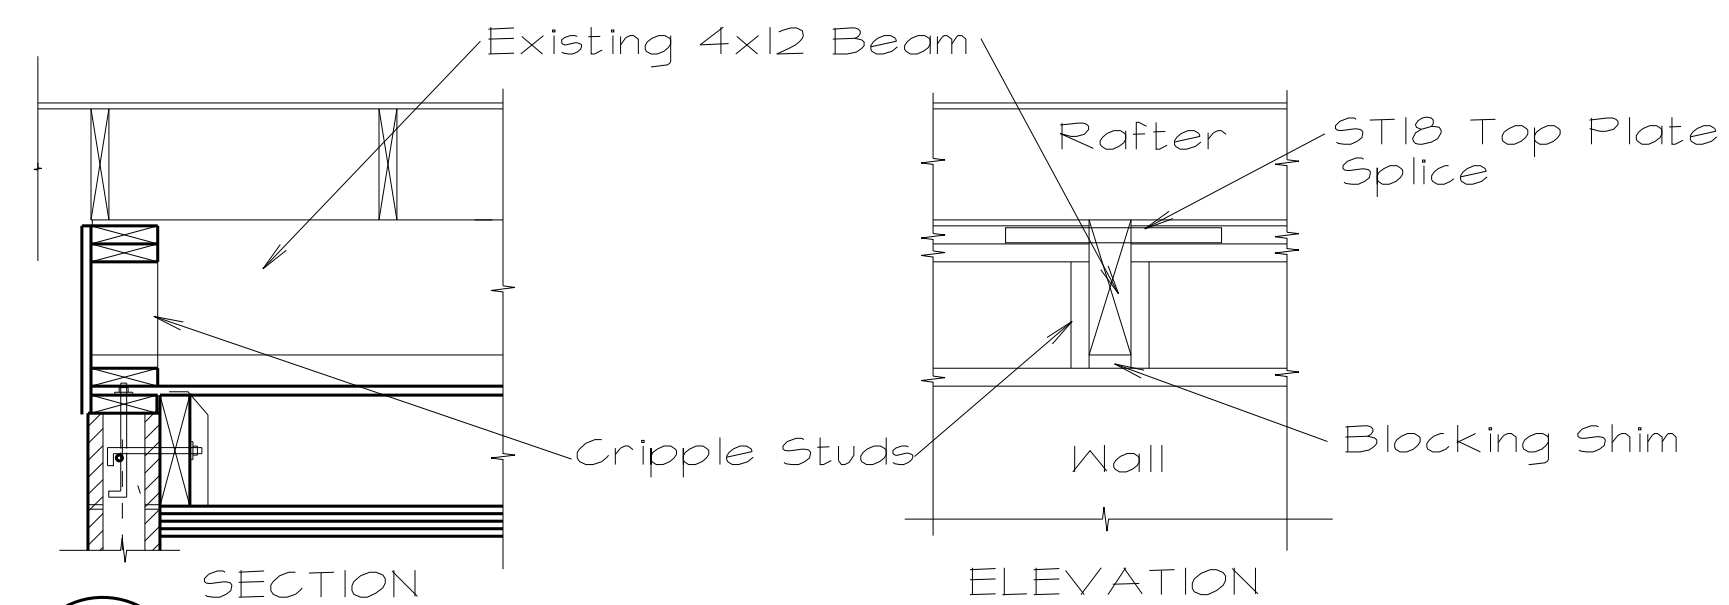


**BW BEAM ON NEW CMU WALL**  
3/4" = 1'-0"

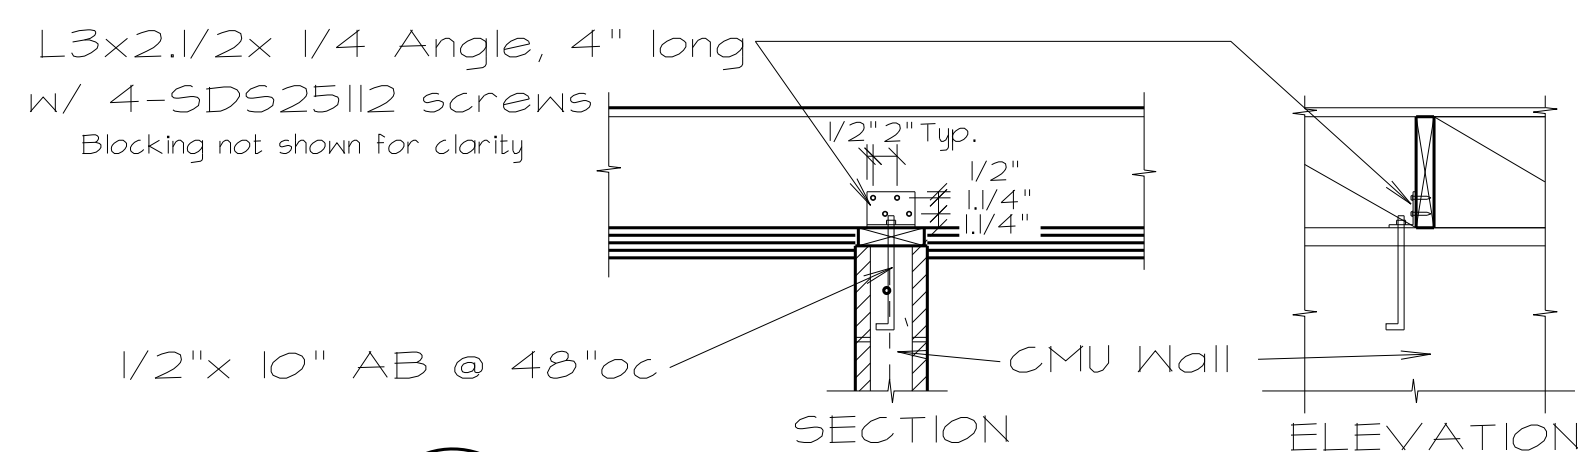


**CW CENTER WALL OUT OF PLANE TIE**  
3/4" = 1'-0"

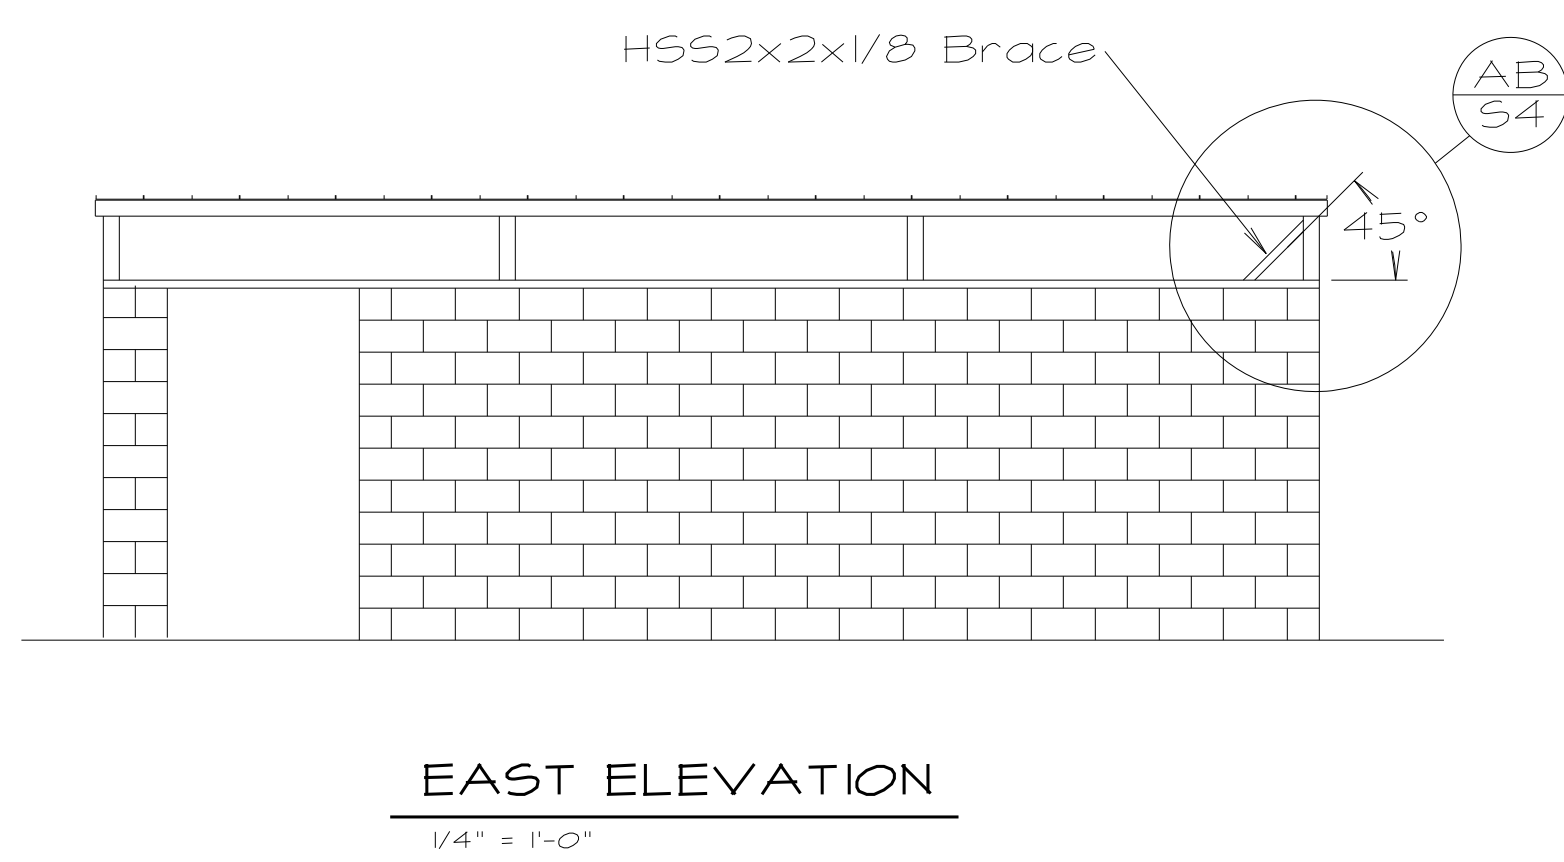


**EAST ELEVATION**  
1/4" = 1'-0"

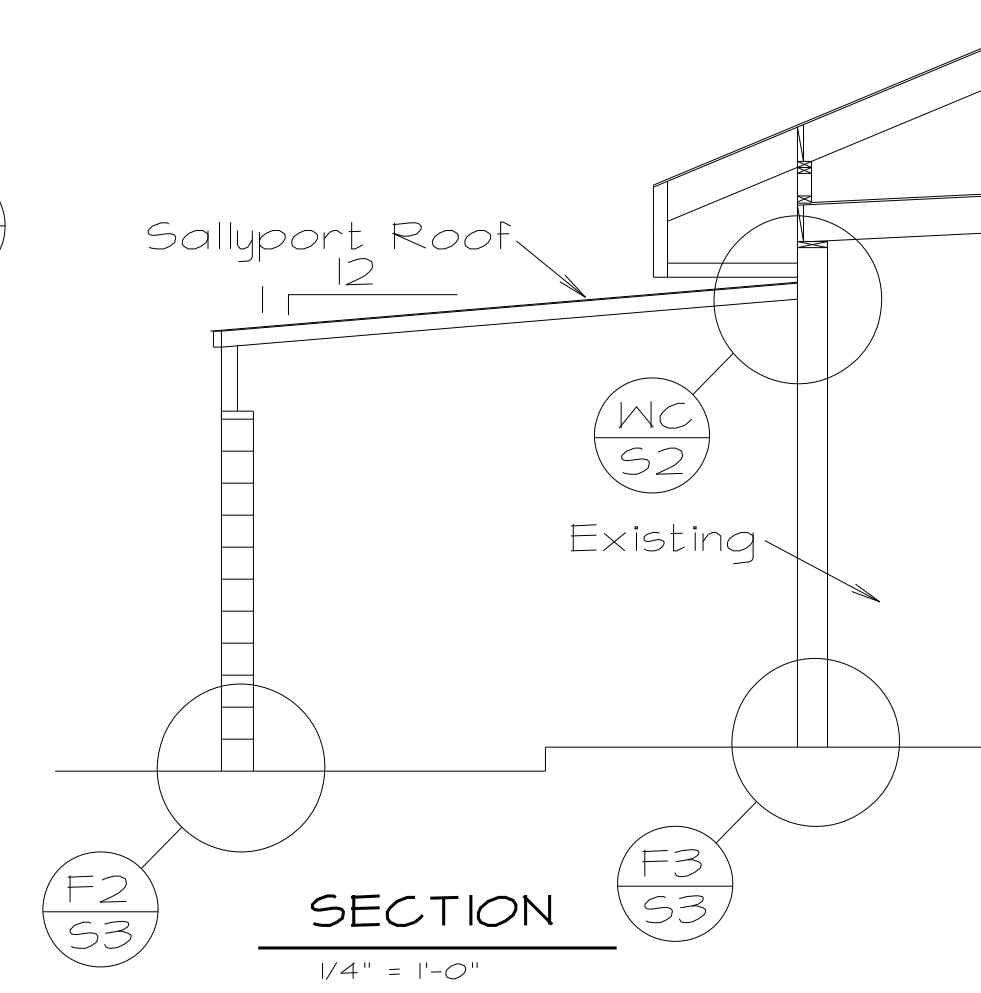


**SECTION**  
1/4" = 1'-0"

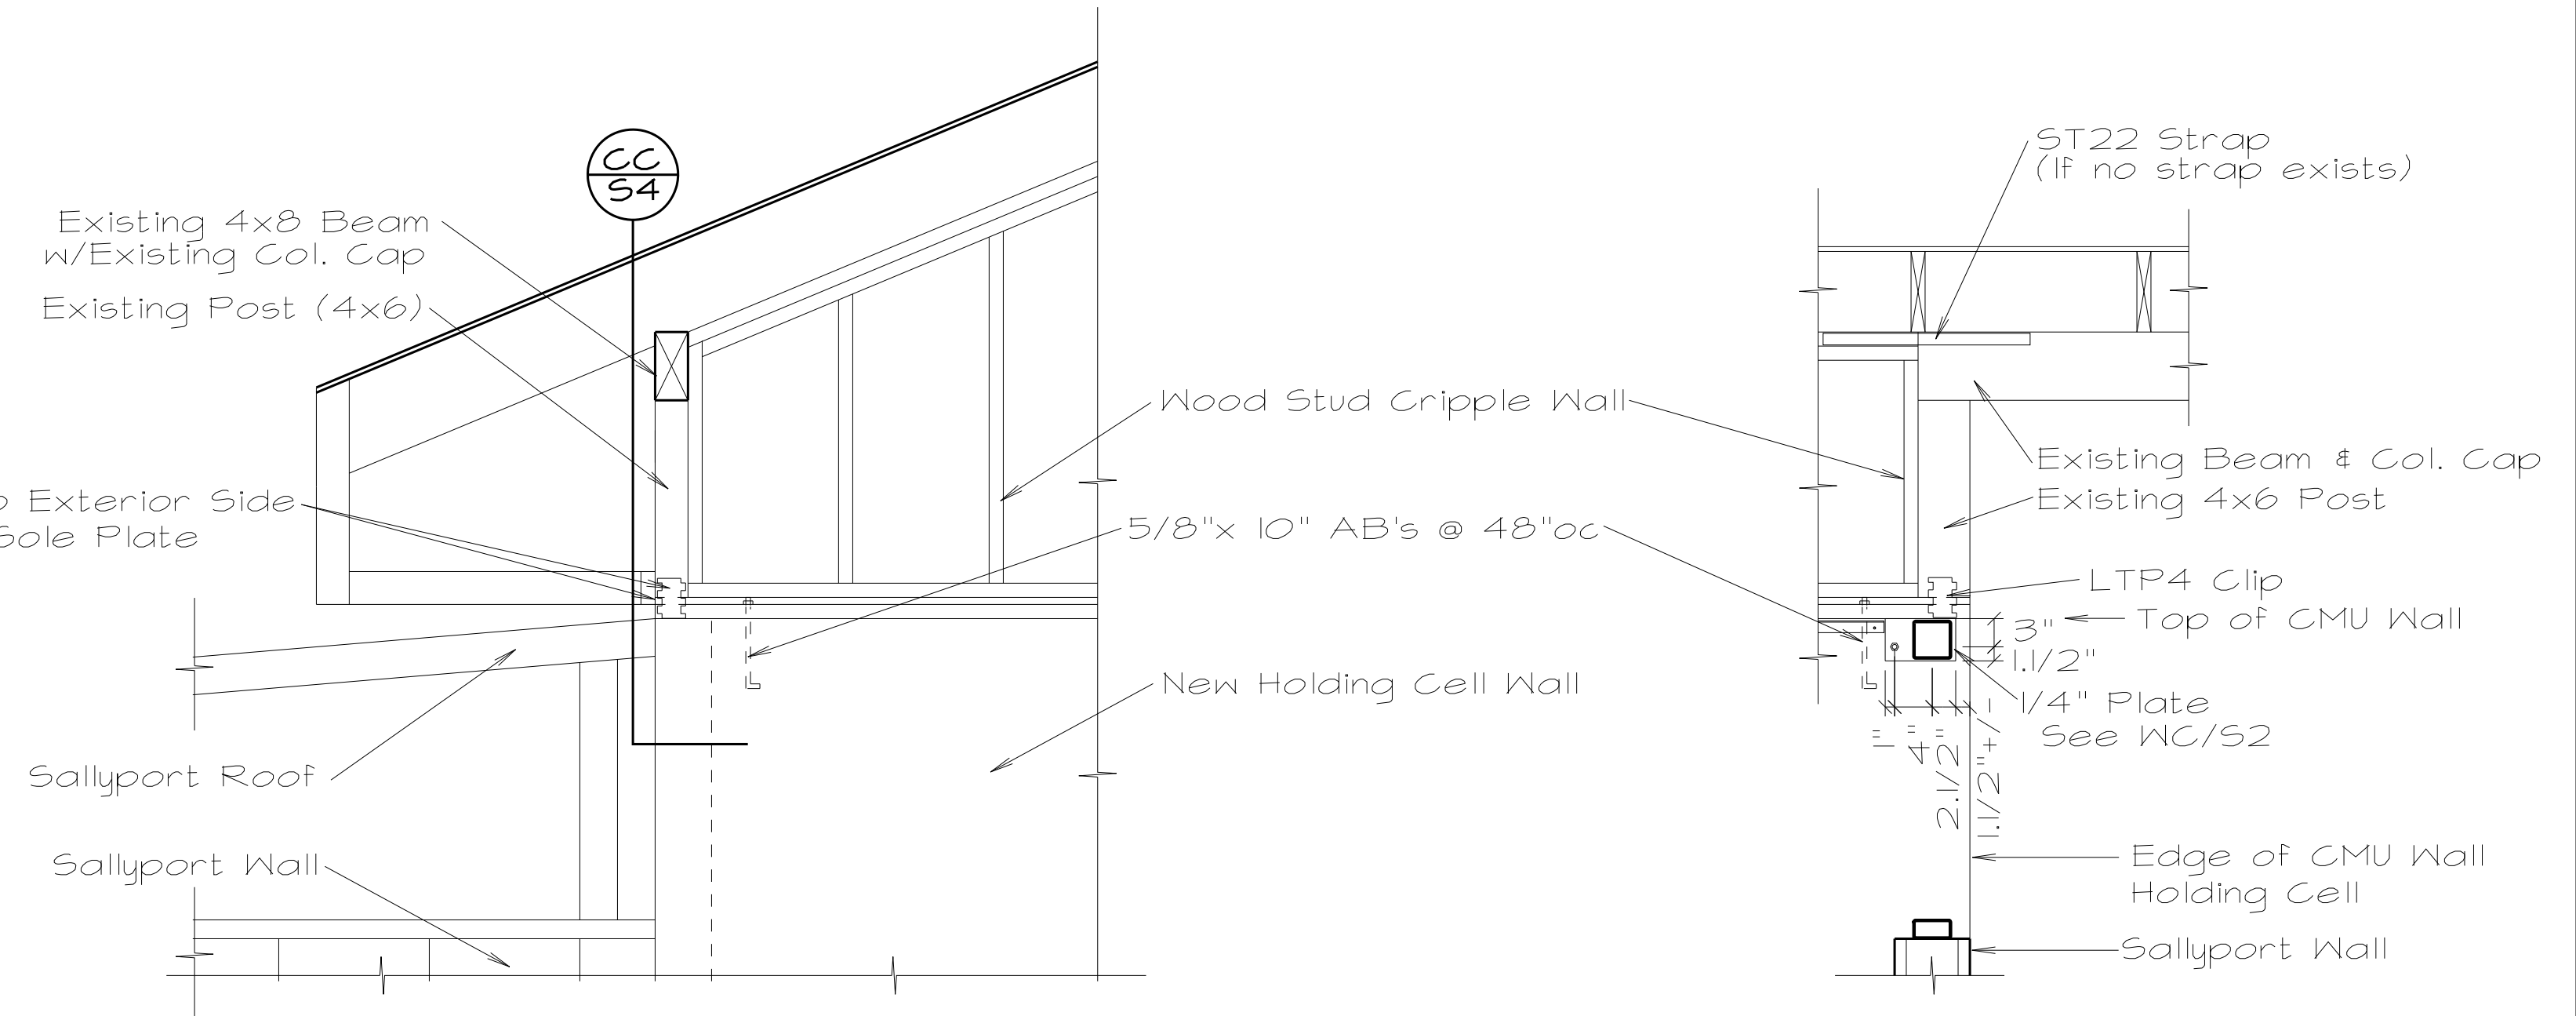


**EB EXISTING BEAM SUPPORT AT NEW WALL** 3/4" = 1'-0"  
**CC CORNER DETAIL** 3/4" = 1'-0"

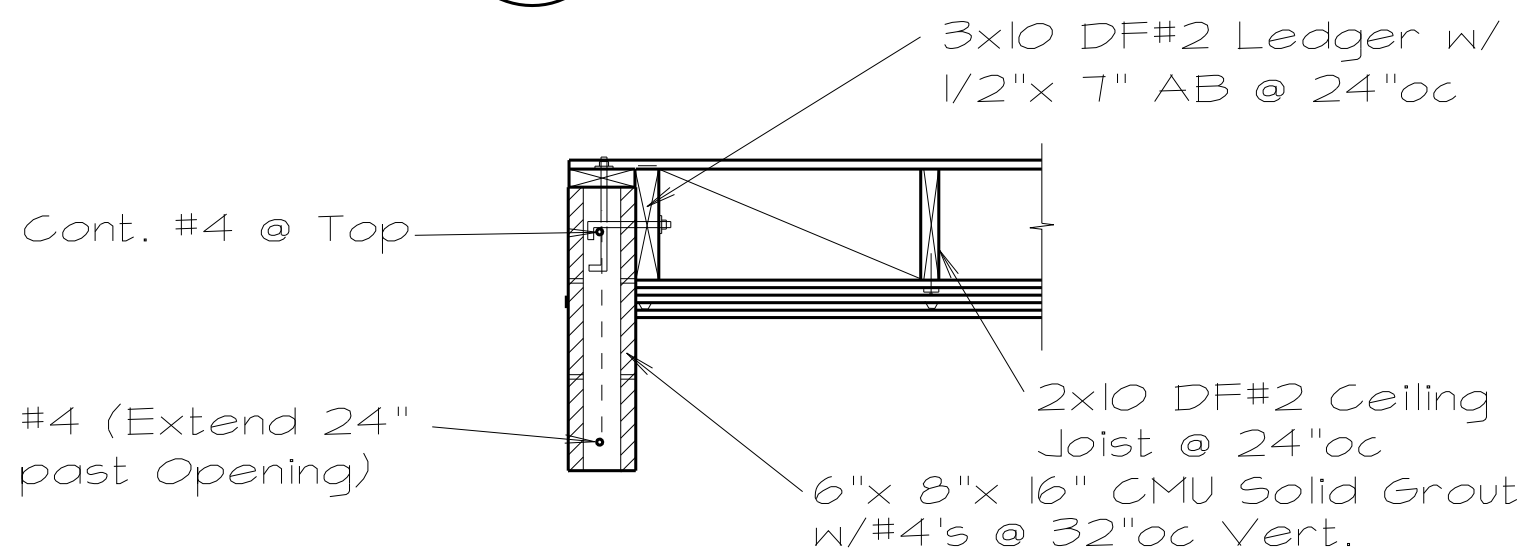


**LI LINTEL SECTION TYP.**  
3/4" = 1'-0"

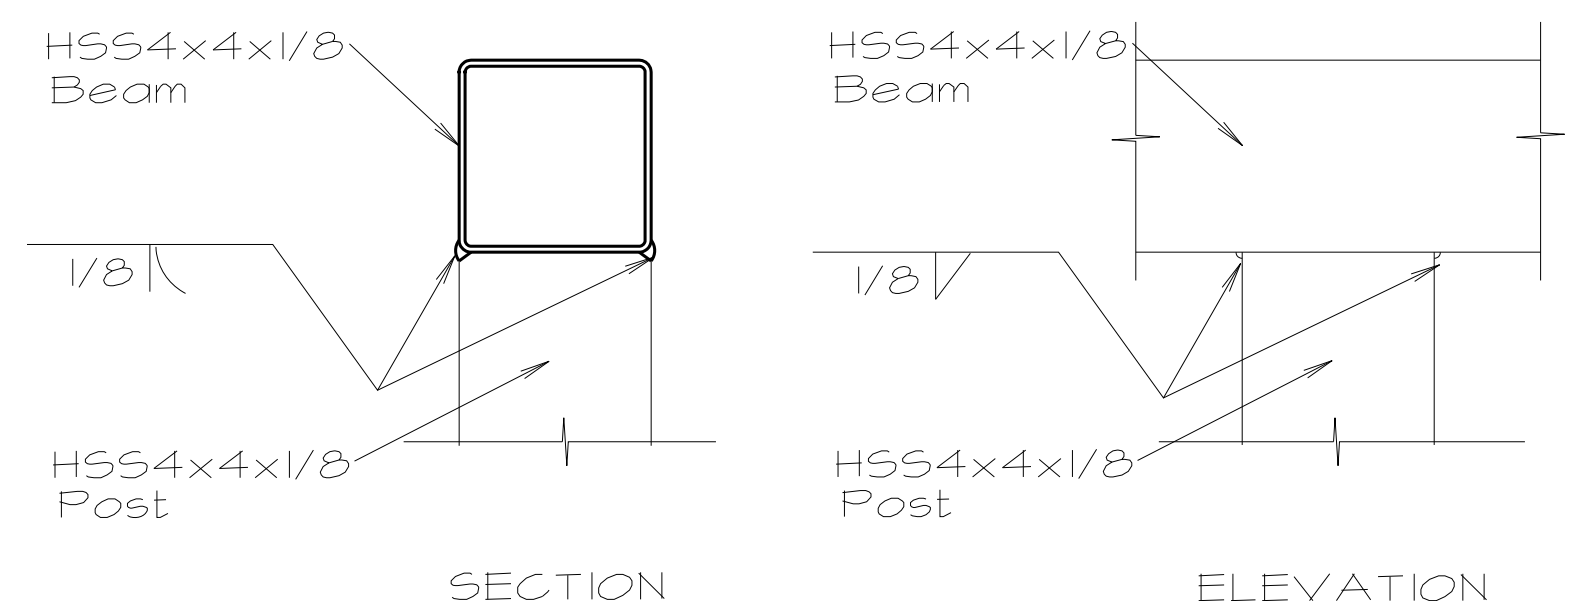


**TW TYPICAL WELD DETAIL**  
3" = 1'-0"

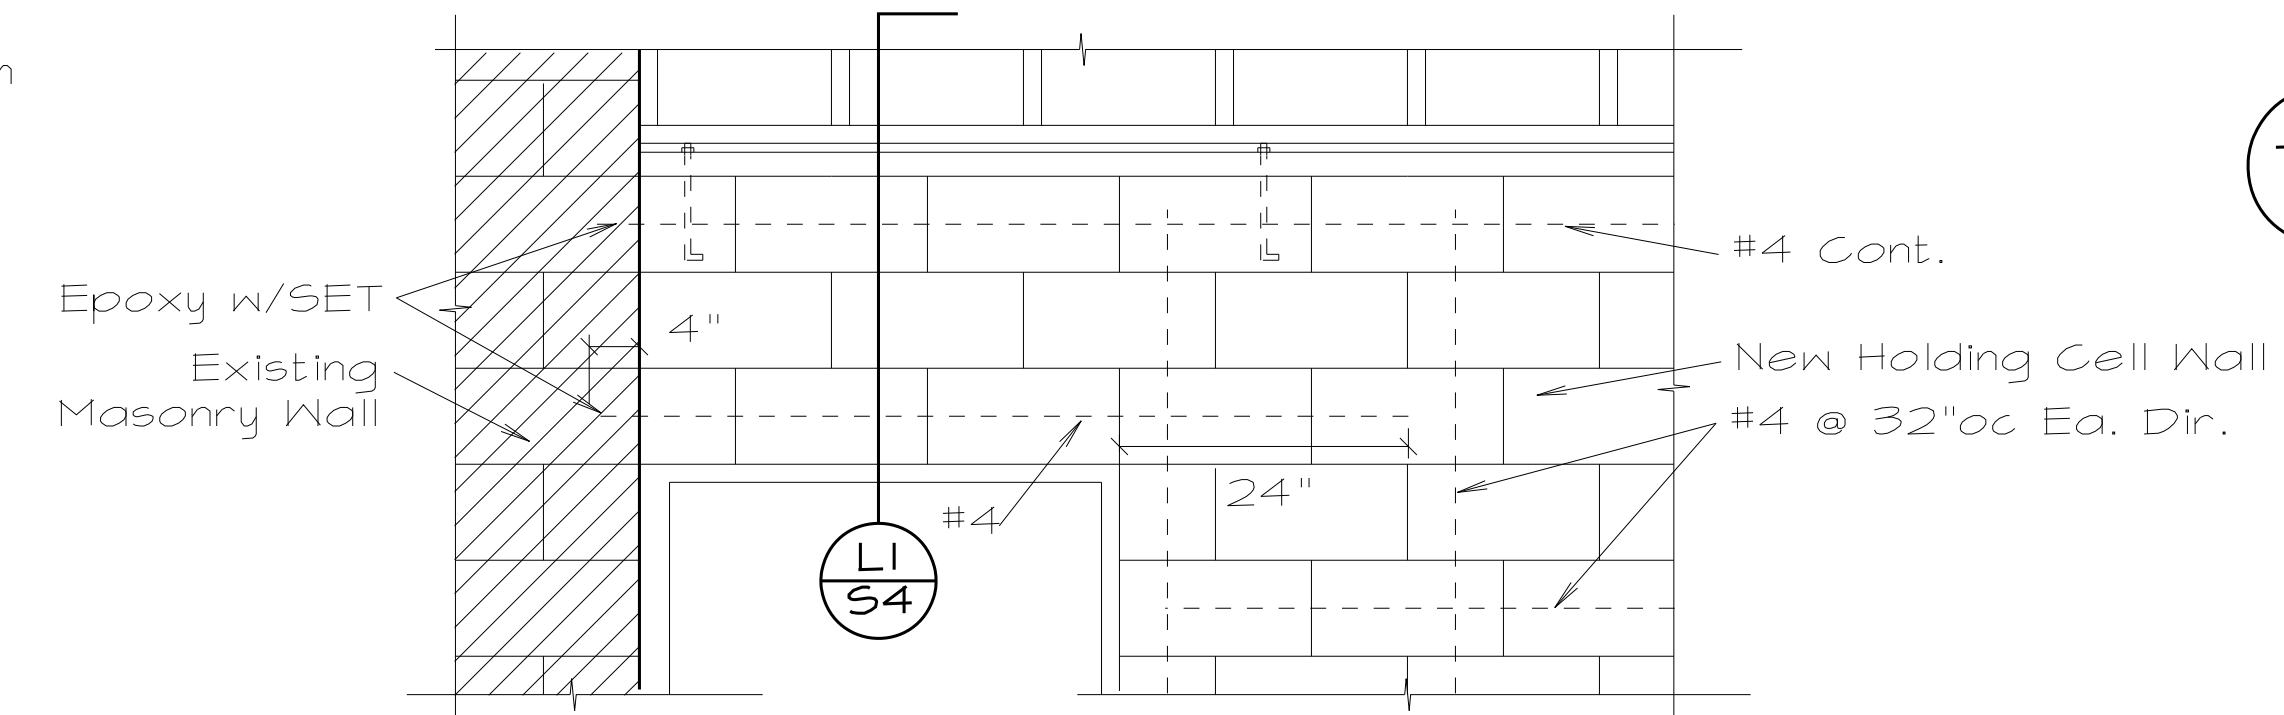

**C2 LINTEL ELEVATION TYP.**  
3/4" = 1'-0"

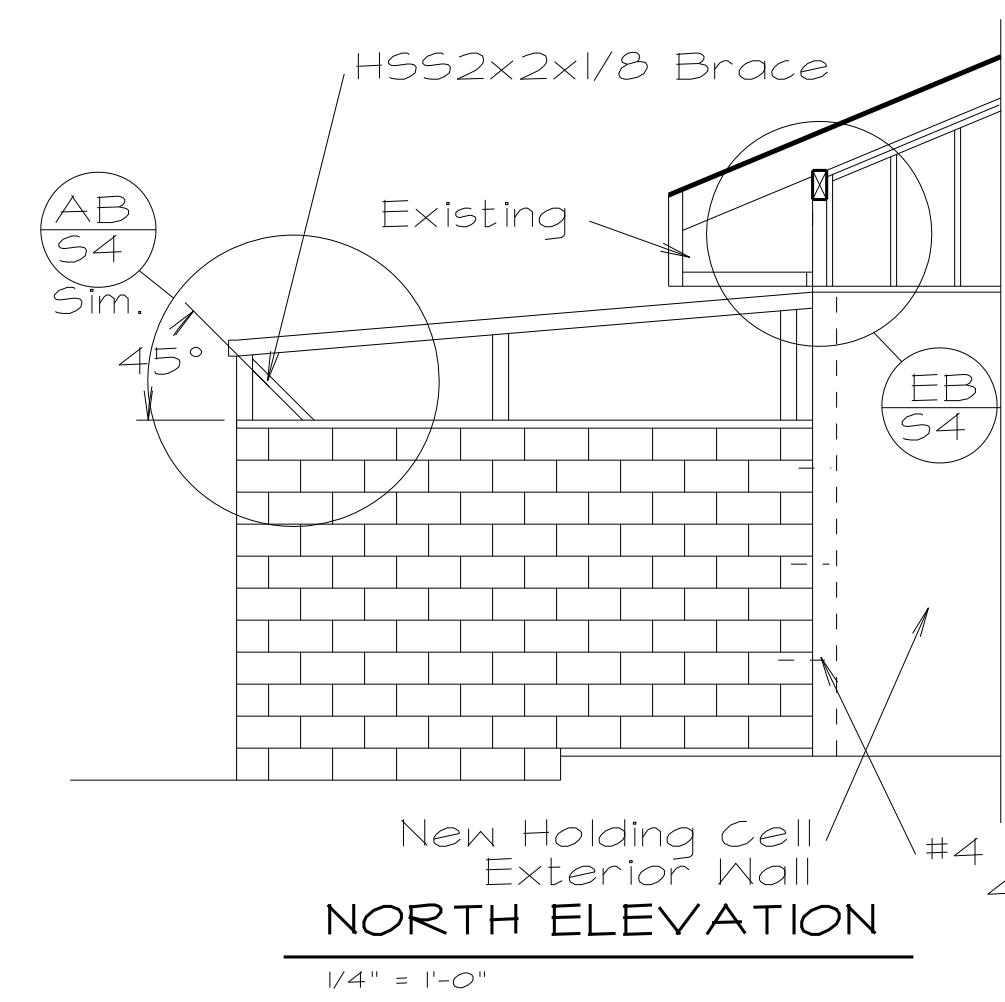

**NORTH ELEVATION**  
1/4" = 1'-0"

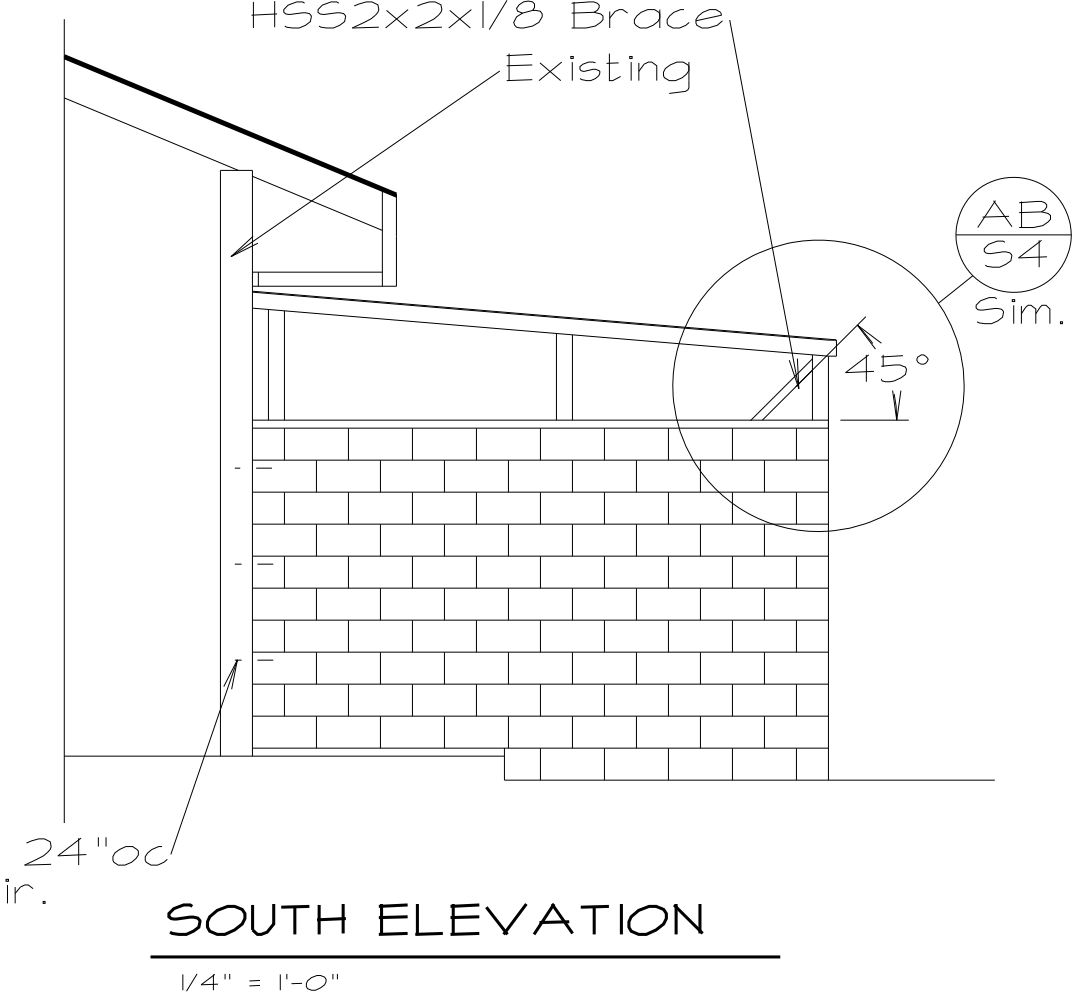

**SOUTH ELEVATION**  
1/4" = 1'-0"

See Architectural Elevations for Relative Heights

NEW HOLDING CELL PROJECT

DELENO / NORTH KERN COURT

1122 JEFFERSON ST. DELENO, CALIFORNIA

STEPHEN MACIE, P.E.  
CALIF. CE: 28063, HI. SE: 5974  
1009 Marro St. #201  
San Luis Obispo, CA 93401  
PH: 805-541-3837  
Email: ECVL3EAOL.COM



REV 11/10

The use of these plans and specifications shall be restricted to the original site for which they were prepared and publication thereof is expressly limited to such use. Reproduction or publication by any method, in whole or in part, is prohibited. Title to these plans and specifications remain with the engineer or architect without prejudice. It shall be the responsibility of the contractor to verify and be responsible for all dimensions and existing conditions on the job and shall report any discrepancies to the engineer or the architect for resolution prior to commencing work.

SHEET TITLE:

SHEET #: S4