1550 MADONNA ROAD, SAN LUIS OBISPO, CALIFORNIA



REMODELING PRE-1978 STRUCTURES WITHOUT USING LEAD SAFE WORK **PRACTICES** IS A VIOLATION OF CALIFORNIA HEALTH AND SAFETY CODE SECTION 105256, CONTRACTORS, REMODELERS, AND PAINTERS ARE REQUIRED TO USE "LEAD SAFE" WORK PRACTICES PURSUANT TO TITLE 17, CA CODE OF REGULATIONS SECTION 36050. CONSTRUCTION DEBRIS KNOWN TO CONTAIN LEAD-BASED PAINT MUST BE DISPOSED OF AT AN APPROVED LOCATION. CONTACT UTILITIES CONSERVATION AT 781-7213

STATEMENT OF COMPLIANCE

THIS PROJECT HAS, TO THE BEST OF MY KNOWLEDGE AND UNDERSTANDING, BEEN DESIGNED IN ACCORDANCE WITH AND MEETS THE SAN LUIS OBISPO CITY ADOPTED CODE AND ORDINANCE REQUIREMENTS INCLUDING, BUT NOT LIMITED TO, THE CALIFORNIA STATE ACCESSIBILITY STANDARDS AND I/WE WILL BE RESPONSIBLE FOR ALL CLARIFICATIONS DEEMED NECESSARY DURING THE CONSTRUCTION PHASES.



BRUCE FRASER, PROJECT ARCHITECT OF RECORD

C 9787

LICENSE NUMBER

SPECIAL INSPECTIONS

SPECIAL INSPECTION SHALL BE PROVIDED IN CONFORMANCE WITH REQUIREMENTS OF CBC CHAPTER 17 FOR DRYPACK AT LIGHT FIXTURE

THE WORK DESCRIBED IN THESE CONSTRUCTION DOCUMENTS DOES NOT INCLUDE ITEMS THAT REQUIRED SPECIAL INSPECTIONS AS DEFINED IN CALIFORNIA BUILDING CODE SECTIONS 1704, 1707 AND 1708,

DEFERRED SUBMITTALS

THE WORK DESCRIBED IN THESE CONSTRUCTION DOCUMENTS DOES NOT INCLUDE ITEMS THAT WILL BE REVIEWED AND APPROVED AS DEFERRED SUBMITTALS ALLOWED BY THE SAN LUIS OBISPO BUILDING DEPARTMENT UNDER CALIFORNIA BUILDING CODE GENERAL REQUIREMENTS.

ADDITIONAL PERMITS

WORK ASSOCIATED WITH THE PROJECT DESCRIBED IN THESE CONSTRUCTION DOCUMENTS WHICH WILL BE SEPARATELY SUBMITTED FOR PERMIT REVIEW AND APPROVAL INCLUDES:

- COMPLETE SOLAR PHOTOVOLTAIC ELECTRIC GENERATING SYSTEM, INCLUDING ATTACHMENT TO PROJECT POWER DISTRIBUTION SYSTEM, FOR A CONSTRUCTION PERMIT.
- 2. CONSTRUCTION OCCURRING IN THE PUBLIC RIGHT-OF-WAY, FOR AN ENCROACHMENT PERMIT.

A SEPARATE ENCROACHMENT PERMIT IS REQUIRED FOR ANY WORK IN THE PUBLIC RIGHT-OF-WAY OR WITHIN CITY EASEMENTS FOR CONNECTIONS TO PUBLIC UTILITIES. WORK REQUIRING AN ENCROACHMENT PERMIT INCLUDES BUT IS NOT LIMITED TO DEMOLITIONS, UTILITIES, WATER, SEWER, AND FIRE SERVICE LATERALS, CURB, GUTTER, AND SIDEWALK, DRIVEWAY APPROACHES, SIDEWALK UNDERDRAINS, STORM DRAIN IMPROVEMENTS, STREET TREE PLANTING OR PRUNING, CURB RAMPS, STREET PAVING, AND PEDESTRIAN PROTECTION OR CONSTRUCTION STAGING IN THE RIGHT-OF-WAY.


CONTACT THE PUBLIC WORKS INSPECTION HOTLINE 781-7554 WITH AT LEAST 48 HOURS NOTICE FOR ANY REQUIRED ENCROACHMENT PERMIT INSPECTION OF FINAL INSPECTION.

A TRAFFIC AND PEDESTRIAN CONTROL PLAN SHALL BE SUBMITTED TO THE PUBLIC WORKS DEPARTMENT FOR REVIEW AND APPROVAL PRIOR TO ENCROACHMENT PERMIT ISSUANCE.

A PRE-CONSTRUCTION MEETING SHALL BE COORDINATED BY THE OWNER / DEVELOPER OR CONTRACTOR AND SHALL INCLUDE PERTINENT CITY STAFF. AS A MINIMUM, THE ASSIGNED BUILDING INSPECTOR AND PUBLIC WORKS INSPECTOR SHALL BE INCLUDED IN THIS MEETING TO DISCUSS THE LIMIT OF THE INSPECTION RESPONSIBILITIES.

THE PUBLIC IMPROVEMENTS SHALL BE SUBSTANTIALLY COMPLETE TO THE SATISFACTION OF THE PUBLIC WORKS DIRECTOR PRIOR TO FINAL INSPECTION APPROVALS AND / OR OCCUPANCY OF ANY BUILDING.

ANY SECTIONS OF DAMAGED OR DISPLACED CURB, GUTTER & SIDEWALK OR DRIVEWAY APPROACH SHALL BE REPAIRED OR REPLACED TO THE SATISFACTION OF THE PUBLIC WORKS DIRECTOR.

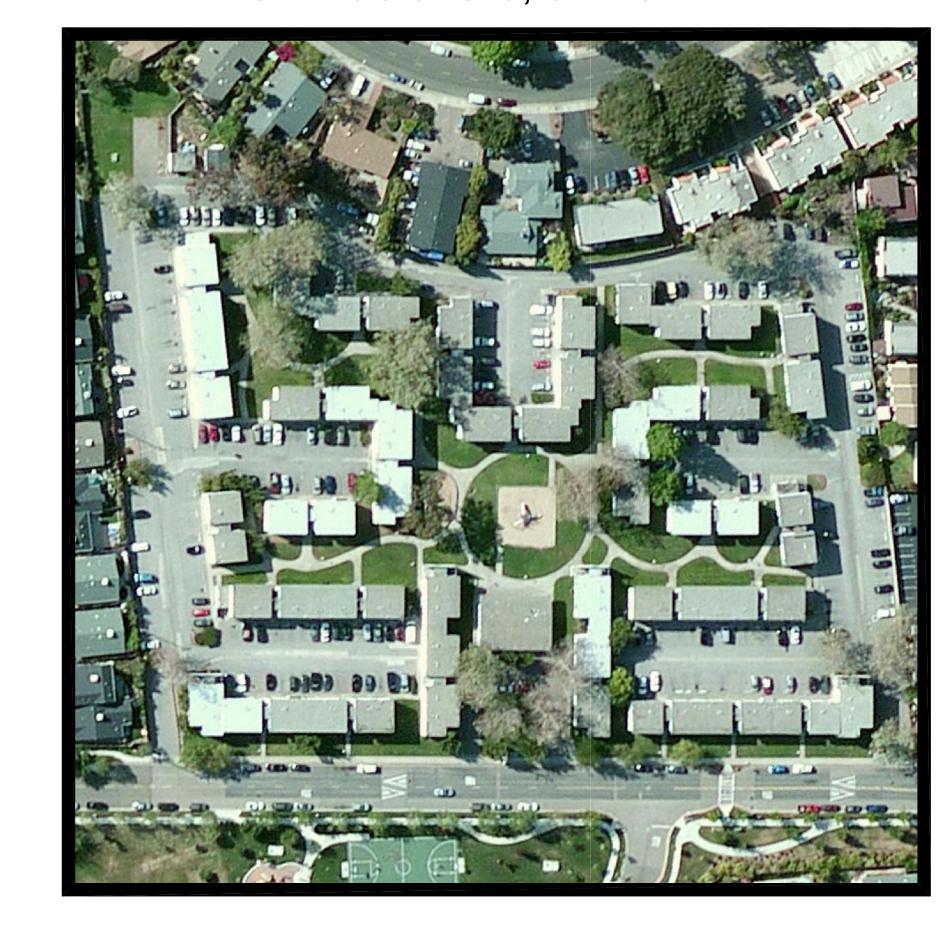

GENERAL NOTES

- ALL WORK SHALL COMPLY WITH THE MINIMUM STANDARDS OF THE FOLLOWING CODES:
 - 2010 BUILDING STANDARDS ADMINISTRATIVE CODE, PART 1, TITLE 24 C.C.R. 2010 CALIFORNIA BUILDING CODE (CBC), PART 2, TITLE 24 C.C.R. (2009) INTERNATIONAL BUILDING CODE AND 2010 CALIFORNIA AMENDMENTS)
 - 2010 CALIFORNIA ELECTRICAL CODE (CEC), PART 3, TITLE 24 C.C.R.
 - (2008 NATIONAL ELECTRICAL CODE AND 2010 CALIFORNIA AMENDMENTS) 2010 CALIFORNIA MECHANICAL CODE (CMC) PART 4, TITLE 24 C.C.R.
 - (2009 UNIFORM MECHANICAL CODE AND 2010 CALIFORNIA AMENDMENTS)
 - 2010 CALIFORNIA PLUMBING CODE (CPC), PART 5, TITLE 24 C.C.R.
 - (2009 UNIFORM PLUMBING CODE AND 2010 CALIFORNIA AMENDMENTS) 2010 CALIFORNIA FIRE CODE, PART 9, TITLE 23 C.C.R.
 - (2009 INTERNATIONAL FIRE CODE AND 2010 CALIFORNIA AMENDMENTS)
 - 2010 CALIFORNIA GREEN BUILDING STANDARDS CODE (CALGREEN), PART 11, TITLE 24 C.C.R.
 - 2010 CALIFORNIA REFERENCED STANDARDS, PART 12, TITLE 24 C.C.R.
 - TITLE 19 C.C.R. PUBLIC SAFETY, STATE FIRE MARSHAL REGULATIONS.
- THE CALIFORNIA ENERGY CONSERVATION STANDARDS FOR NON-RESIDENTIAL CONSTRUCTION, CONTAINED IN TITLE 24 OF THE CALIFORNIA CODE OF REGULATIONS, HAVE BEEN REVIEWED AND THE COMMON BUILDING DESCRIBED HEREIN IS IN SUBSTANTIAL CONFORMANCE WITH THOSE STANDARDS WHICH APPLY TO NEW CONSTRUCTION.
- THE CONTRACTOR SHALL VERIFY ALL EXISTING CONDITIONS FOR DIMENSION, GRADE, CONFIGURATION, AND OTHER ASPECTS OF COMPATIBILITY WITH THE WORK DESCRIBED IN THESE CONSTRUCTION DOCUMENTS. ANY CONDITIONS WHICH INTERFERE WITH THE WORK SHALL IMMEDIATELY BE BROUGHT TO THE ATTENTION OF THE ARCHITECT AND THE WORK SHALL NOT PROCEED IN THE AREAS OF CONFLICT UNTIL SUCH CONFLICTS HAVE BEEN RESOLVED.
- WRITTEN DIMENSIONS SHALL TAKE PRECEDENCE OVER DRAWING SCALE OR PROPORTION.
- A KEY BOX ACCEPTABLE TO THE SAN LUIS OBISPO FIRE DEPARTMENT SHALL BE PLACED AS DIRECTED, CONTAINING ALL KEYS NECESSARY TO ALLOW FIRE DEPARTMENT PERSONNEL ACCESS TO ALL PORTIONS OF BUILDING SPACES.
- PRIOR TO COMMENCEMENT OF ANY WORK IN THE PUBLIC RIGHT-OF-WAY AN ENCROACHMENT PERMIT SHALL BE OBTAINED FROM THE CITY DEPARTMENT OF PUBLIC WORKS. A SEPARATE PERMIT SHALL BE OBTAINED FROM THE CITY DEPARTMENT OF PUBLIC WORKS FOR REPAIRS OR NEW CONSTRUCTION AT THE PUBLIC CURB, GUTTER AND SIDEWALK.
- ALL WORK LOCATED IN WITHIN THE PUBLIC RIGHT-OF-WAY OR WITHIN THE JURISDICTION OF THE UTILITIES AND PUBLIC WORKS DEPARTMENTS SHALL COMPLY WITH THE MOST CURRENT EDITION OF THE ENGINEERING STANDARD SPECIFICATIONS. THE CURRENT ADOPTED STANDARDS ARE DATED JANUARY 2010

PROJECT DATA

ASSESSOR'S PARCEL NUMBER: 053-102-025

LAND USE CATEGORY: RMF (RESIDENTIAL MULTI-FAMILY)

PLANNING AREA: SAN LUIS OBISPO

CBC OCCUPANCY GROUP: R-2 (MULTI-FAMILY) B (COMMON BUILDING)

CBC CONSTRUCTION TYPE: V-B REMODEL

FIRE SPRINKLERED?: NO

PUBLICLY FUNDED?: NO

OVERALL SITE AREA: 305,160 S.F. = 7 ACRES

OCCUPANT LOADS

EXISTING BUILDINGS

COMMON BUILDING = 1800 / 100 = 18 OCCUPANTS

NOTE: ACTIVITY ROOM IS < 750 S.F. AND THEREFORE IS CALCULATED AS GROUP B OCCUPANCY PER CBC 303.1 EXCEPTION 3.

RESIDENTIAL BUILDINGS	19
UNITS	12
COMMON BUILDING	1
LAUNDRY FACILITIES	5
MAINTENANCE SHEDS	2
EXISTING PARKING	
STANDARD SPACES	26
ACCESSIBLE SPACES	<u>2</u>
TOTAL	26

SEE DESCRIPTION OF WORK ON SHEET T2

LEGAL DESCRIPTION

PARCEL 25 IN THE CITY OF SAN LUIS OBISPO, STATE OF CALIFORNIA, ACCORDING TO MAP REVISED OCTOBER 25th, 2001 IN BOOK 053 PAGE 102 OF PARCEL MAPS, IN THE OFFICE OF THE COUNTY RECORDER OF SAID COUNTY.

INDEX

TITLE SHEET SYMBOLS & ABBREVIATIONS **EROSION CONTROL PLAN**

EROSION CONTROL GENERAL NOTES AND DETAILS EROSION CONTROL DETAILS

FRONTAGE IMPROVEMENT PLANS FRONTAGE IMPROVEMENT DETAILS

SITE DEMOLITION PLAN **NEW SITE PLAN** ENLARGED SITE PLAN ENLARGED SITE PLANS **ENLARGED SITE PLANS** SITE SECTIONS SITE DETAILS SITE DETAILS

SITE DETAILS

RESIDENTIAL UNITS / BUILDINGS

UNIT FLOOR PLANS BUILDING FLOOR PLANS 1,2,3,7,17 & 18

BUILDING FLOOR PLANS 4, 5, 6, 9, 10A, 10B, 12, 14 & 15 BUILDING FLOOR PLANS 8, 11, 13, 17

BUILDING ROOF PLAN BUILDING ELEVATIONS

ENLARGED ELEVATIONS ELEVATION DETAILS (BREEZEWAYS)

ELEVATION DETAILS

INTERIOR UNIT MATRIX

EXTERIOR REPAIR MATRIX MANUFACTURER'S DETAILS (LAP SIDING)

MANUFACTURER'S DETAILS (PANEL REVEAL)

MANUFACTURER'S DETAILS (SINGLE-PLY ROOFING) DETAILS (WINDOWS AND TRIM)

COMMON BUILDINGS

DEMOLITION FLOOR PLAN REMODEL FLOOR PLAN ROOF PLAN

REFLECTED CEILING PLAN **EXTERIOR ELEVATIONS BUILDING SECTIONS**

WALL SECTIONS

WALL SECTIONS

INTERIOR ELEVATIONS (PUBLIC RESTROOMS & LAUNDRY) INTERIOR ELEVATIONS (COMMON BUILDING) INTERIOR ELEVATIONS (DWELLING UNITS)

INTERIOR DETAILS (ALUMINUM FRAMES)

DOOR, WINDOW & FINISH SCHEDULES

CASEWORK & FINISH DETAILS

MP1.00 MECH. / PLUMB. SCHEDULES AND DETAILS MECH. / PLUMB. SCHEDULES AND NOTES

MP1.02 MECH. / PLUMB. SCHEDULES AND DETAILS MP2.001 MECH. / PLUMB. BUILDING 1, 2 & 3 FIRST FLOOR PLAN MP2.002 MECH. / PLUMB. BUILDING 4, 5 & 6 FIRST FLOOR PLAN

MP2.003 MECH. / PLUMB. BUILDING 7, 9 & 10A FIRST FLOOR PLAN MP2.004 MECH. / PLUMB. BUILDING 10B, 11 & 12 FIRST FLOOR PLAN

MP2.005 MECH. / PLUMB. BUILDING 13, 14 & 15 FIRST FLOOR PLAN MP2.006 MECH. / PLUMB. BUILDING 16, 17 & 18 FIRST FLOOR PLAN

MP2.007 MECH. / PLUMB. BUILDING 19 FLOOR PLAN MP3.001 MECH. / PLUMB. BUILDING 1, 2 & 3 SECOND FLOOR PLAN

MP3.002 MECH. / PLUMB. BUILDING 4, 5 & 6 SECOND FLOOR PLAN MP3.003 MECH. / PLUMB. BUILDING 7, 9 & 10A SECOND FLOOR PLAN

MP3.004 MECH. / PLUMB. BUILDING 10B, 11 & 12 SECOND FLOOR PLAN MP3.005 MECH. / PLUMB. BUILDING 13, 14 & 15 SECOND FLOOR PLAN MP3.006 MECH. / PLUMB. BUILDING 16, 17 & 18 SECOND FLOOR PLAN

T24.001 ENERGY COMPLIANCE FORMS T24.002 ENERGY COMPLIANCE FORMS

GENERAL NOTES, LEGEND & SINGLE LINE DIAGRAM ELECTRICAL SCHEDULE AND DETAILS

DWELLING UNIT PANEL SCHEDULE OVERALL EXISTING ELECTRICAL SITE PLAN OVERALL NEW ELECTRICAL SITE PLAN COMMON BUILDING ELECTRICAL DEMOLITION PLAN

COMMON BUILDING LIGHTING FLOOR PLAN COMMON BUILDING POWER / SIGNAL FLOOR PLAN ELECTRICAL PLAN AT TYPICAL UNIT

INTERIOR TITLE 24 COMPLIANCE EXTERIOR TITLE 24 COMPLIANCE

TITLE SHEET

AS-BUILT SITE / LANDSCAPE DEMOLITION PLAN

NEW GROUNDWORK PLAN L.2 PLANTING RENOVATION PLAN L.3 IRRIGATION RETROFIT PLAN

LANDSCAPE DETAILS L.5.2 **IRRIGATION DETAILS IRRIGATION DETAILS**

L.6 SPECIFICATIONS

PROJECT DIRECTORY

OWNER / DEVELOPER VITUS GROUP SUITE 2000

FRASER SEIPLE ARCHITECTS 971 OSOS STREET SAN LUIS OBISPO 93401

MECHANICAL ENGINEERS: 444 HIGUERA STREET STE. #201

805.543.6636


THOMA ELECTRIC CO. 3562 EMPLEO STREET 805.543.3850

1418 JOHNSON AVE SAN LUIS OBISPO 93401

805.543.2473

VICINITY MAP



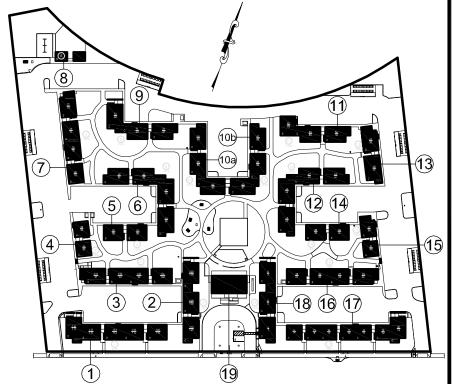

1700 SEVENTH AVENUE SEATTLE, WA 98101


ARCHITECTS:

805 544 6161


BRUMMEL MECHANICAL ENGINEERING SAN LUIS OBISPO 93401

ELECTRICAL ENGINEERS: SAN LUIS OBISPO 93401

LANDSCAPE ARCHITECTS LINDA SHOTWELL LANDSYSTEMS & ASSOCIATES

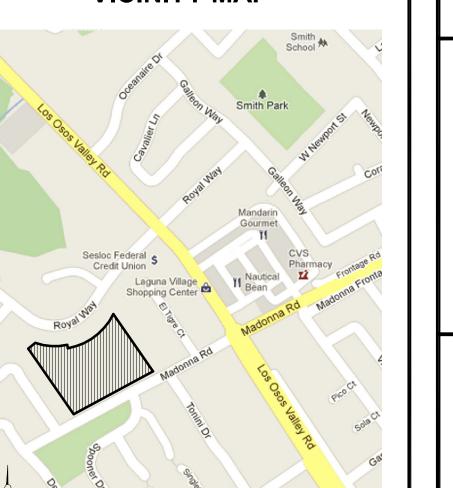

BUILDING KEY PLAN

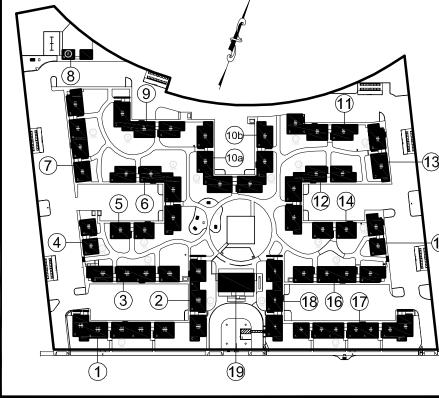

MADONNA ROAD **APARTMENTS**

A RENOVATION AND **UPGRADE PROJECT**

1550 MADONNA ROAD SAN LUIS OBISPO, CA

> ARCHITECT JOB# 1207



971 OSOS STREET SAN LUIS OBISPO CALIFORNIA 93401

805-544-6161

www.fraserseiplearchitects.com

PROJECT MANAGER BDF

DRAWN BY DDL 08-08-2012 1st SUBMITTAL

> 09-19-2012 1st RE-SUBMITTAL 10-05-2012 FOR CONSTRUCTION

The use of these plans and specifications shall be restricted the original site for which they were prepared and publication thereof is expressly limited to such use. Reproduction or publication by any method, in whole or in part, is prohibited Title to these plans and specifications remain with the architect without prejudice. Visual contact with these plans and specifications shall constitute prima facie evidence of e acceptance of these restrictions.

Written dimensions on these drawings shall have precedence over scaled dimensions. Contractors shall verify and be esponsible for all dimensions and existina conditions on the job and shall report any discrepancies to the architect for esolution prior to commencing work.

TITLE

&	AND				
L	ANGLE	GA.	GAUGE	Q.T.	QUARRY TILE
⋒	АТ	GALV.	GALVANIZED		
@	Al	G.B. GL.	GRAB BAR GLASS	(R) R.	REMOVE RADIUS
¢	CENTERLINE	GRD.	GRADE	R.D.	ROOF DRAIN
#	NUMBER OR POUND	GWB GYP.	GYPSUM WALL BOARD GYPSUM	REF. REFR.	REFERENCE REFRIGERATOR
	PARALLEL	GYP.BD.	GYPSUM BOARD	REINF.	REINFORCED
1				REQD. RESIL.	REQUIRED RESILIENT
	PERPENDICULAR	H.B.	HOSE BIBB	RM.	ROOM
	ROUND OR DIAMETER	H.C. HDBD.	HOLLOW CORE HARDBOARD	R.O. R.U.	ROUGH OPENING ROLL-UP
ф	SQUARE	HDWD. HT.	HARDWOOD HEIGHT	RWD. RW.L.	REDWOOD
		H.M.	HOLLOW METAL	TXVV.L.	RAINWATER LEADER
A 0	A CRUM T CONORETE	HNDRL. HOR.	HANDRAIL HORIZONTAL		
A.C. ACBL.	ASPHALT CONCRETE ACCESSIBLE	HR.	HOUR	S.C. SCHED.	SOLID CORE SCHEDULE
A.D. ADJ.	AREA DRAIN ADJUSTABLE	HDWR. H.V.P.	HARDWARE HARDWOOD VENEER PLYWOOD	SCR.	SCREEN
AGGR.	AGGREGATE		1	SECT. SEP.	SECTION SEPARATION OR SEPARATE
APPROX. ARCH.	APPROXIMATE ARCHITECTURE OR	I.D.	INSIDE DIAMETER OR	SERV.	SERVICE
	ARCHITECTURAL	IN.	INSIDE DIMENSION INCH	S.F. SH.	SQUARE FEET SHELF OR SHELVES
ASPH. AUTO.	ASPHALT AUTOMATIC	INFO.	INFORMATION	S.H.	SPRINKLER HEAD
,,,,,,,	/ CTOW/ CTO	INSUL. INT.	INSULATION OR INSULATED INTERIOR	SHR. SHT.	SHOWER SHEET
BD.	BOARD			SIM.	SIMILAR
BITUM. BLDG.	BITUMINOUS BUILDING	LANI CIZ	JANITOR'S SINK	S.J.	SEPARATION JOINT OR SEISMIC JOINT
BLK.	BLOCK	JAN.SK. JT.	JOINT	SK.	SINK
BM. B.O.	BEAM BOTTOM OF			S.M.S. SP.	SHEET METAL SCREW SPACE
ВОТ.	воттом	K.P.	KICKPLATE	SPEC.	SPECIFICATION
BTWN. B.U.W.P.	BETWEEN BUILT-UP WATERPROOFING	K.S.	KNEE SPACE	SPR. SPKR.	SPRINKLER SPEAKER
B.U.R.S.	BUILT-UP BITUMINOUS	L.	LONG OR LENGTH	SQ.	SQUARE
	ROOFING SYSTEM	LAM.	LAMINATE	S.SK. S.S.	SERVICE SINK STAINLESS STEEL
CAB.	CABINET	LAM.PL. LAV.	LAMINATED PLASTIC LAVATORY	S.T.C.	SOUND TRANSMISSION CLASS
C.B. CER.	CATCH BASIN CERAMIC	LB.	POUND	ST. STD.	STORAGE STANDARD
C.I.	CAST IRON	L.C. L.F.	LINEN CHUTE LINEAR FEET	STGD. STL.	STAGGERED
C.J. CLG.	CONTROL JOINT CEILING	LONG.	LONGITUDINAL	STRUCT.	STEEL STRUCTURAL OR STRUCTURE
CLKG.	CAULKING	LT. LT.FXT.	LIGHT LIGHTING FIXTURE	SUSP. SYM.	SUSPENDED SYMMETRICAL
CLR. C.M.U.	CLEAR CONCRETE MASONRY UNIT	2111 / 111	213.11.11.13.1 p.t. 3.1.2	OTW.	3 TWINE TRICAL
C.O.	CASED OPENING	MACH.	MACHINE		
COL. CONC.	COLUMN CONCRETE	MATL. MAX.	MATERIAL MAXIMUM	Т.	TILE
COND. CONST.	CONDUCTIVE CONSTRUCTION OR CONSTRUCT	M.B.	MACHINE BOLT	TEL.	TELEPHONE
CONT.	CONTINUOUS	MED.CAB. MECH.	MEDICINE CABINET MECHANICAL	TEMP. TER.	TEMPERED OR TEMPERATURE TERRAZZO
C.T. CTSK.	CERAMIC TILE COUNTERSINK	MEMB.	MEMBRANE	TEMP.GL.	TEMPERED GLASS
CTR.	CENTER	MFR. MH.	MANUFACTURER MANHOLE	T.& B. T.& G.	TOP AND BOTTOM TONGUE AND GROOVE
		MIN.	MINIMUM MIRROR	THERM.	THERMAL
DBL. DET.	DOUBLE DETAIL	MIR. MISC.	MISCELLANEOUS	TH. THRES.	THICK THRESHOLD
D.F.	DOUGLAS FIR	MET.L. MOD.	METAL LATH MODULAR	THRU TOIL.	THROUGH
DIA. DIAG.	DIAMETER DIAGONAL	MTD.	MOUNTED	T.O.	TOILET TOP OF
DIM.	DIMENSION	MTG. MTL.	MOUNTING METAL	T.O.C. T.O.P.	TOP OF CONCRETE TOP OF PARAPET
DN. DR.	DOWN DOOR	MUL.	MULLION	T.O.R.W.	TOP OF FARAPET TOP OF RETAINING WALL
DS.	DOWNSPOUT			T.O.S. T.O.ST.	TOP OF SLAB TOP OF STEEL
DW. DWG.	DISHWASHER DRAWING	(N)	NEW	T.O.W.	TOP OF WALL
		N.I.C.	NOT IN CONTRACT	TRD.	TREAD
(E)	EXISTING	NO. NOM.	NUMBER NOMINAL	TV. TYP.	TELEVISION TYPICAL
EA. E.F.	EACH EXHAUST FAN	N.T.S.	NOT TO SCALE		
E.J.	EXPANSION JOINT	~ :	0.755	U.C.	UNDER COUNTER
EL. ELEC.	ELEVATION ELECTRICAL	OA. OBS.	OVERALL OBSCURE	UNEXC. UNF.	UNEXCAVATED UNFINISHED
ELEV.	ELECTRICAL ELEVATOR OR ELEVATION	O.C.	ON CENTER	U.N.O.	UNLESS NOTED OTHERWISE
EQ. EQUIP.	EQUAL EQUIPMENT	O.D. O.D.	OUTSIDE DIAMETER OVERFLOW DRAIN		
EXP.	EXPANSION	OPG.	OPENING	V.B.	VAPOR BARRIER
EXT.	EXTERIOR	OPP.	OPPOSITE	V.C.T. VEN.	VINYL COMPOSITION TILE VENEER
E D	ELOOP DRAIN	PART.	PARTIAL	VERT.	VERTICAL
F.D. FDN.	FLOOR DRAIN FOUNDATION	PARTN.	PARTITION	VRFY. V.G.	VERIFY VERTICAL GRAIN
F.F.	FINISH FLOOR	PAV. P.C.	PAVING OR PAVEMENT PORTLAND CEMENT	V.PLAS.	VENEER PLASTER
F.H. FIN.	FIRE HYDRANT FINISH	P.D.F.	POWDER DRIVEN FASTENER	V.W.C.	VINYL WALL COVERING
FL.	FLOOR	PERF. PL.	PERFORATE, PERFORATED PLATE		NA/IT! I
FLASH. FLUOR.	FLASHING FLUORESCENT	P.L.	PROPERTY LINE	W/ W.GL.	WITH WIRE GLASS
F.O.	FACE OF FACE OF CONCRETE	PLAS. PLBG.	PLASTER PLUMBING	WD.	WOOD
F.O.C. F.O.F.	FACE OF FINISH	P.L.F.	PER LINEAL FOOT	WNDW. W/O.	WINDOW WITHOUT
F.O.P.	FACE OF PARTITION FACE OF STUDS	PLYWD. PORT.	PLYWOOD PORTABLE	W.O.	WHERE OCCURS
F.O.S. F.O.W.	FACE OF WALL	P.P.	POWER POLE	WP. W.R.	WATERPROOF OR WORKPOINT WATER RESISTANT
FP. FRZR.	FIREPROOF(ING) FREEZER	PR. PROJ.	PAIR PROJECTION	WSCT.	WAINSCOT
F.S.	FULL SIZE OR FLOOR SINK	PREFAB.	PREFABRICATED	WT.	WEIGHT
FT. FTG.	FOOT, FEET FOOTING	P.S.F. P.S.I.	PER SQUARE FOOT PER SQUARE INCH		
FURR.	FURRING	PT.	POINT		

DESCRIPTION OF WORK

I. COMMON AREAS

- A. PARKING AND DRIVEWAY IMPROVEMENTS TO REPAIR DAMAGE AND MEET ACCESSIBLE PARKING STANDARDS.
- B. STREET FRONTAGE IMPROVEMENTS TO MEET CITY ENGINEERING STANDARDS. C. SITE WALKWAY IMPROVEMENTS TO REPAIR DAMAGE AND MEET ACCESSIBLE PATH OF TRAVEL STANDARDS.
- D. OUTDOOR ACTIVITY AREA AND SITE FURNISHING IMPROVEMENTS.
- E. LANDSCAPE IRRIGATION IMPROVEMENTS TO ACCESS SEPARATELY METERED RECYCLED WATER.
- F. TURF REMOVAL AND LANDSCAPE PLANTING IMPROVEMENTS.
- G. TREE PRUNING AND REMOVAL AS REQUIRED. H. EXTERIOR LIGHT FIXTURE REPLACEMENT.

II. APARTMENT INTERIORS, TYICAL

- A. INTERIOR FLOORING AND FINISH REPLACEMENT AS REQUIRED.
- B. KITCHEN AND BATHROOM CABINET REPLACEMENT.
- C. PLUMBING FIXTURE REPLACEMENT AS REQUIRED. D. APPLIANCE REPLACEMENT AS REQUIRED.
- E. DOOR REPLACEMENT AS REQUIRED.
- F. GENERAL FINISH REPAIR AND PAINTING.
- G. COMPLYING SMOKE DETECTOR INSTALLATION.
- H. CARBON MONOXIDE DETECTOR INSTALLATION.
- I. COMPLYING GFCI OUTLET INSTALLATION. J. WALL FURNACE REPLACEMENT AS REQUIRED.
- K. WALL HEATER REPLACEMENT AS REQUIRED.

III. APARTMENT BUILDING EXTERIORS, TYPICAL


- A. ROOFING REPAIR OR REPLACEMENT AS REQUIRED.
- B. PLYWOOD SIDING REPLACEMENT WITH CEMENT BOARD SIDING.
- C. WOOD TRIM REPLACEMENT WITH COMPOSITE TRIM. D. PLASTER REPAIR AND REFINISHING AS REQUIRED.
- E. ALUMINUM WINDOW REPLACEMENT WITH VINYL WINDOWS.
- F. ABOVE-GRADE TRAFFIC TOPPING REPLACEMENT.
- G. ADDITIONAL STAIR HANDRAIL INSTALLATION.
- H. LIGHT FIXTURE REPLACEMENT.

- A. ROOFING REPLACEMENT
- PLYWOOD SIDING REPLACEMENT WITH CEMENT BOARD SIDING.
- C. WOOD TRIM REPLACEMENT WITH COMPOSITE TRIM.
- D. PLASTER REPAIR AND REFINISHING AS REQUIRED.
- E. ALUMINUM WINDOW REPLACEMENT WITH VINYL WINDOWS. F. INTERIOR REMODELING FOR RESTROOM, CIRCULATION ACCESSIBILITY.
- G. FLOORING AND FINISH REPLACEMENT.
- H. PLUMBING FIXTURE REPLACEMENT. I. LIGHT FIXTURE REPLACEMENT.
- J. CASEWORK REPLACEMENT.

BUILDING LIST

IV. COMMON BUILDINGS

BUILDING 1 (1592 MADONNA ROAD): 2 STORIES; 10 APARTMENTS; 8,544 SQ. FT. BUILDING 2 (1588 MADONNA ROAD): 2 STORIES; 6 APARTMENTS; 5,976 SQ. FT. BUILDING 3 (1586 MADONNA ROAD): 2 STORIES; 8 APARTMENTS; 6,732 SQ. FT. BUILDING 4 (1584 MADONNA ROAD): 2 STORIES; 4 APARTMENTS; 2,500 SQ. FT. BUILDING 5 (1582 MADONNA ROAD): 2 STORIES; 4 APARTMENTS; 3,276 SQ. FT. BUILDING 6 (1578 MADONNA ROAD): 2 STORIES; 8 APARTMENTS; 8,548 SQ. FT. BUILDING 7 (1576 MADONNA ROAD): 2 STORIES; 8 APARTMENTS; 6,732 SQ. FT. BUILDING 8 (MAINTENANCE): 1 STORY; 300 SQ. FT. BUILDING 9 (1574 MADONNA ROAD); 2 STORIES; 6 APARTMENTS; 6,266 SQ, FT. BUILDING 10A/10B (1572 MADONNA ROAD): 2 STORIES; 12 APARTMENTS; 12,532 SQ. FT. BUILDING 11 (1568 MADONNA ROAD): 2 STORIES; 6 APARTMENTS; 5,622 SQ. FT. BUILDING 12 (1564 MADONNA ROAD): 2 STORIES; 8 APARTMENTS; 8,548 SQ. FT. BUILDING 13 (1566 MADONNA ROAD): 2 STORIES; 4 APARTMENTS; 4,100 SQ. FT. BUILDING 14 (1562 MADONNA ROAD): 2 STORIES; 4 APARTMENTS; 3,276 SQ. FT. BUILDING 15 (1558 MADONNA ROAD): 2 STORIES; 4 APARTMENTS; 2,680 SQ. FT. BUILDING 16 (1556 MADONNA ROAD): 2 STORIES; 8 APARTMENTS; 6,732 SQ. FT. BUILDING 17 (1552 MADONNA ROAD): 2 STORIES; 14 APARTMENTS; 9,492 SQ. FT. BUILDING 18 (1554 MADONNA ROAD); 2 STORIES; 6 APARTMENTS; 5,976 SQ, FT.

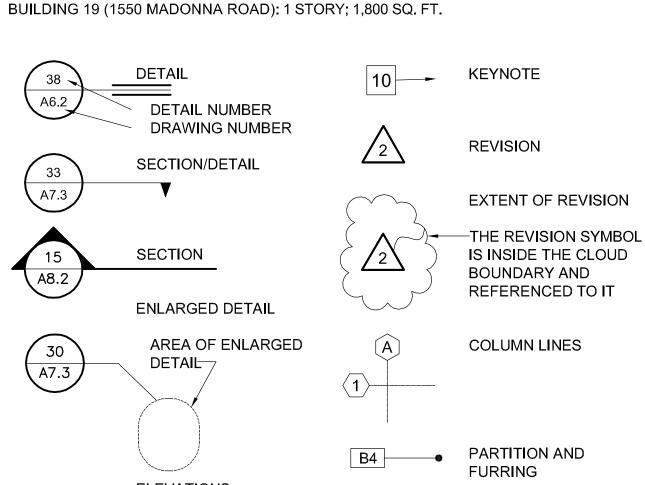

ELEVATIONS DIRECTION OF VIEW (ELEVATION INDICATES NORTH, EAST, SOUTH, OR

MATCH LINE

SYMBOL IS DRAWING OPPOSITE THE DRAWING SIDE OF THE MATCH LINE (TYPICAL)

SHEET#

PROJECT

CLIENT JOB#

ARCHITECTS

PROJECT MANAGER BDF

DRAWN BY DDL

SIGNED

MADONNA

ROAD

APARTMENTS

A RENOVATION AND

UPGRADE PROJECT

1550 MADONNA ROAD

SAN LUIS OBISPO, CA

ARCHITECT JOB#

1207

971 OSOS STREET

CALIFORNIA 93401

www.fraserseiplearchitects.com

08-08-2012 1st SUBMITTAL

09-19-2012 1st RE-SUBMITTAL

10-05-2012 FOR CONSTRUCTION

SAN LUIS OBISPO

805-544-6161

The use of these plans and specifications shall be restricted the original site for which they were prepared and publication thereof is expressly limited to such use. Reproduction or

publication by any method, in whole or in part, is prohibited. Title to these plans and specifications remain with the architect without prejudice. Visual contact with these plans

and specifications shall constitute prima facie evidence of

Written dimensions on these drawings shall have precedence over scaled dimensions. Contractors shall verify and be

responsible for all dimensions and existing conditions on the

job and shall report any discrepancies to the architect for resolution prior to commencing work.

ABBREVIATIONS

the acceptance of these restrictions.

SYMBOLS &

SHEET TITLE

NO SCALE

FUTURE

ARCHITECTURAL ABBREVIATIONS


PTN.

PARTITION

D010006B

REFERENCE SYMBOLS

D010005A

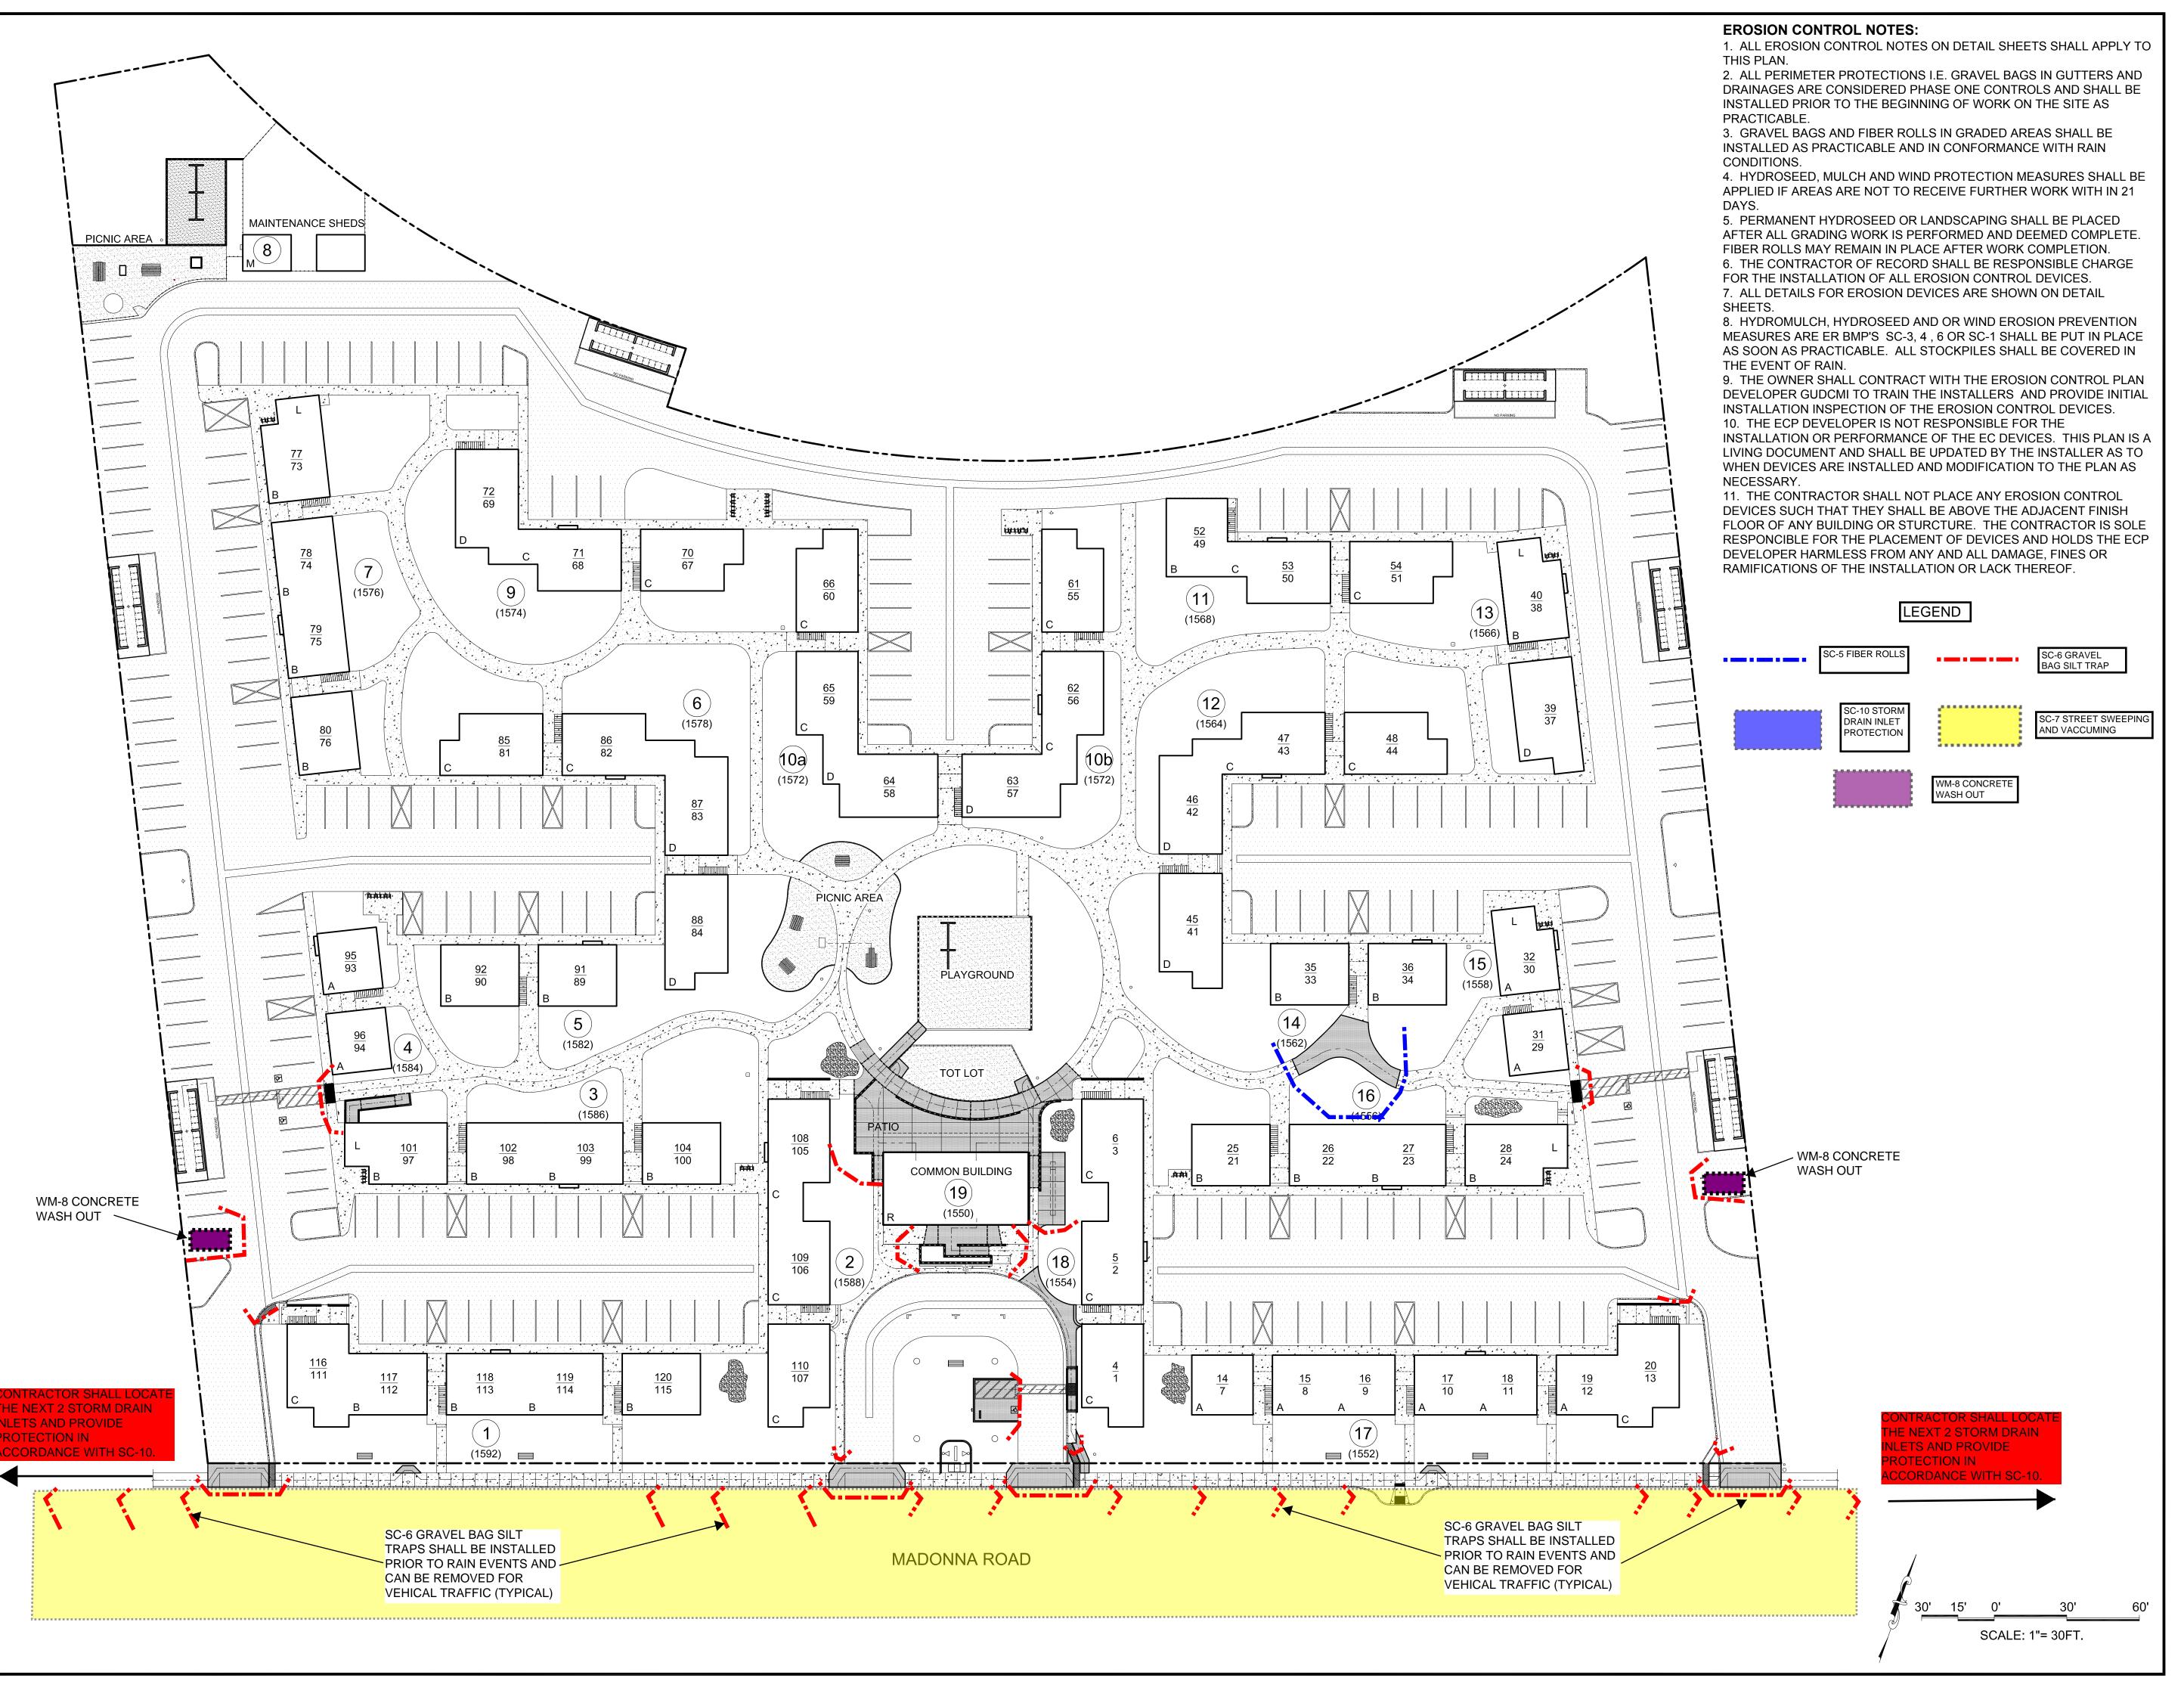

MADONNA ROAD APARTMENTS

A RENOVATION AND **UPGRADE PROJECT**

1550 MADONNA ROAD SAN LUIS OBISPO, CA

CLIENT JOB#

ARCHITECT JOB# 1207



971 OSOS STREET SAN LUIS OBISPO CALIFORNIA 93401

805-544-6161

www.fraserseiplearchitects.com




Robert W. Carnes Certified Professional in Erosion and Sediment Control

PROJECT MANAGER BDF

DRAWN BY DDL

08 - 08 - 2012 09 - 19 - 2012 1st RE-SUB

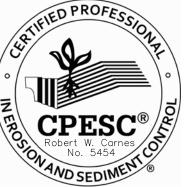

The use of these plans and specifications shall be restricted the original site for which they were prepared and publication thereof is expressly limited to such use. Reproduction or publication by any method, in whole or in part, is prohibited. Title to these plans and specifications remain with the architect without prejudice. Visual contact with these plans and specifications shall constitute prima facie evidence of ne acceptance of these restrictions.

over scaled dimensions. Contractors shall verify and be responsible for all dimensions and existing conditions on the job and shall report any discrepancies to the architect for resolution prior to commencing work.

Written dimensions on these drawings shall have precedence

SHEET TITLE

EROSION CONTROL PLAN

SCALE: 1" = 30'=0"

GENERAL EROSION NOTES:

1. PROHIBITION OF MOST NON-STORM WATER DISCHARGES

ONLY STORM WATER FROM THE PROJECT SITE SHALL BE ALLOWED TO FLOW INTO THE PUBLIC STREET SYSTEM. CLEAN, NON-CHLORINATED WATER FROM THE FLUSHING OF FIRE HYDRANTS, WATER MAINS, AND STORM DRAINS MAY BE DISCHARGED TO THE STREET IF IT IS NOT ALLOWED TO COLLECT DIRT. DEBRIS AND TRASH WHILE FLOWING TO THE STREET.

2. SOURCES OF STORM WATER POLLUTANTS

STORM WATER POLLUTANTS INCLUDE SOIL SEDIMENT AND NUTRIENTS, OIL, GREASE, TOXIC POLLUTANTS, HEAVY METALS, PAINT, AND STUCCO. SOURCES OF STORM WATER POLLUTANTS INCLUDE SOIL EROSION BY WATER AND/OR WIND; CLEARING OF VEGETATION; GRADING; VEHICLE AND EQUIPMENT REFUELING AND MAINTENANCE; WASHING OF CONCRETE TRUCKS, MIXERS AND HANDLING REQUIREMENT: PAINTS, SOLVENTS, ADHESIVES: LANDSCAPING WORK: ROOFING AND BUILDING MATERIALS; AND PETROLEUM PRODUCTS.

3. EROSION AND SEDIMENT CONTROLS

A. COVER EXPOSED STOCKPILES OF SOILS, CONSTRUCTION MATERIALS, AND LANDSCAPING MATERIALS WITH HEAVY PLASTIC SHEETING.

B. IN LANDSCAPING AREAS WHERE THE VEGETATION HAS NOT ESTABLISHED GROWTH AND TAKEN HOLD, CONSTRUCT SANDBAG OR DIRT BERM'S OR SILT FENCES AROUND THEIR PERIMETER TO INSURE THAT WATER WILL BE CONTAINED INSIDE THE LANDSCAPING AREA AND THAT IT WILL NOT BE CONVEYED TO A STORM DRAIN INLET.

- C. RE-VEGETATE AREAS WHERE LANDSCAPING HAS DIED OR NOT TAKEN HOLD.
- D. DIVERT STORM WATER RUNOFF AROUND DISTURBED SOILS WITH BERM'S OR DIRT SWALES.

4. OTHER CONTROLS

A. WASTE DISPOSAL

1. KEEP SOLID WASTE DISPOSAL CONTAINERS COVERED TO PREVENT ENTRY OF STORM WATER.

2. PROVIDE FOR THE WEEKLY (OR MORE FREQUENT, AS NECESSARY) DISPOSAL OF WASTE CONTAINERS.

3. PROVIDE CONTAINERS AT CONVENIENT LOCATIONS AROUND THE SITE.

B. SWEEPING OF SITE

1. PROVIDE WEEKLY (OR MORE FREQUENT, AS NECESSARY) SWEEPING BY HAND OR MECHANICAL MEANS TO KEEP THE PAVED AREAS OF THE SITE FREE OF DUST, DIRT, AND DEBRIS.

2. DISPOSE OF ACCUMULATED DIRT IN WASTE CONTAINERS, OR HAUL IT OFF THE SITE TO A LANDFILL.

C. SANITARY SEPTIC DISPOSAL

PORTABLE TOILETS AND OTHER SANITARY FACILITIES SHALL BE SERVICED WEEKLY (OR MORE FREQUENT, AS NECESSARY) AND PUMPED CLEAN BY A WASTE DISPOSAL COMPANY. NO TOXIC OR HAZARDOUS WASTES SHALL BE DISPOSED OF IN A PORTABLE TOILET OR IN THE ON-SITE SANITARY SEWER.

D. SPILLS

1. STORE ADEQUATE ABSORBENT MATERIAL, RAGS, BROOMS, SHOVELS, AND WASTE CONTAINERS ON THE SITE TO CLEAN-UP SPILLS OR MATERIALS SUCH AS FUEL, PAINT SOLVENTS, OR CLEANERS. CLEAN UP MINOR SPILLS

2. FOR REPORTABLE QUANTITIES OF A HAZARDOUS OR TOXIC SUBSTANCES, SECURE THE SERVICES OF QUALIFIED PERSONNEL FOR CLEAN-UP AND DISPOSAL.

E. CONTROL OF ALLOWABLE NON-STORM WATER DISCHARGES

LANDSCAPING IRRIGATION, EROSION CONTROL MEASURES, PIPE FLUSHING AND TESTING PAVEMENT WASHING, AND DE-WATERING ARE ALLOWED IF THEY CANNOT FEASIBLY BE ELIMINATED, COMPLY WITH THIS PLAN, DO NOT CAUSE OR CONTRIBUTE TO A VIOLATION OF WATER QUALITY STANDARDS. AND ARE NOT REQUIRED TO BE PERMITTED BY THE LOCAL REGIONAL WATER QUALITY CONTROL BOARD.

F. VEHICLES AND EQUIPMENT

1. FIX LEAKS OF FUEL, OIL, AND OTHER SUBSTANCES IMMEDIATELY.

2. PERFORM REFUELING AND SERVICE OF VEHICLES OR EQUIPMENT OFF-SITE WHEN POSSIBLE. IF REFUELING OR SERVICE OF EQUIPMENT IS PERFORMED ON-SITE, THEN PROVIDE AN IMPERVIOUS, CONTAINED AREA WHERE ANY SPILLS CAN BE CONTAINED WITHOUT FLOWING TO A STORM WATER INLET OR INTO THE GROUND.

3. USE DRIP PANS TO CATCH LEAKS AND SMALL SPILLS.

G. CONCRETE TRUCKS, MIXERS, AND HAULING EQUIPMENT

1. DISPOSE OF WASHOUT FROM THE WASHING OF CONCRETE TRUCKS AT ASSIGNED WASHOUT AREAS.

2. PROVIDE A HOLDING TANK TO RECEIVE ANY WASHOUT FROM CONCRETE EQUIPMENT. DISPOSAL OF TANK CONTENTS SHOULD BE CONDUCTED BY A WASTE HAULING FIRM.

3. PROVIDE A DESIGNATED AREA FOR WASHING ANY VEHICLES OR EQUIPMENT; DRAINAGE FROM THIS AREA SHOULD FLOW TO THE HOLDING TANK.

H. LANDSCAPING OPERATIONS

1. USE ONLY THE MINIMUM AMOUNT OF LANDSCAPING FERTILIZERS, NUTRIENTS, AND OTHER CHEMICALS THAT ARE

2. DO NO OVER WATER FERTILIZED OR TREATED LANDSCAPE AREAS, MINIMIZE RUNOFF OF IRRIGATION WATER FROM

I. STORM WATER INLETS

KEEP ALL ON-SITE STORM WATER INLETS CLEAN AND FREE OF DIRT, SILT, AND DEBRIS, ETC. IN THE EVENT THAT SEDIMENT AND DEBRIS MAY FLOW TO AN INLET, PROVIDE A 6-INCH (MINIMUM) SANDBAG BERM AROUND THE INLET TO TRAP THE DIRT AND DEBRIS AND ALLOW ONLY CLEAN STORM WATER TO ENTER THE INLET (EROSION CONTROL PLAN).

5. INSPECTION BY CONTRACTOR & ENGINEER OF RECORD

A. REGULAR INTERVAL INSPECTION AND INSPECTION BEFORE AND AFTER STORM

1. VISUALLY INSPECT THE SITE WEEKLY TO INSURE THAT STORM WATER INLETS ARE FREE OF DIRT AND DEBRIS.

2. BEFORE A STORM, INSPECT THE SITE TO INSURE THAT STORM WATER POLLUTION CONTROL MEASURES ARE IN PLACE.

3. AFTER A STORM, INSPECT ALL STORM WATER INLETS TO INSURE THAT THEY ARE CLEAR OF DIRT AND DEBRIS. CLEAN THOSE STORM WATER INLETS THAT ARE NOT CLEAR AND FREE OF DEBRIS.

4. THE REGIONAL WATER BOARD MAY REQUIRE THE DISCHARGER TO CONDUCT ADDITIONAL SITE INSPECTIONS, SUBMIT REPORTS AND CERTIFICATIONS, OR TO PERFORM SAMPLING AND ANALYSIS.

5. THE DISCHARGER (PERMITTEE) IS REQUIRED TO CONDUCT INSPECTION OF THE CONSTRUCTION SITE PRIOR TO ANTICIPATED STORM EVENTS AND AFTER ACTUAL STORM EVENTS TO IDENTIFY AREAS CONTRIBUTING TO A STORM WATER DISCHARGE AND TO EVALUATE WHETHER MEASURES TO REDUCE POLLUTANT LOADINGS IDENTIFIED IN THE SWPPP ARE ADEQUATE AND PROPERLY IMPLEMENTED IN ACCORDANCE WITH THE TERMS OF THE GENERAL PERMIT AND WHETHER ADDITIONAL CONTROL PRACTICES ARE NEEDED.

GENERAL EROSION NOTES: (CONTINUED)

6. MAINTENANCE OF CONTROLS

A. MAINTENANCE AND REPAIR

ALL CONTROLS AND MEASURES INDICATED ON THIS PLAN SHOULD BE MAINTAINED IN GOOD AND EFFECTIVE CONDITION BY THE CONTRACTOR. IF ANY CONTROL OF MEASURES ARE DAMAGED OR REMOVED, THEY SHOULD BE PROMPTLY REPAIRED OR RESTORED.

B. PLAN REVISIONS IF CONSTRUCTION ACTIVITY OR CONDITIONS CHANGE FROM THOSE SHOWN IN THIS PLAN THEN THIS PLAN SHOULD BE REVISED TO REFLECT THE CURRENT CONDITIONS.

7. FINAL STABILIZATION AND POST-CONSTRUCTION CONTROLS

A. AFTER CONSTRUCTION HAS BEEN COMPLETED, THE SITE SHALL BE SWEPT CLEAN, STORM WATER INLETS (GRATES AND BASIN) SHALL BE CLEANED, AND ALL WASTE AND LEFTOVER MATERIALS SHALL BE REMOVED FROM THE SITE.

B. ALL LANDSCAPING AND PLANTING AREAS SHOULD BE WELL MAINTAINED TO PREVENT EROSION. AVOID OVER-WATERING OF LANDSCAPING.

C. ALL PAVED AREAS SHOULD BE SWEPT WEEKLY EITHER BY HAND OR BY MECHANICAL MEANS TO KEEP THE SITE CLEAR OF DIRT, DUST, AND DEBRIS D. WASTE MATERIALS ON-SITE SHOULD BE STORED IN COVERED CONTAINERS WHICH ARE CLEANED OUT

REGULARLY. E. TESTING OF FIRE HYDRANTS ON-SITE SHALL NOT BE CONDUCTED UNTIL THE AREA WHERE THE WATER

DISCHARGES HAS BEEN SWEPT CLEAN OF DIRT AND DEBRIS. F. STORM DRAIN LINES SHOULD BE CHECKED AND CLEANED ANNUALLY TO KEEP THEM CLEAN AND CLEAR OF

G. ALL ON-SITE STORM WATER INLETS SHOULD BE CLEARLY MARKED WITH 4" BLUE LETTERS ON WHITE FIELD "STORM WATER ONLY, THIS DRAINS TO THE OCEAN".

ROADWAY

STRAW BALES, SWDBAGS,

EQUIVALENT HEIGHT

SUPPLY WATER TO WASH

WHEELS IF NECESSARY

TRACKING O

. WHEN

OR CONTINUOUS BERM OF

SECTION A - A

SION RIDGE

CESSARY, WHEELS SHALL BE RIOR TO ENTRANCE ONTO PUBLIC

STABILIZED CONSTRUCTION ENTRANCE

N WASHING IS REQUIRED, IT SHALL BE ON AN AREA STABILIZED WITH CRUSHED THAT DRAINS INTO AN APPROVED

MENT TRAP OR SEDIMENT BASIN.

(15m)

PLAN

ICL SHALL BE MAINTAINED IN A CONDITION THAT WILL PREVENT LOWING OF SEDIMENT ONTO PUBLIC RIGHT—OF—WAYS. THIS MAY DRESSING, REPAIR AND/OR CLEAN OUT OF ANY MEASURES USED

SPILLWAY

8. ALL CONSTRUCTION ACTIVITIES INCLUDING GRADING, VEGETATION REMOVAL, STOCKPILING, EQUIPMENT STORAGE ETC. SHALL REMAIN OUTSIDE OF THE 20-FOOT CREEK SETBACK LINE AT ALL TIMES UNLESS AN EXCEPTION FOR SUCH CONSTRUCTION HAS BEEN APPROVED BY THE COMMUNITY DEVELOPMENT DEPARTMENT. THE CREEK SETBACK LINE SHALL BE ESTABLISHED BY THE CITY'S NATURAL RESOURCE MANAGER AND MARKED IN THE FIELD. THE SETBACK AREA SHALL BE FENCED WITH ORANGE CONSTRUCTION FENCING, AND SHALL BE IN PLACE PRIOR TO THE BEGINNING OF CONSTRUCTION AND THROUGHOUT THE DURATION OF CONSTRUCTION.

2% OR GREATER

S. STRAW BALES

APPROVED METHODS


TO CHANNELIZE RUNOFF TO


TEMPORARY

GRAVEL


CONSTRUCTION


ENTRANCE/EXIT

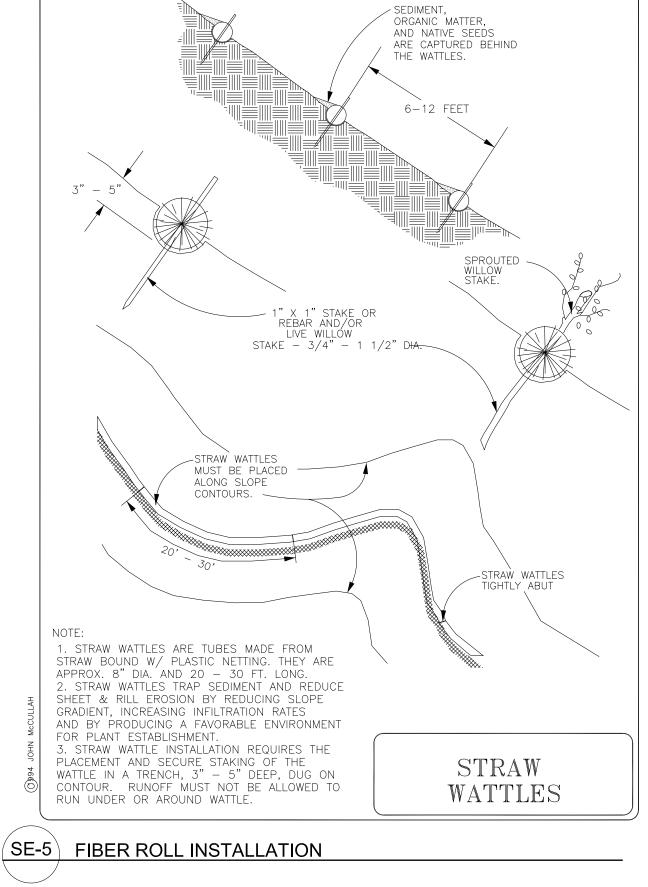

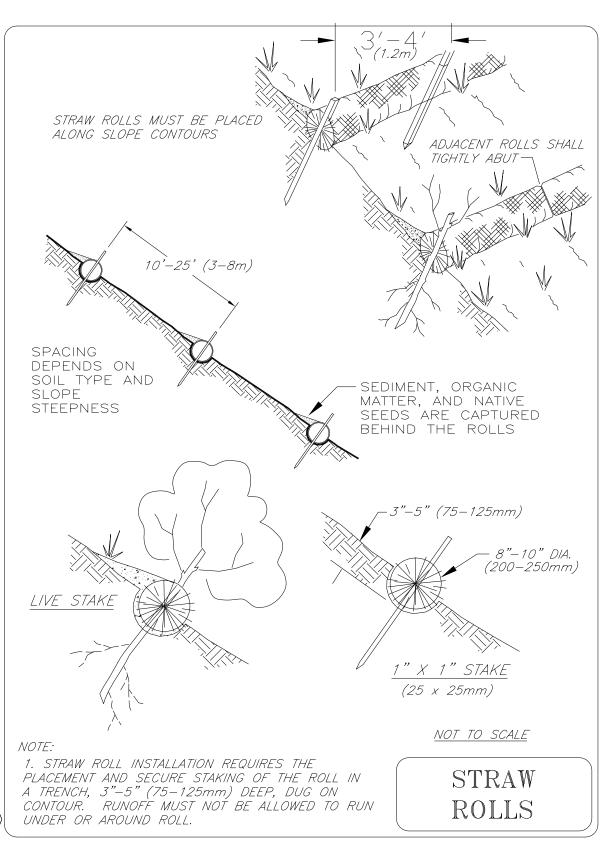

(SE-5) FIBER ROLL INSTALLATION

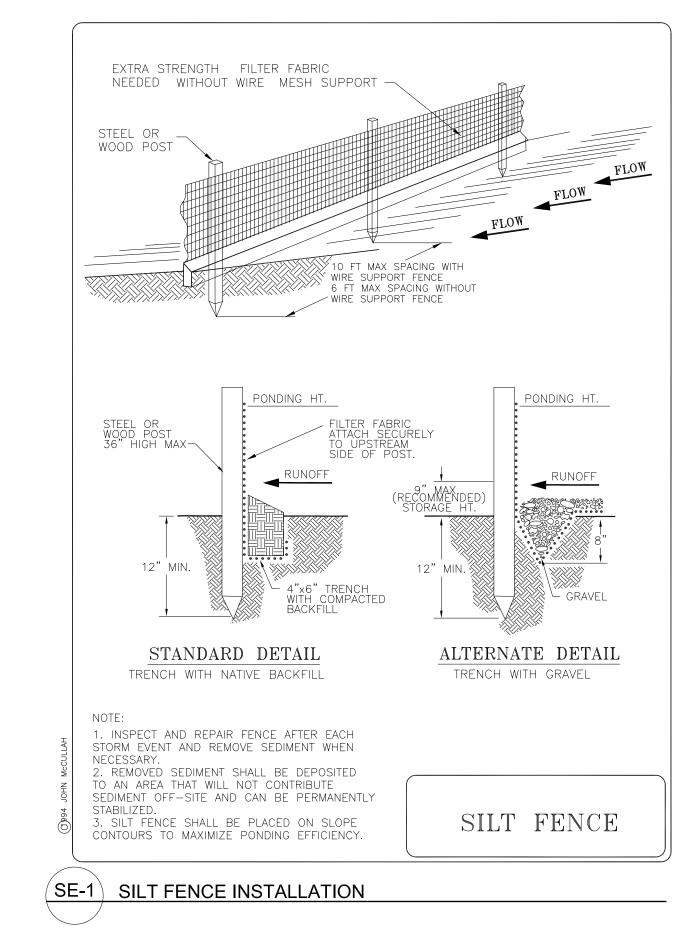

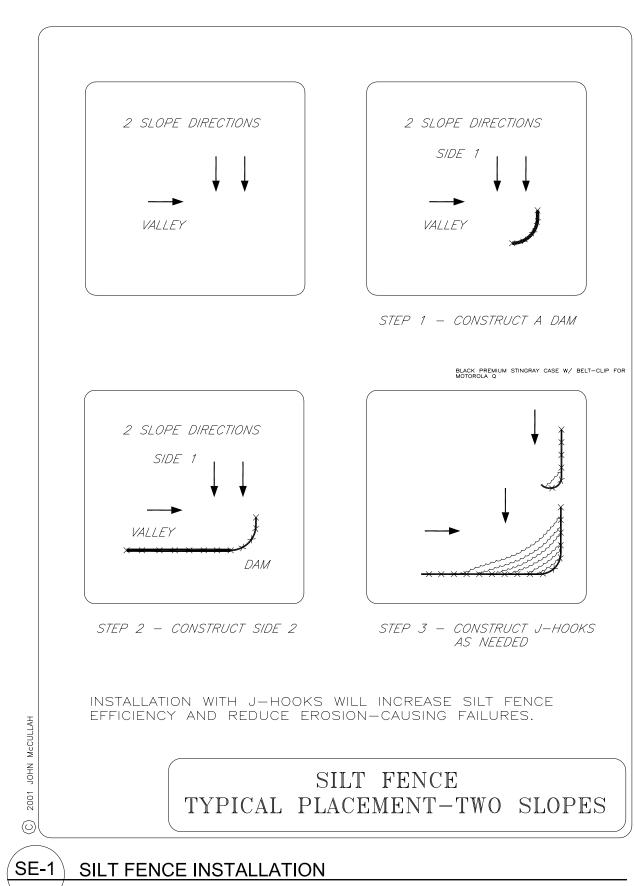

PROJECT

MADONNA ROAD **APARTMENTS**

A RENOVATION AND **UPGRADE PROJECT**

1550 MADONNA ROAD SAN LUIS OBISPO, CA

CLIENT JOB#

ARCHITECT JOB# 1207



971 OSOS STREET SAN LUIS OBISPO CALIFORNIA 93401

805-544-6161

www.fraserseiplearchitects.com



Robert W. Carnes Certified Professional in Erosion and Sediment Control

PROJECT MANAGER BDF

DRAWN BY DDL

08 - 08 - 2012 09 - 19 - 2012 1st RE-SUB

ED PROFESO

The use of these plans and specifications shall be restricted the original site for which they were prepared and publication thereof is expressly limited to such use. Reproduction or publication by any method, in whole or in part, is prohibited. Title to these plans and specifications remain with the architect without prejudice. Visual contact with these plans and specifications shall constitute prima facie evidence of ne acceptance of these restrictions.

Written dimensions on these drawings shall have precedence over scaled dimensions. Contractors shall verify and be responsible for all dimensions and existing conditions on the job and shall report any discrepancies to the architect for esolution prior to commencing work.

SHEET TITLE

EROSION CONTROL **GENERAL NOTES** AND DETAILS

Concrete Waste Management CONCRETE WASHOUT

WM-8

Targeted Constituents

Potential Alternatives

Bacteria

Oil and Grease

Objectives EC Erosion Control SE Sediment Control TC Tracking Control WE Wind Erosion Control NS Non-Stormwater Management Control WM Waste Management and Materials Pollution Control ☑ Primary Objective ▼ Secondary Objective

Description and Purpose

Prevent or reduce the discharge of pollutants to stormwater from concrete waste by conducting washout offsite, performing onsite washout in a designated area, and training employee and subcontractors.

Suitable Applications

Concrete waste management procedures and practices are implemented on construction projects where:

- Concrete is used as a construction material or where concrete dust and debris result form demolition activities
- Slurries containing portland cement concrete (PCC) or asphalt concrete (AC) are generated, such as from saw cutting, coring, grinding, grooving, and hydro-concrete
- Concrete trucks and other concrete-coated equipment are washed onsite
- Mortar-mixing stations exist
- See also NS-8, Vehicle and Equipment Cleaning

Limitations

Offsite washout of concrete wastes may not always be possible.



WM-3

Objectives

EC Erosion Control

SE Sediment Control

Tracking Control

Wind Erosion Control

Management Control

Waste Management and

Materials Pollution Control

Non-Stormwater

✓ Primary Objective

✓ Secondary Objective

Targeted Constituents

Potential Alternatives

Nutrients

Oil and Grease

www.cabmphandbooks.com

(WM-8) CONCRETE WASTE MANAGEMENT

Stockpile Management



Description and Purpose

Stockpile Management procedures and practices are designed to reduce or eliminate air and stormwater pollution from stockpiles of soil, paving materials such as portland cement concrete (PCC) rubble, asphalt concrete (AC), asphalt concrete rubble, aggregate base, aggregate sub base or pre-mixed aggregate, asphalt minder (so called "cold mix" asphalt), and pressure treated wood.

Suitable Applications

Implement in all projects that stockpile soil and other materials.

Limitations None identified.

Implementation

Protection of stockpiles is a year-round requirement. To properly manage stockpiles:

- Locate stockpiles a minimum of 50 ft away from concentrated flows of stormwater, drainage courses, and
- Protect all stockpiles from stormwater runon using a temporary perimeter sediment barrier such as berms, dikes, fiber rolls, silt fences, sandbag, gravel bags, or straw bale



WM-3 STOCKPILE MANAGEMENT

California Stormwater BMP Handbook Construction

www.cabmphandbooks.com

Gravel bag berms may be suitable: As a linear sediment control measure:

Suitable Applications

slowly as sheet flows, preventing erosion.

Description and Purpose

Gravel Bag Berm

- Below the toe of slopes and erodible slopes As sediment traps at culvert/pipe outlets
- Below other small cleared areas
- Along the perimeter of a site
- Down slope of exposed soil areas
- Around temporary stockpiles and spoil areas
- Parallel to a roadway to keep sediment off paved areas

A gravel bag berm is a series of gravel-filled bags placed on a

level contour to intercept sheet flows. Gravel bags pond sheet

flow runoff, allowing sediment to settle out, and release runoff

- Along streams and channels
- As linear erosion control measure:



SE-7

EC Erosion Control

SE Sediment Control

WE Wind Erosion Control

Non-Stormwater

☑ Primary Objective

■ Secondary Objective

Targeted Constituents

Potential Alternatives

Oil and Grease

Management Control

Waste Management and Materials Pollution Control

SE-6

EC Erosion Control

SE Sediment Control

TR Tracking Control

WE Wind Erosion Control

Non-Stormwater Management Control

☑ Primary Objective

★ Secondary Objective

■ Control

■ Co

Waste Management and Materials Pollution Control

Targeted Constituents

Potential Alternatives

Sediment

Nutrients

Bacteria

Organics

Oil and Grease

SE-1 Silt Fence

SE-5 Fiber Roll

SE-8 Sandbag Barrier

SE-9 Straw Bale Barrier

www.cabmphandbooks.com

GRAVEL BAG INSTALLATION

Street Sweeping and Vacuuming



Description and Purpose

Street sweeping and vacuuming includes use of self-propelled and walk-behind equipment to remove sediment from streets and roadways, and to clean paved surfaces in preparation for final paving. Sweeping and vacuuming prevents sediment from the project site from entering storm drains or receiving waters.

Suitable Applications

Sweeping and vacuuming are suitable anywhere sediment is tracked from the project site onto public or private paved streets and roads, typically at points of egress. Sweeping and vacuuming are also applicable during preparation of paved surfaces for final paving.

Sweeping and vacuuming may not be effective when sediment is wet or when tracked soil is caked (caked soil may need to be


Implementation


- Controlling the number of points where vehicles can leave the site will allow sweeping and vacuuming efforts to be focused, and perhaps save money.
- Inspect potential sediment tracking locations daily.
- Visible sediment tracking should be swept or vacuumed on a daily basis.




Construction www.cabmphandbooks.com

STREET SWEEPING AND VACUUMING

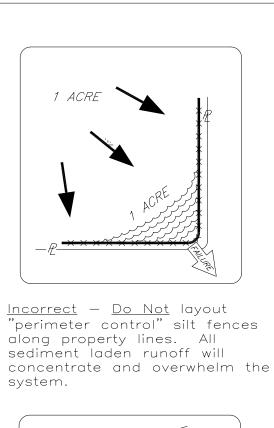

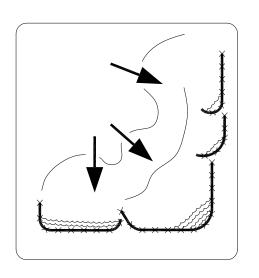

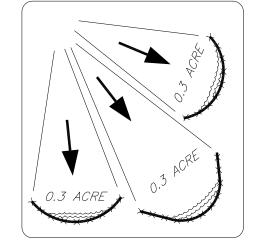


<u>Correct</u> — Install J—hooks

Discreet segments of silt fence, installed with J-hooks or 'smiles' will be much more effective.


SILT FENCE PLACEMENT FOR PERIMETER CONTROL

FILE: SF-PERIMETER CONTROL


SILT FENCE INSTALLATION

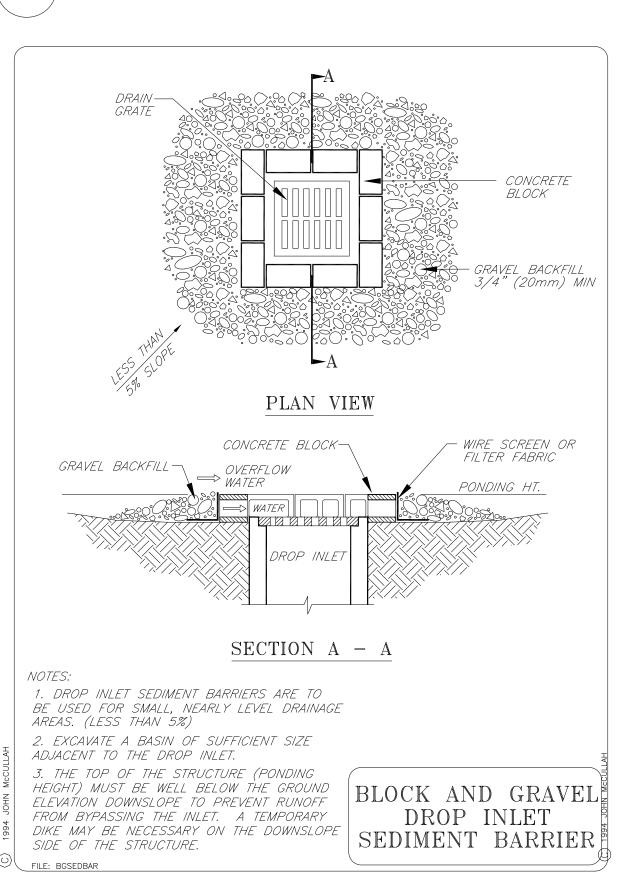



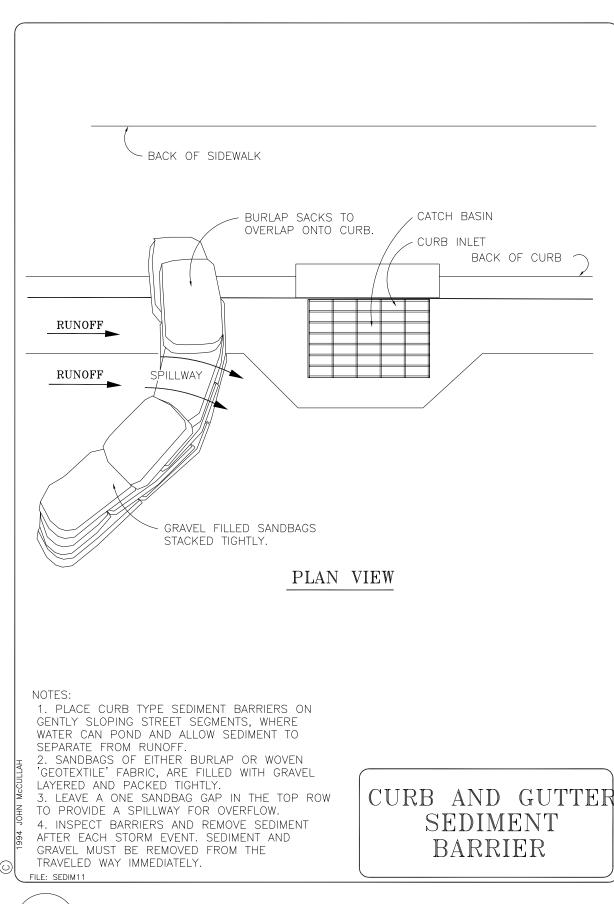

(SE-6) GRAVEL BAG BARRIER DETAIL

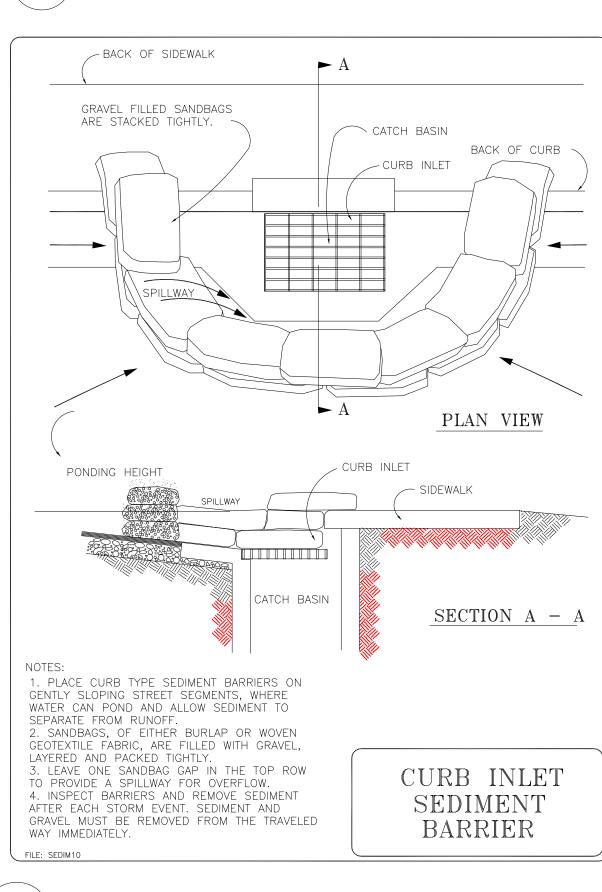

SE-10 STORM DRAIN PROTECTION

PROJECT

MADONNA ROAD APARTMENTS

A RENOVATION AND **UPGRADE PROJECT**

1550 MADONNA ROAD SAN LUIS OBISPO, CA

ARCHITECT JOB# 1207



971 OSOS STREET SAN LUIS OBISPO CALIFORNIA 93401

805-544-6161

www.fraserseiplearchitects.com






PROJECT MANAGER BDF

DRAWN BY DDL

08 - 08 - 2012 09 - 19 - 2012 1st RE-SUB

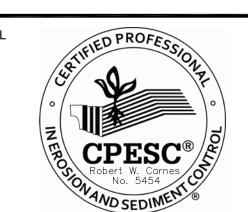


The use of these plans and specifications shall be restricted the original site for which they were prepared and publication thereof is expressly limited to such use. Reproduction or publication by any method, in whole or in part, is prohibited. Title to these plans and specifications remain with the architect without prejudice. Visual contact with these plans and specifications shall constitute prima facie evidence of the acceptance of these restrictions. Written dimensions on these drawings shall have precedence

over scaled dimensions. Contractors shall verify and be responsible for all dimensions and existing conditions on the job and shall report any discrepancies to the architect for esolution prior to commencing work.

EROSION

SHEET TITLE

CONTROL **DETAILS**

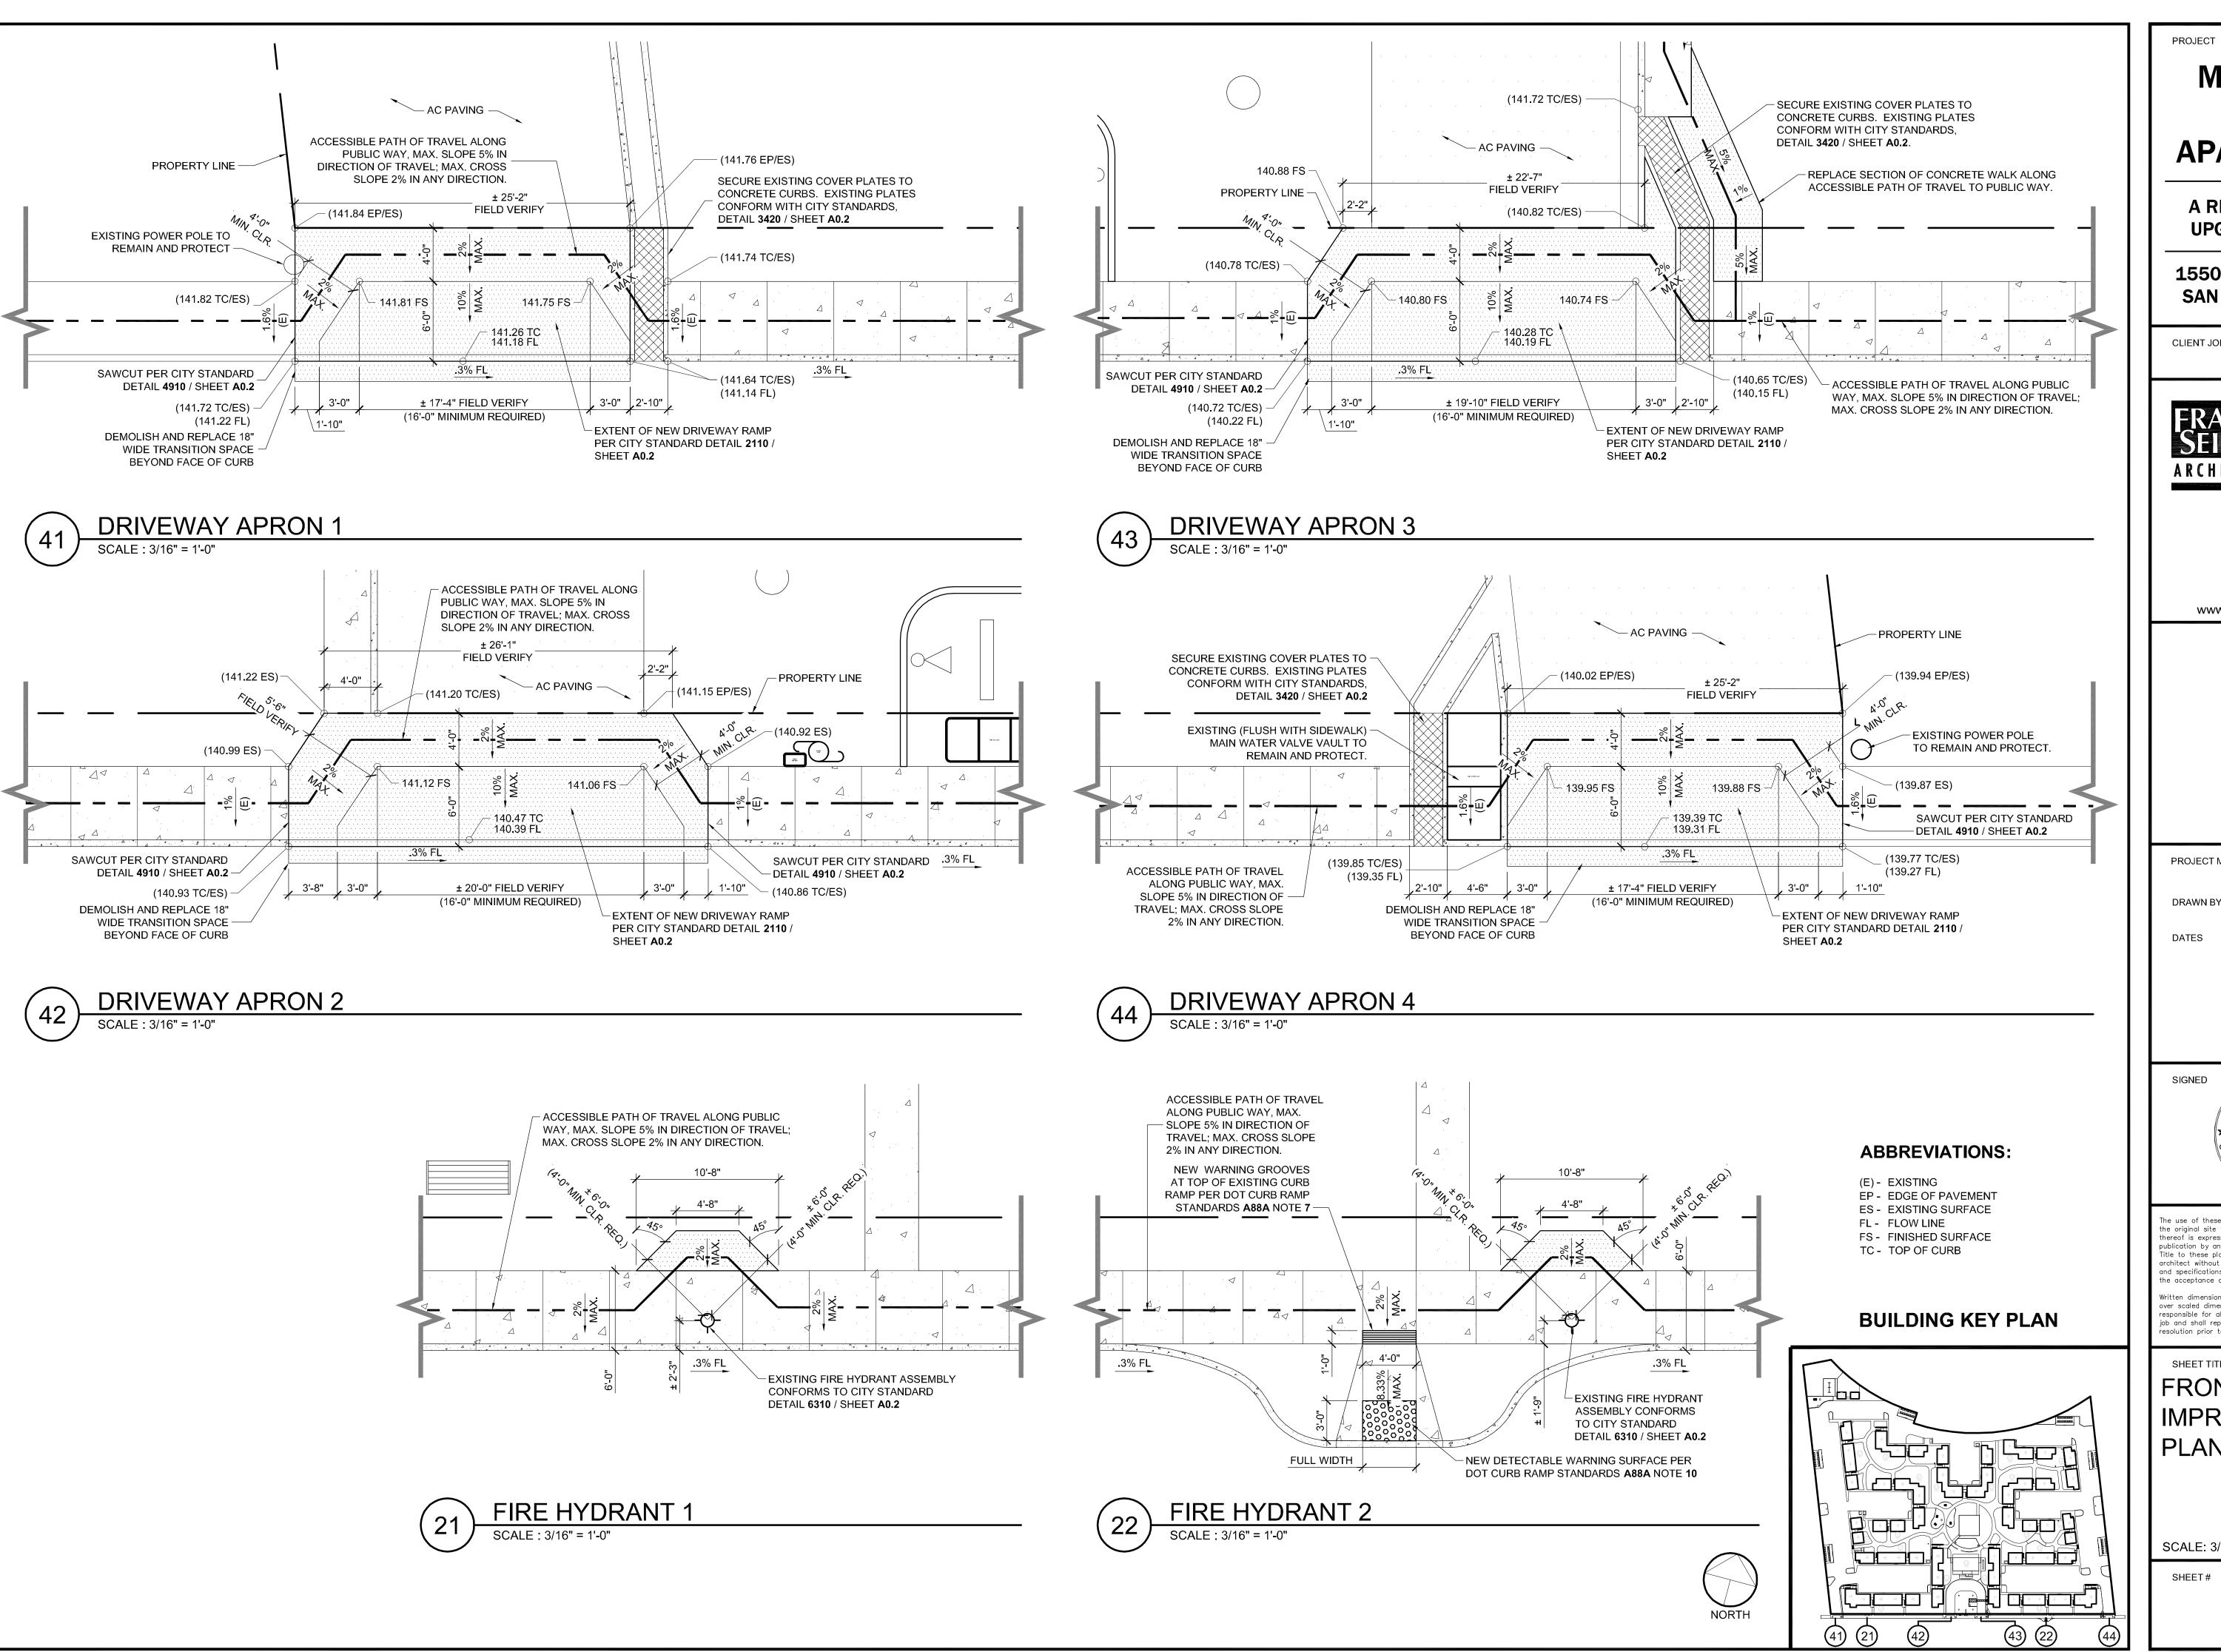

MADONNA ROAD APARTMENTS

A RENOVATION AND **UPGRADE PROJECT**

1550 MADONNA ROAD SAN LUIS OBISPO, CA

CLIENT JOB#

1207

ARCHITECT JOB#



971 OSOS STREET SAN LUIS OBISPO CALIFORNIA 93401

805-544-6161


www.fraserseiplearchitects.com

PROJECT MANAGER BDF

DRAWN BY DDL

08-08-2012 1st SUBMITTAL

09-19-2012 1st RE-SUBMITTAL 10-05-2012 FOR CONSTRUCTION

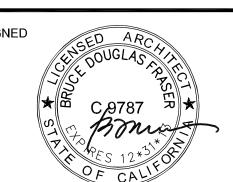

The use of these plans and specifications shall be restricted the original site for which they were prepared and publication thereof is expressly limited to such use. Reproduction or publication by any method, in whole or in part, is prohibited. Title to these plans and specifications remain with the architect without prejudice. Visual contact with these plans and specifications shall constitute prima facie evidence of e acceptance of these restrictions.

Written dimensions on these drawings shall have precedence over scaled dimensions. Contractors shall verify and be responsible for all dimensions and existing conditions on the job and shall report any discrepancies to the architect for resolution prior to commencing work.


SHEET TITLE


FRONTAGE **IMPROVEMENT** PLANS


SCALE: 3/16" = 1'=0"


SHEET#

A0.1

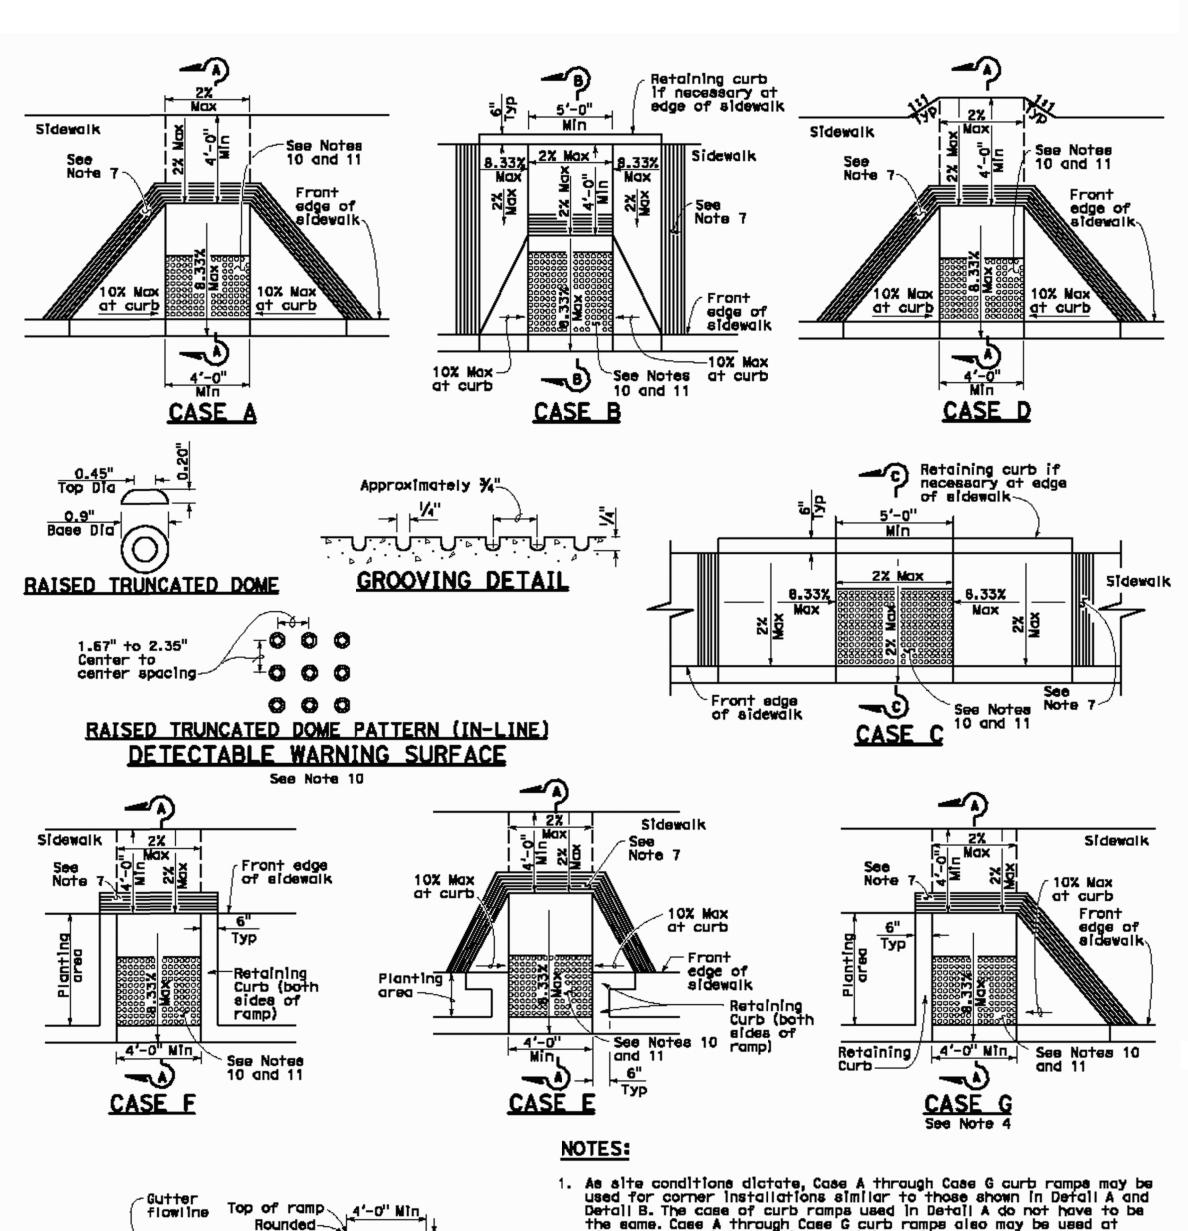

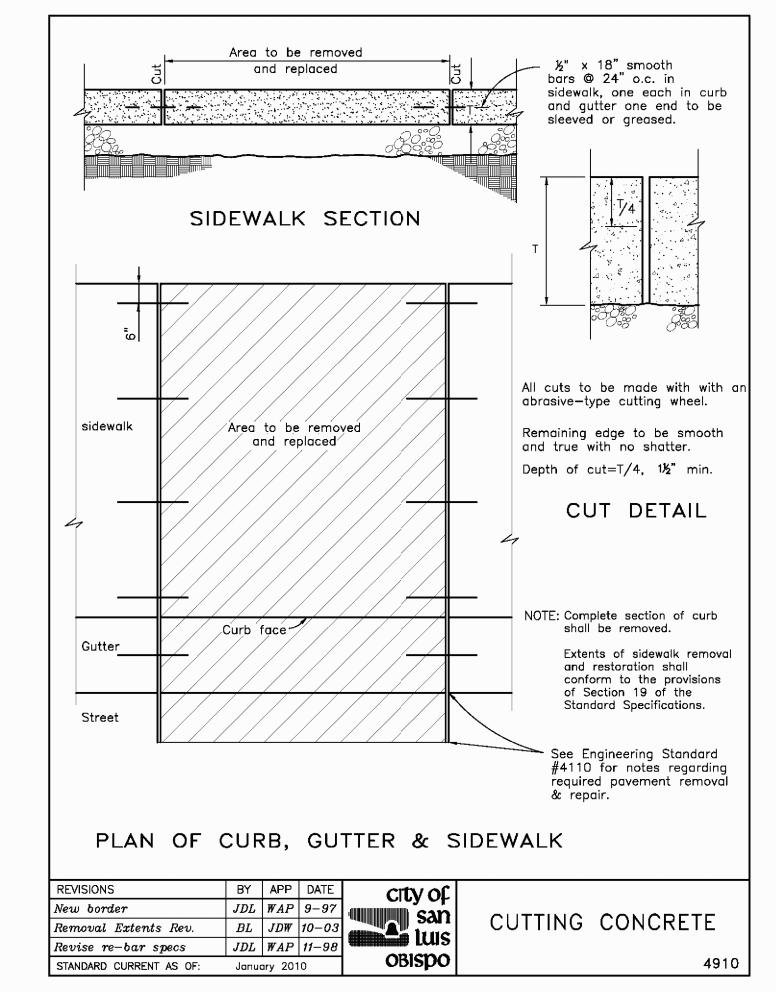

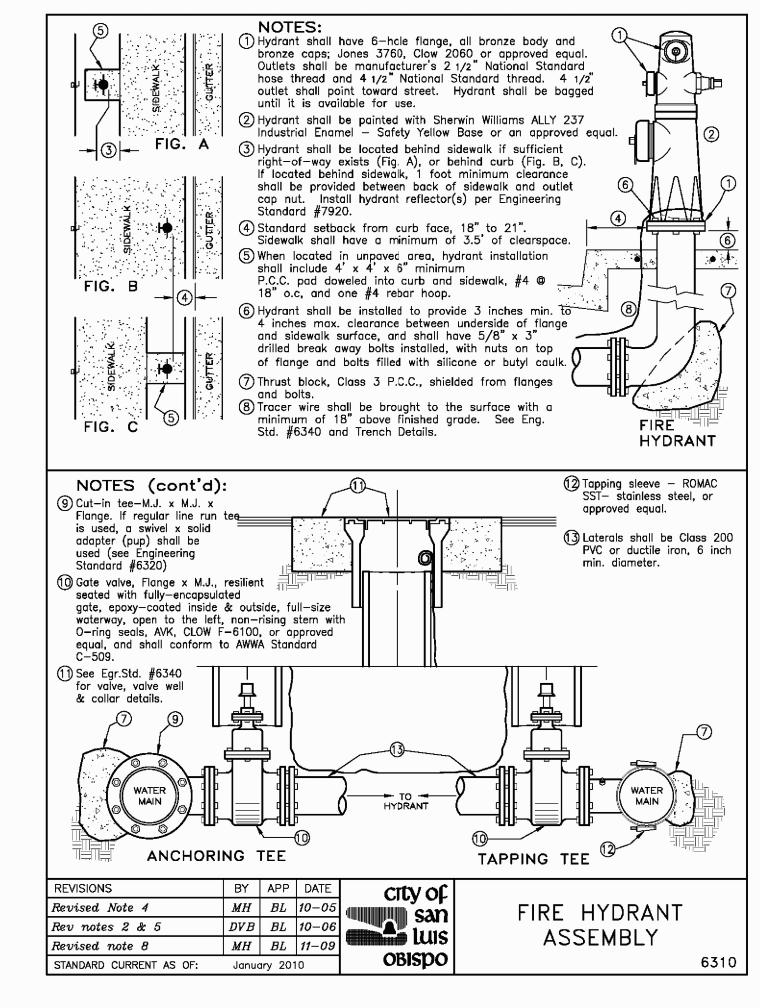

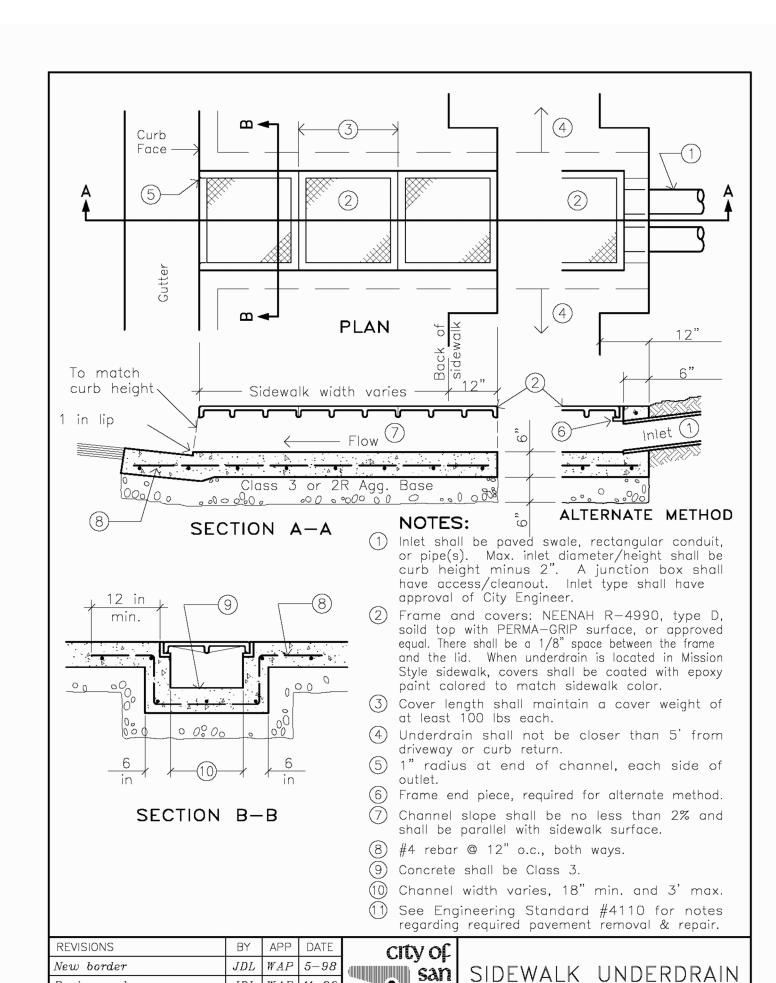

Luis

OBISPO


WITH COVER PLATES


| JDL | WAP | 11-98


levise re-bar specs

ANDARD CURRENT AS OF:

ev. Note 2 & CL2R Base DVB BL 11-08

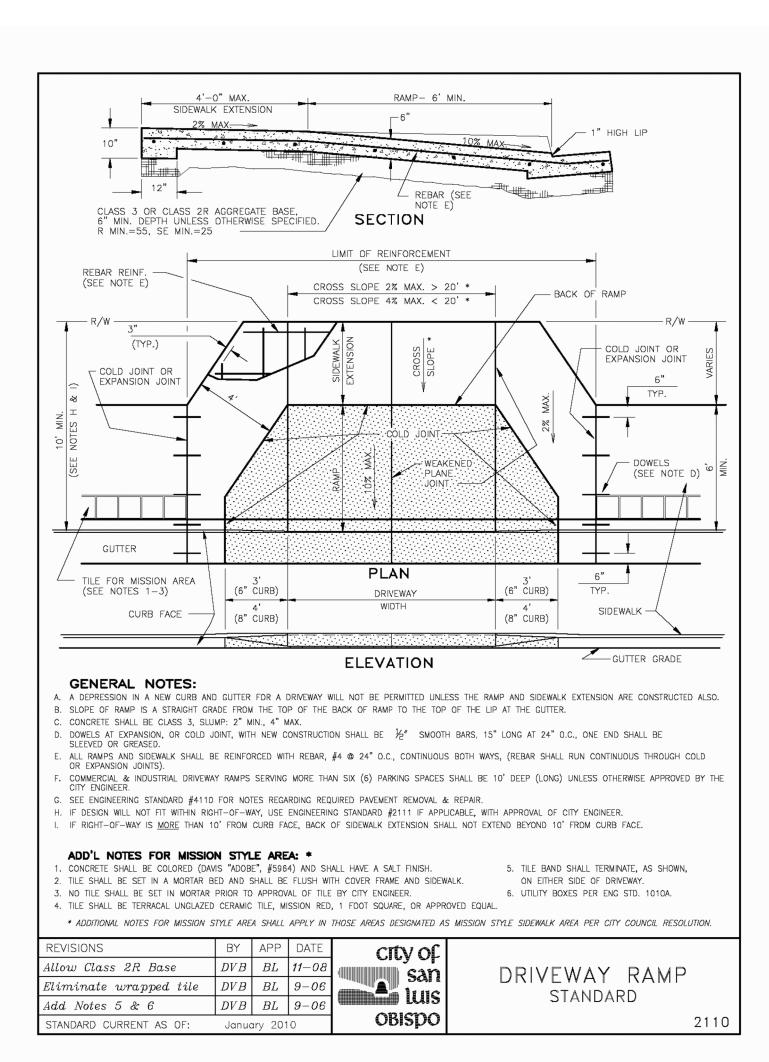

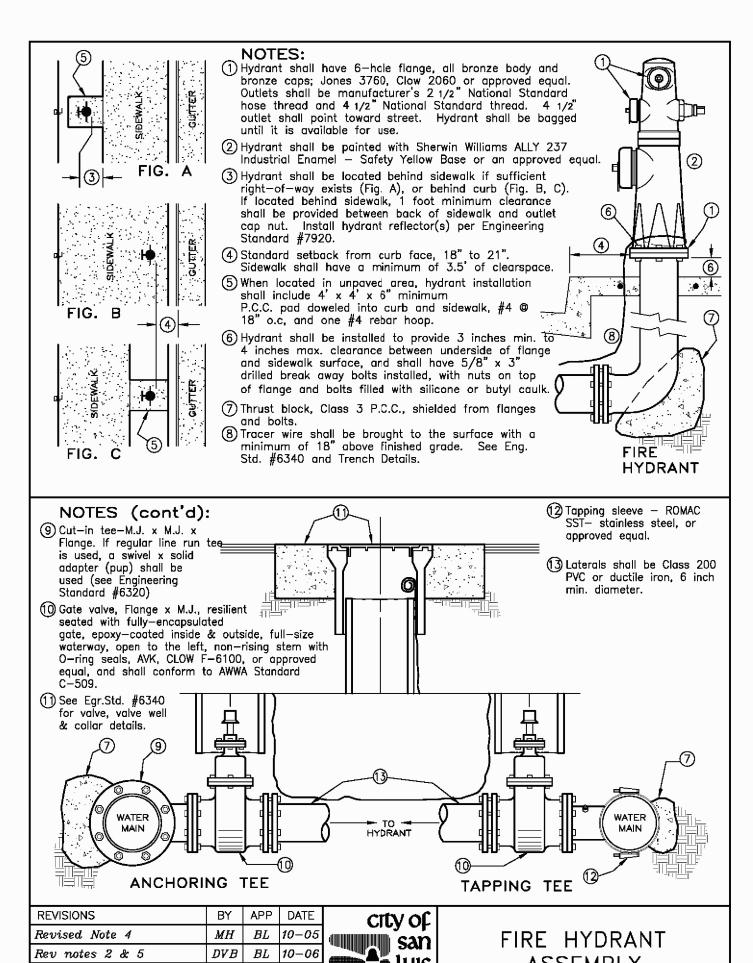

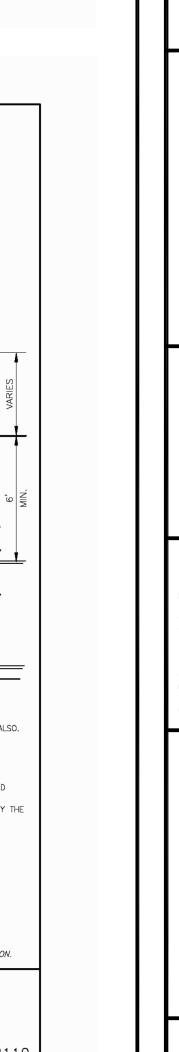



A RENOVATION AND **UPGRADE PROJECT**

1550 MADONNA ROAD SAN LUIS OBISPO, CA

CLIENT JOB#

PROJECT

1207

ARCHITECT JOB#



971 OSOS STREET SAN LUIS OBISPO CALIFORNIA 93401

805-544-6161

www.fraserseiplearchitects.com

PROJECT MANAGER BDF

DRAWN BY DDL

08-08-2012 1st SUBMITTAL

09-19-2012 1st RE-SUBMITTAL 10-05-2012 FOR CONSTRUCTION

SIGNED

The use of these plans and specifications shall be restricted the original site for which they were prepared and publication thereof is expressly limited to such use. Reproduction or publication by any method, in whole or in part, is prohibited. Title to these plans and specifications remain with the architect without prejudice. Visual contact with these plans and specifications shall constitute prima facie evidence of the acceptance of these restrictions.

Written dimensions on these drawings shall have precedence over scaled dimensions. Contractors shall verify and be responsible for all dimensions and existing conditions on the job and shall report any discrepancies to the architect for esolution prior to commencing work.


SHEET TITLE


FRONTAGE IMPROVEMENT DETAILS


SCALE: 1" = 10'=0"


SHEET#


A0.2

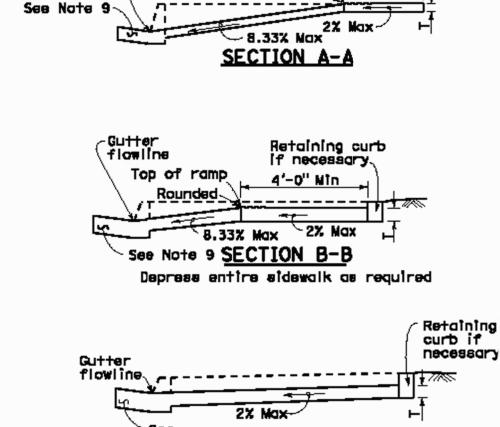


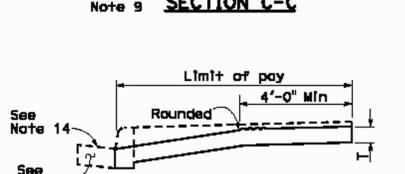


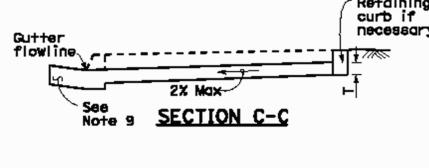

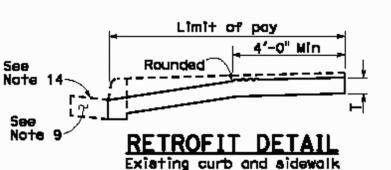

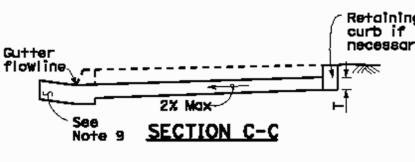

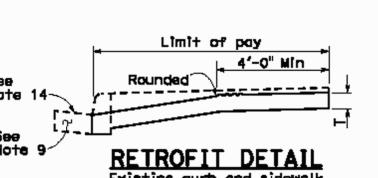

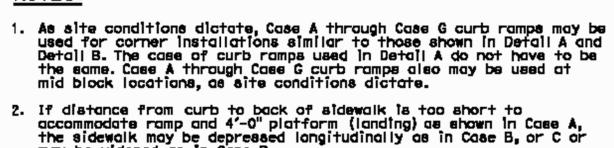

- may be widened as in Case D.
- 3. When ramp is located in center of curb return, crosswalk configuration must be similar to that shown for Detail B
- 4. As site conditions dictate, the retaining curb side and the flored side of the Case G ramp shall be constructed in reversed position.
- 5. If located on a curve, the sides of the ramp need not be parallel, but the minimum width of the ramp shall be 4'-0".
- 6. Side slope of ramp flares vary uniformly from a maximum of 10% at curb to conform with longitudinal sidewalk slope adjacent to top of the ramp, except in Case C and Case F.
- The curb ramp shall be outlined, as shown, with a 1'-0" wide border with '4" grooves approximately '4" on center. See grooving detail.
- 8. Transitions from ramps and landing to walke, gutters or streets shall be flush and free of abrupt changes.
- 9. Maximum slopes of adjoining gutters, the road surface immediately adjacent to the curb ramp or accessible route shall not exceed 5 percent within 4'-0" of the top and bottom of the curb ramp.
- 10. Curb ramps shall have a detectable warning surface that extends the full width and 3'-0" depth of the ramp. Detectable Warning Surfaces shall conform to the details on this plan and the requirements in the Special Provisions.
- 11. The edge of the detectable warning surface nearest the street shall be between 6" and 8" from the gutter flowline.
- 12. Sidewalk and ramp thickness, "T", shall be 31/2" minimum.
- 13. Utility pull boxes, manholes, vaults and all other utility facilities within the boundaries of the curb ramp will be relocated or adjusted to grade by the owner prior to, or in conjunction with, curb ramp construction.
- 14. For retrofit conditions, removal and replacement of curb apron will be at the Contractor's option, unless otherwise shown on project plane.

STATE OF CALIFORNA

DEPARTMENT OF TRANSPORTATION **CURB RAMP DETAILS**

NO SCALE

RSP A88A DATED SEPTEMBER 1, 2006 SUPERSEDES STANDARD PLAN A88A DATED MAY 1, 2006 - PAGE 115 OF THE STANDARD PLANS BOOK DATED MAY 2006.

REVISED STANDARD PLAN RSP A88A



MADONNA ROAD APARTMENTS

A RENOVATION AND UPGRADE PROJECT

1550 MADONNA ROAD SAN LUIS OBISPO, CA

CLIENT JOB#

ARCHITECT JOB#
1207



971 OSOS STREET SAN LUIS OBISPO CALIFORNIA 93401

805-544-6161

www.fraserseiplearchitects.com

PROJECT MANAGER BDF

DRAWN BY DDL

08-08-2012 1st SUBMITTAL
09-19-2012 1st RE-SUBMITTAL
10-05-2012 FOR CONSTRUCTION

SIGNED

SIGNED

ARCHIVE

OUGLAS

FER

STATE

ARCHIVE

OUGLAS

O

The use of these plans and specifications shall be restricted to the original site for which they were prepared and publication thereof is expressly limited to such use. Reproduction or publication by any method, in whole or in part, is prohibited. Title to these plans and specifications remain with the architect without prejudice. Visual contact with these plans and specifications shall constitute prima facie evidence of the acceptance of these restrictions.


Written dimensions on these drawings shall have precedence over scaled dimensions. Contractors shall verify and be responsible for all dimensions and existing conditions on the job and shall report any discrepancies to the architect for resolution prior to commencing work.

SHEET TITLE

SITE DEMOLITION PLAN

SCALE: 1" = 30'=0"

SHEET#

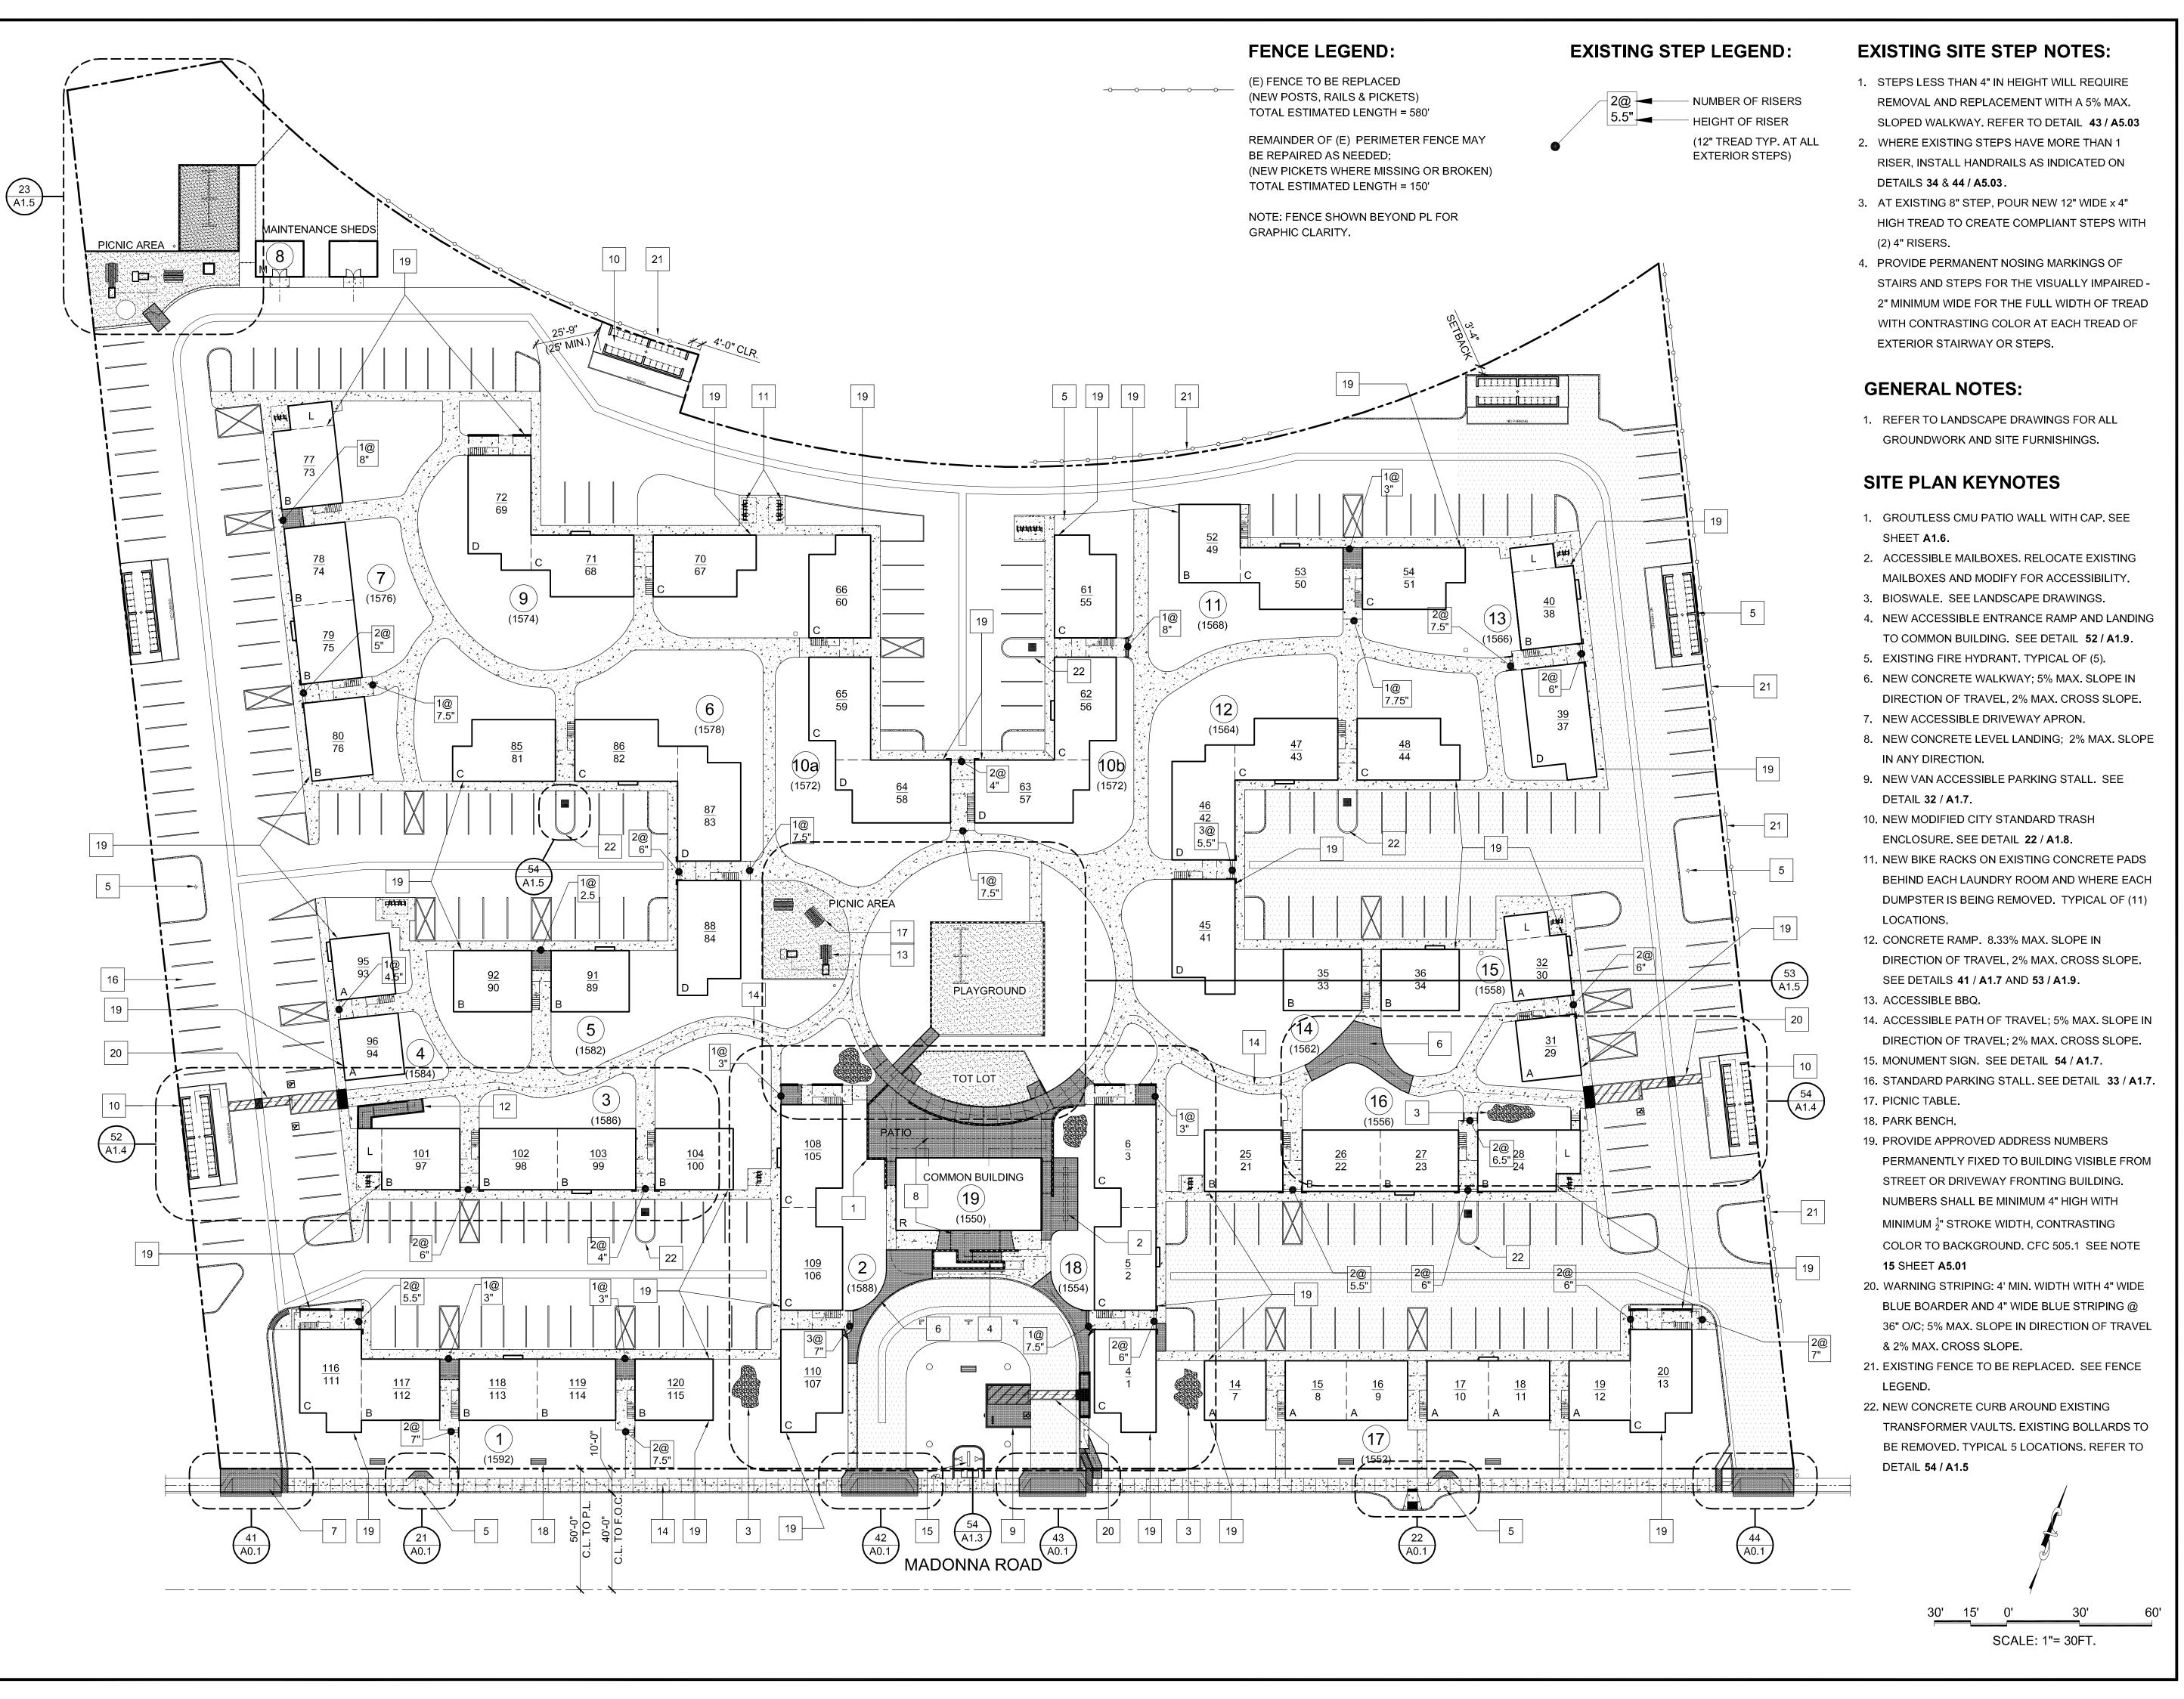

MADONNA ROAD APARTMENTS

A RENOVATION AND UPGRADE PROJECT

1550 MADONNA ROAD SAN LUIS OBISPO, CA

CLIENT JOB#

1207

ARCHITECT JOB#



971 OSOS STREET SAN LUIS OBISPO CALIFORNIA 93401

805-544-6161

www.fraserseiplearchitects.com

PROJECT MANAGER BDF

DRAWN BY DDL

08-08-2012 1st SUBMITTAL
09-19-2012 1st RE-SUBMITTAL
10-05-2012 FOR CONSTRUCTION

SIGNED ARC



The use of these plans and specifications shall be restricted the original site for which they were prepared and publication thereof is expressly limited to such use. Reproduction or publication by any method, in whole or in part, is prohibited. Title to these plans and specifications remain with the architect without prejudice. Visual contact with these plans and specifications shall constitute prima facie evidence of the acceptance of these restrictions.


over scaled dimensions. Contractors shall verify and be responsible for all dimensions and existing conditions on the job and shall report any discrepancies to the architect for resolution prior to commencing work.

Written dimensions on these drawings shall have precedence

SHEET TITLE

NEW SITE PLAN

SCALE: 1" = 30'=0"

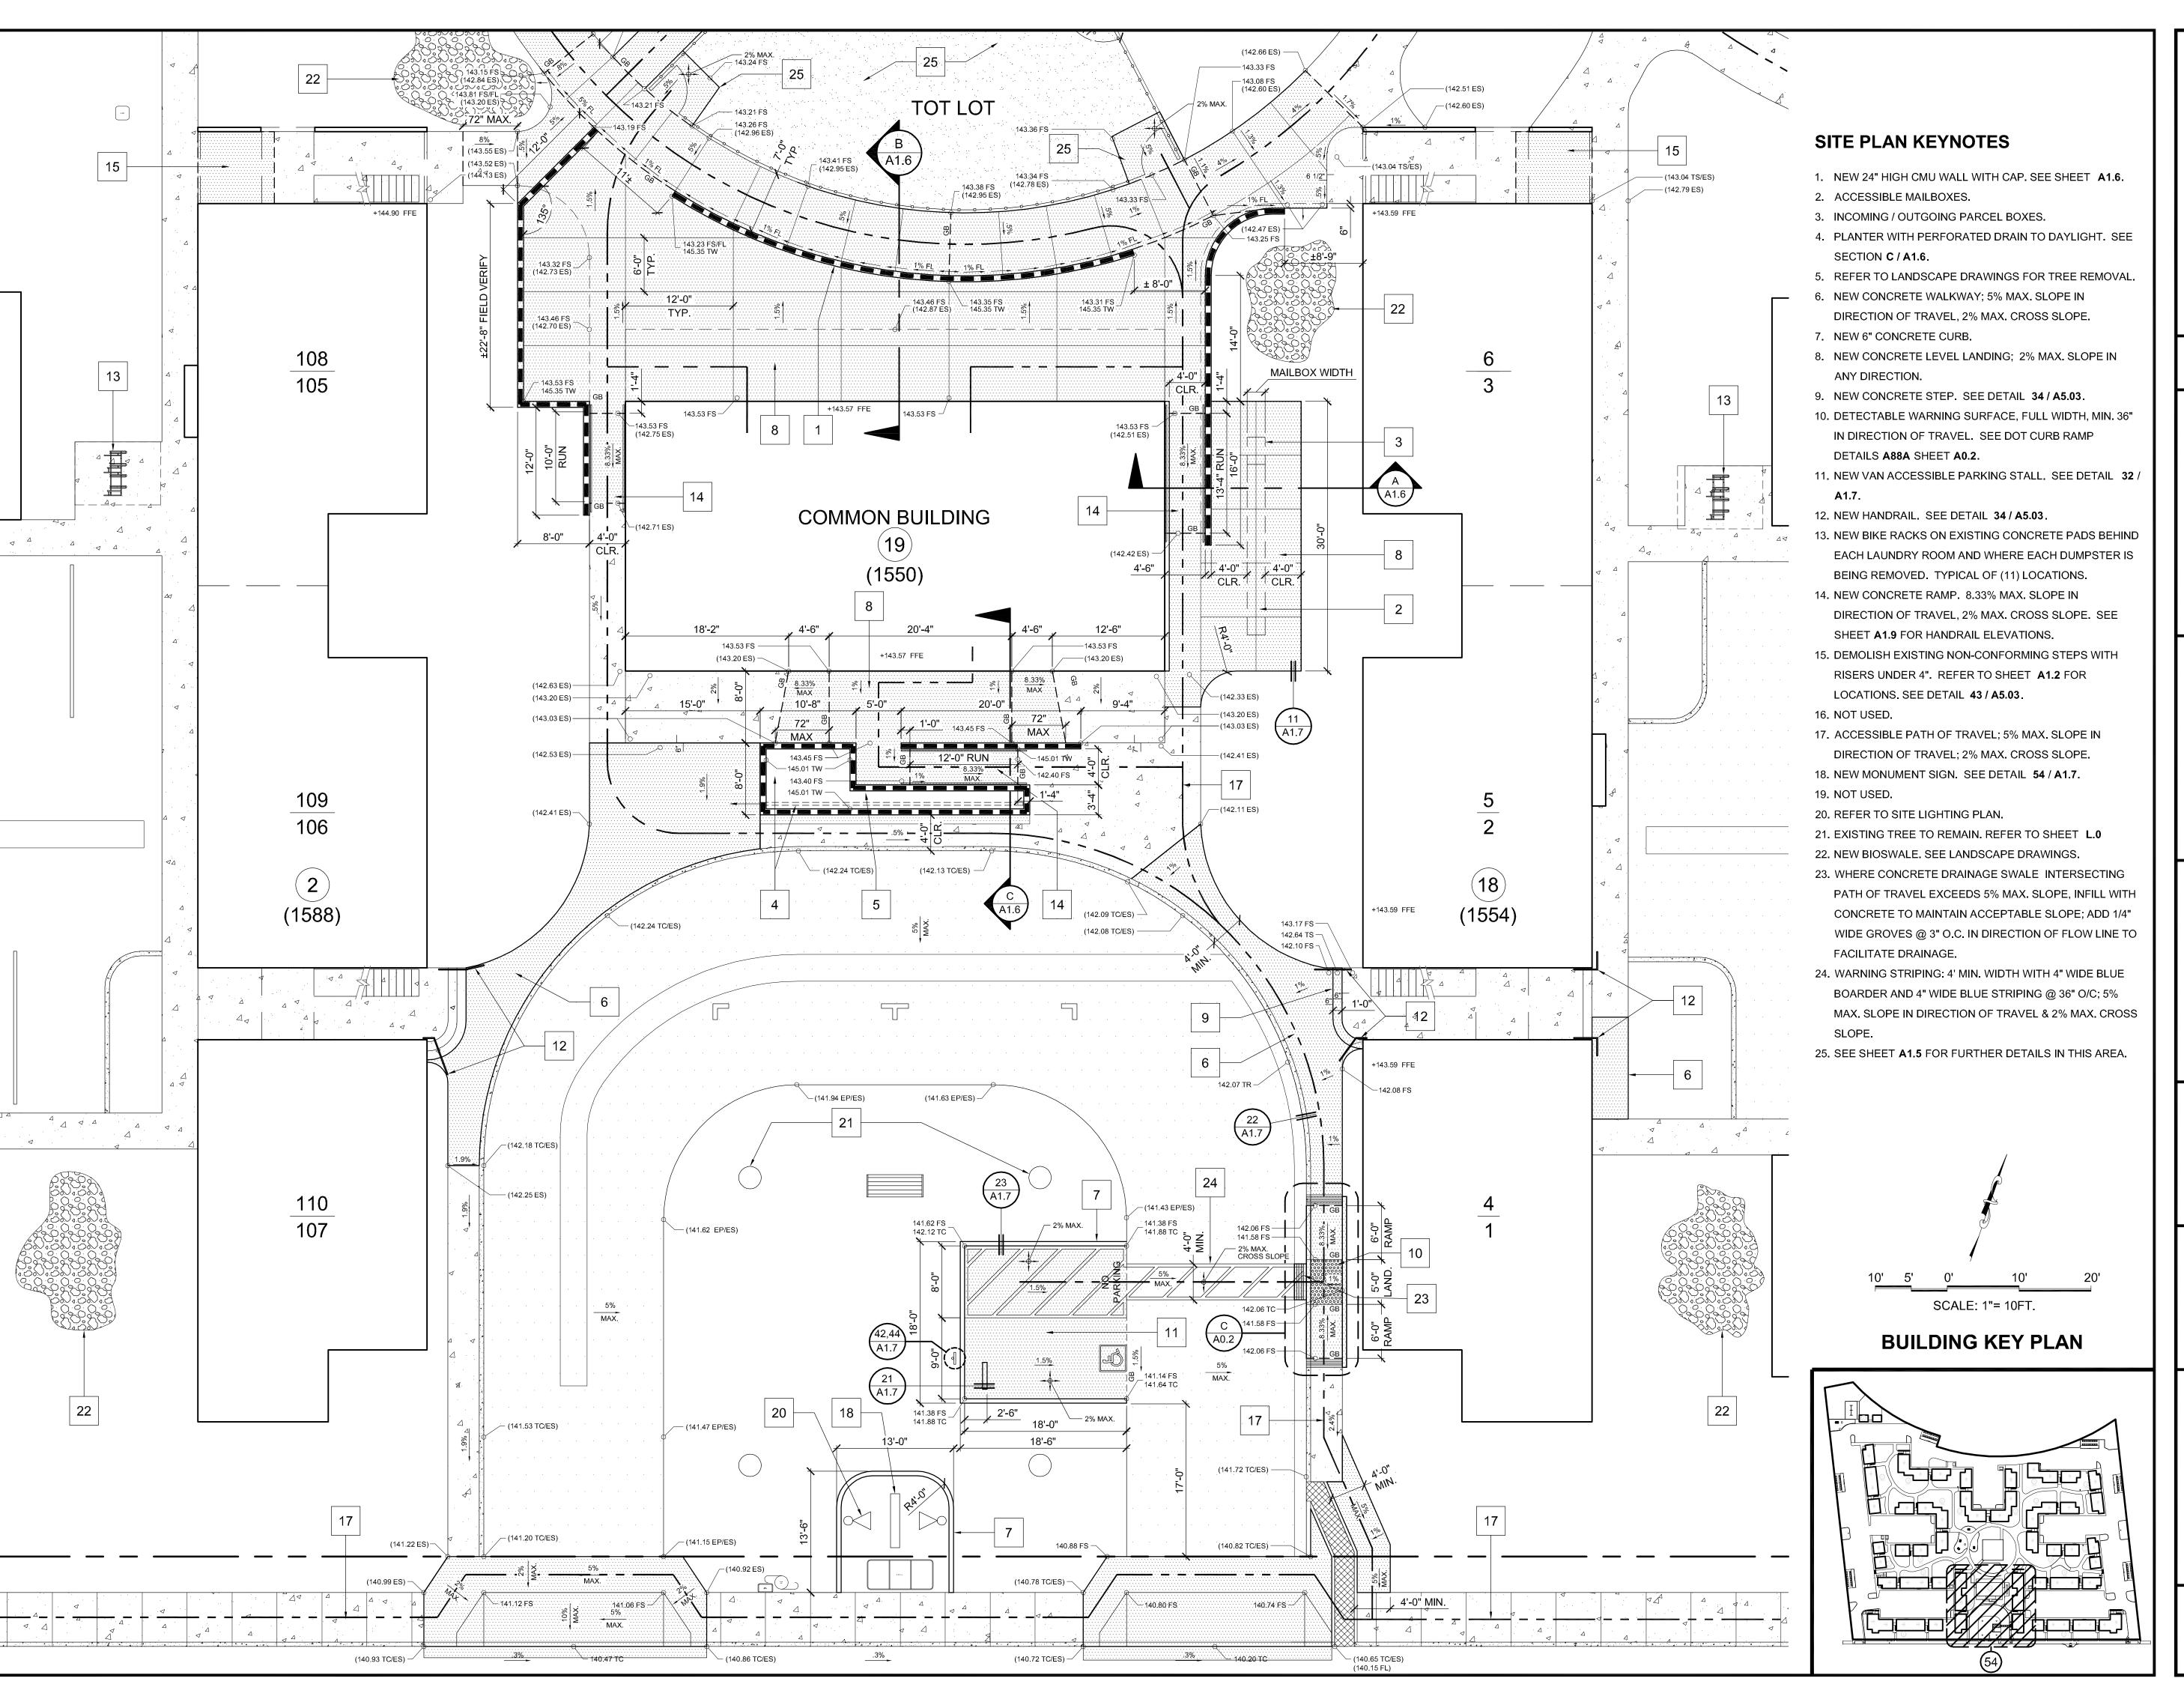

MADONNA ROAD APARTMENTS

A RENOVATION AND UPGRADE PROJECT

1550 MADONNA ROAD SAN LUIS OBISPO, CA

CLIENT JOB#

ARCHITECT JOB # 1207



971 OSOS STREET SAN LUIS OBISPO CALIFORNIA 93401

805-544-6161

www.fraserseiplearchitects.com

PROJECT MANAGER BDF

DRAWN BY DDL

08-08-2012 1st SUBMITTAL
09-19-2012 1st RE-SUBMITTAL

10-05-2012 FOR CONSTRUCTION

TED ARCHIVE DOUGLAS TO SEE TO

The use of these plans and specifications shall be restricted the original site for which they were prepared and publication thereof is expressly limited to such use. Reproduction or publication by any method, in whole or in part, is prohibited. Title to these plans and specifications remain with the architect without prejudice. Visual contact with these plans and specifications shall constitute prima facie evidence of the acceptance of these restrictions.


Written dimensions on these drawings shall have precedence over scaled dimensions. Contractors shall verify and be responsible for all dimensions and existing conditions on the job and shall report any discrepancies to the architect for resolution prior to commencing work.

SHEET TITLE

ENLARGED SITE PLAN

SCALE: 1/8" = 10'=0"

SHEET#

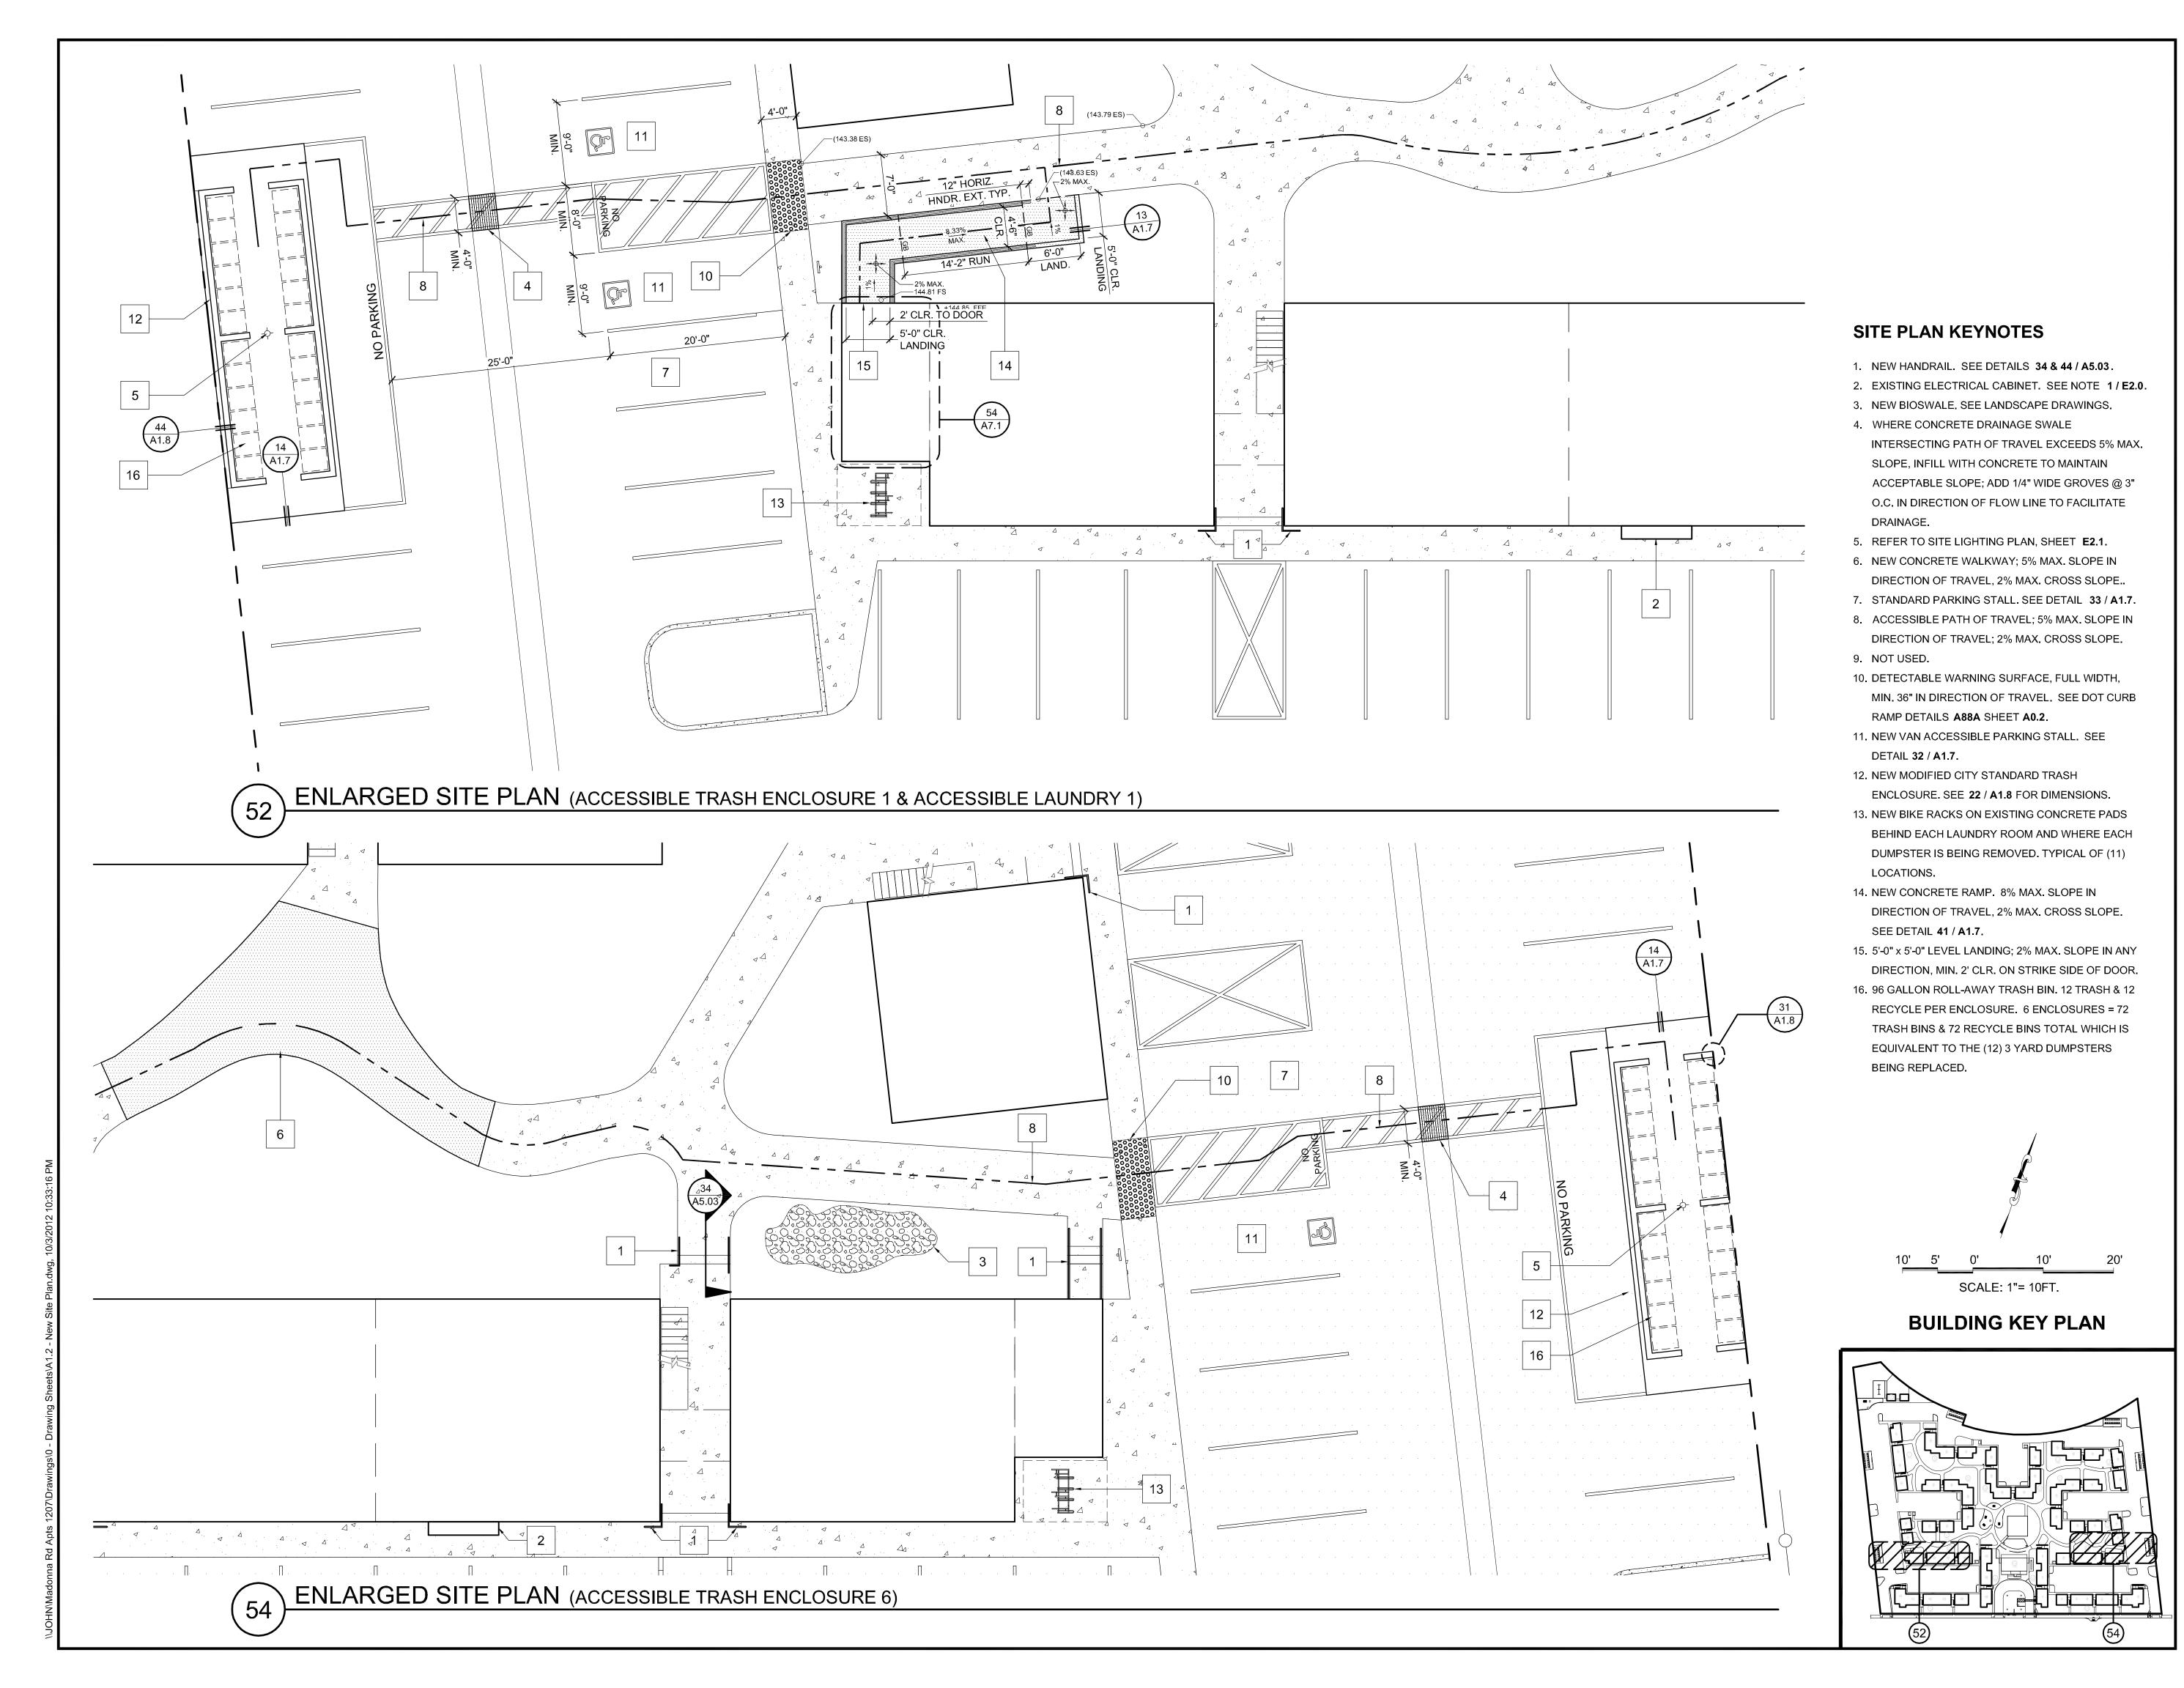

MADONNA ROAD APARTMENTS

A RENOVATION AND UPGRADE PROJECT

1550 MADONNA ROAD SAN LUIS OBISPO, CA

CLIENT JOB#

ARCHITECT JOB # **1207**



971 OSOS STREET SAN LUIS OBISPO CALIFORNIA 93401

805-544-6161

www.fraserseiplearchitects.com

PROJECT MANAGER BDF

DRAWN BY DDL

08-08-2012 1st SUBMITTAL
09-19-2012 1st RE-SUBMITTAL
10-05-2012 FOR CONSTRUCTION

NED

ARCHITICAL

A

The use of these plans and specifications shall be restricted the original site for which they were prepared and publication thereof is expressly limited to such use. Reproduction or publication by any method, in whole or in part, is prohibited. Title to these plans and specifications remain with the architect without prejudice. Visual contact with these plans and specifications shall constitute prima facie evidence of the acceptance of these restrictions.


Written dimensions on these drawings shall have precedence over scaled dimensions. Contractors shall verify and be responsible for all dimensions and existing conditions on the job and shall report any discrepancies to the architect for resolution prior to commencing work.

SHEET TITLE

ENLARGED SITE PLANS

SCALE: 1/8" = 1'=0"

SHEET#

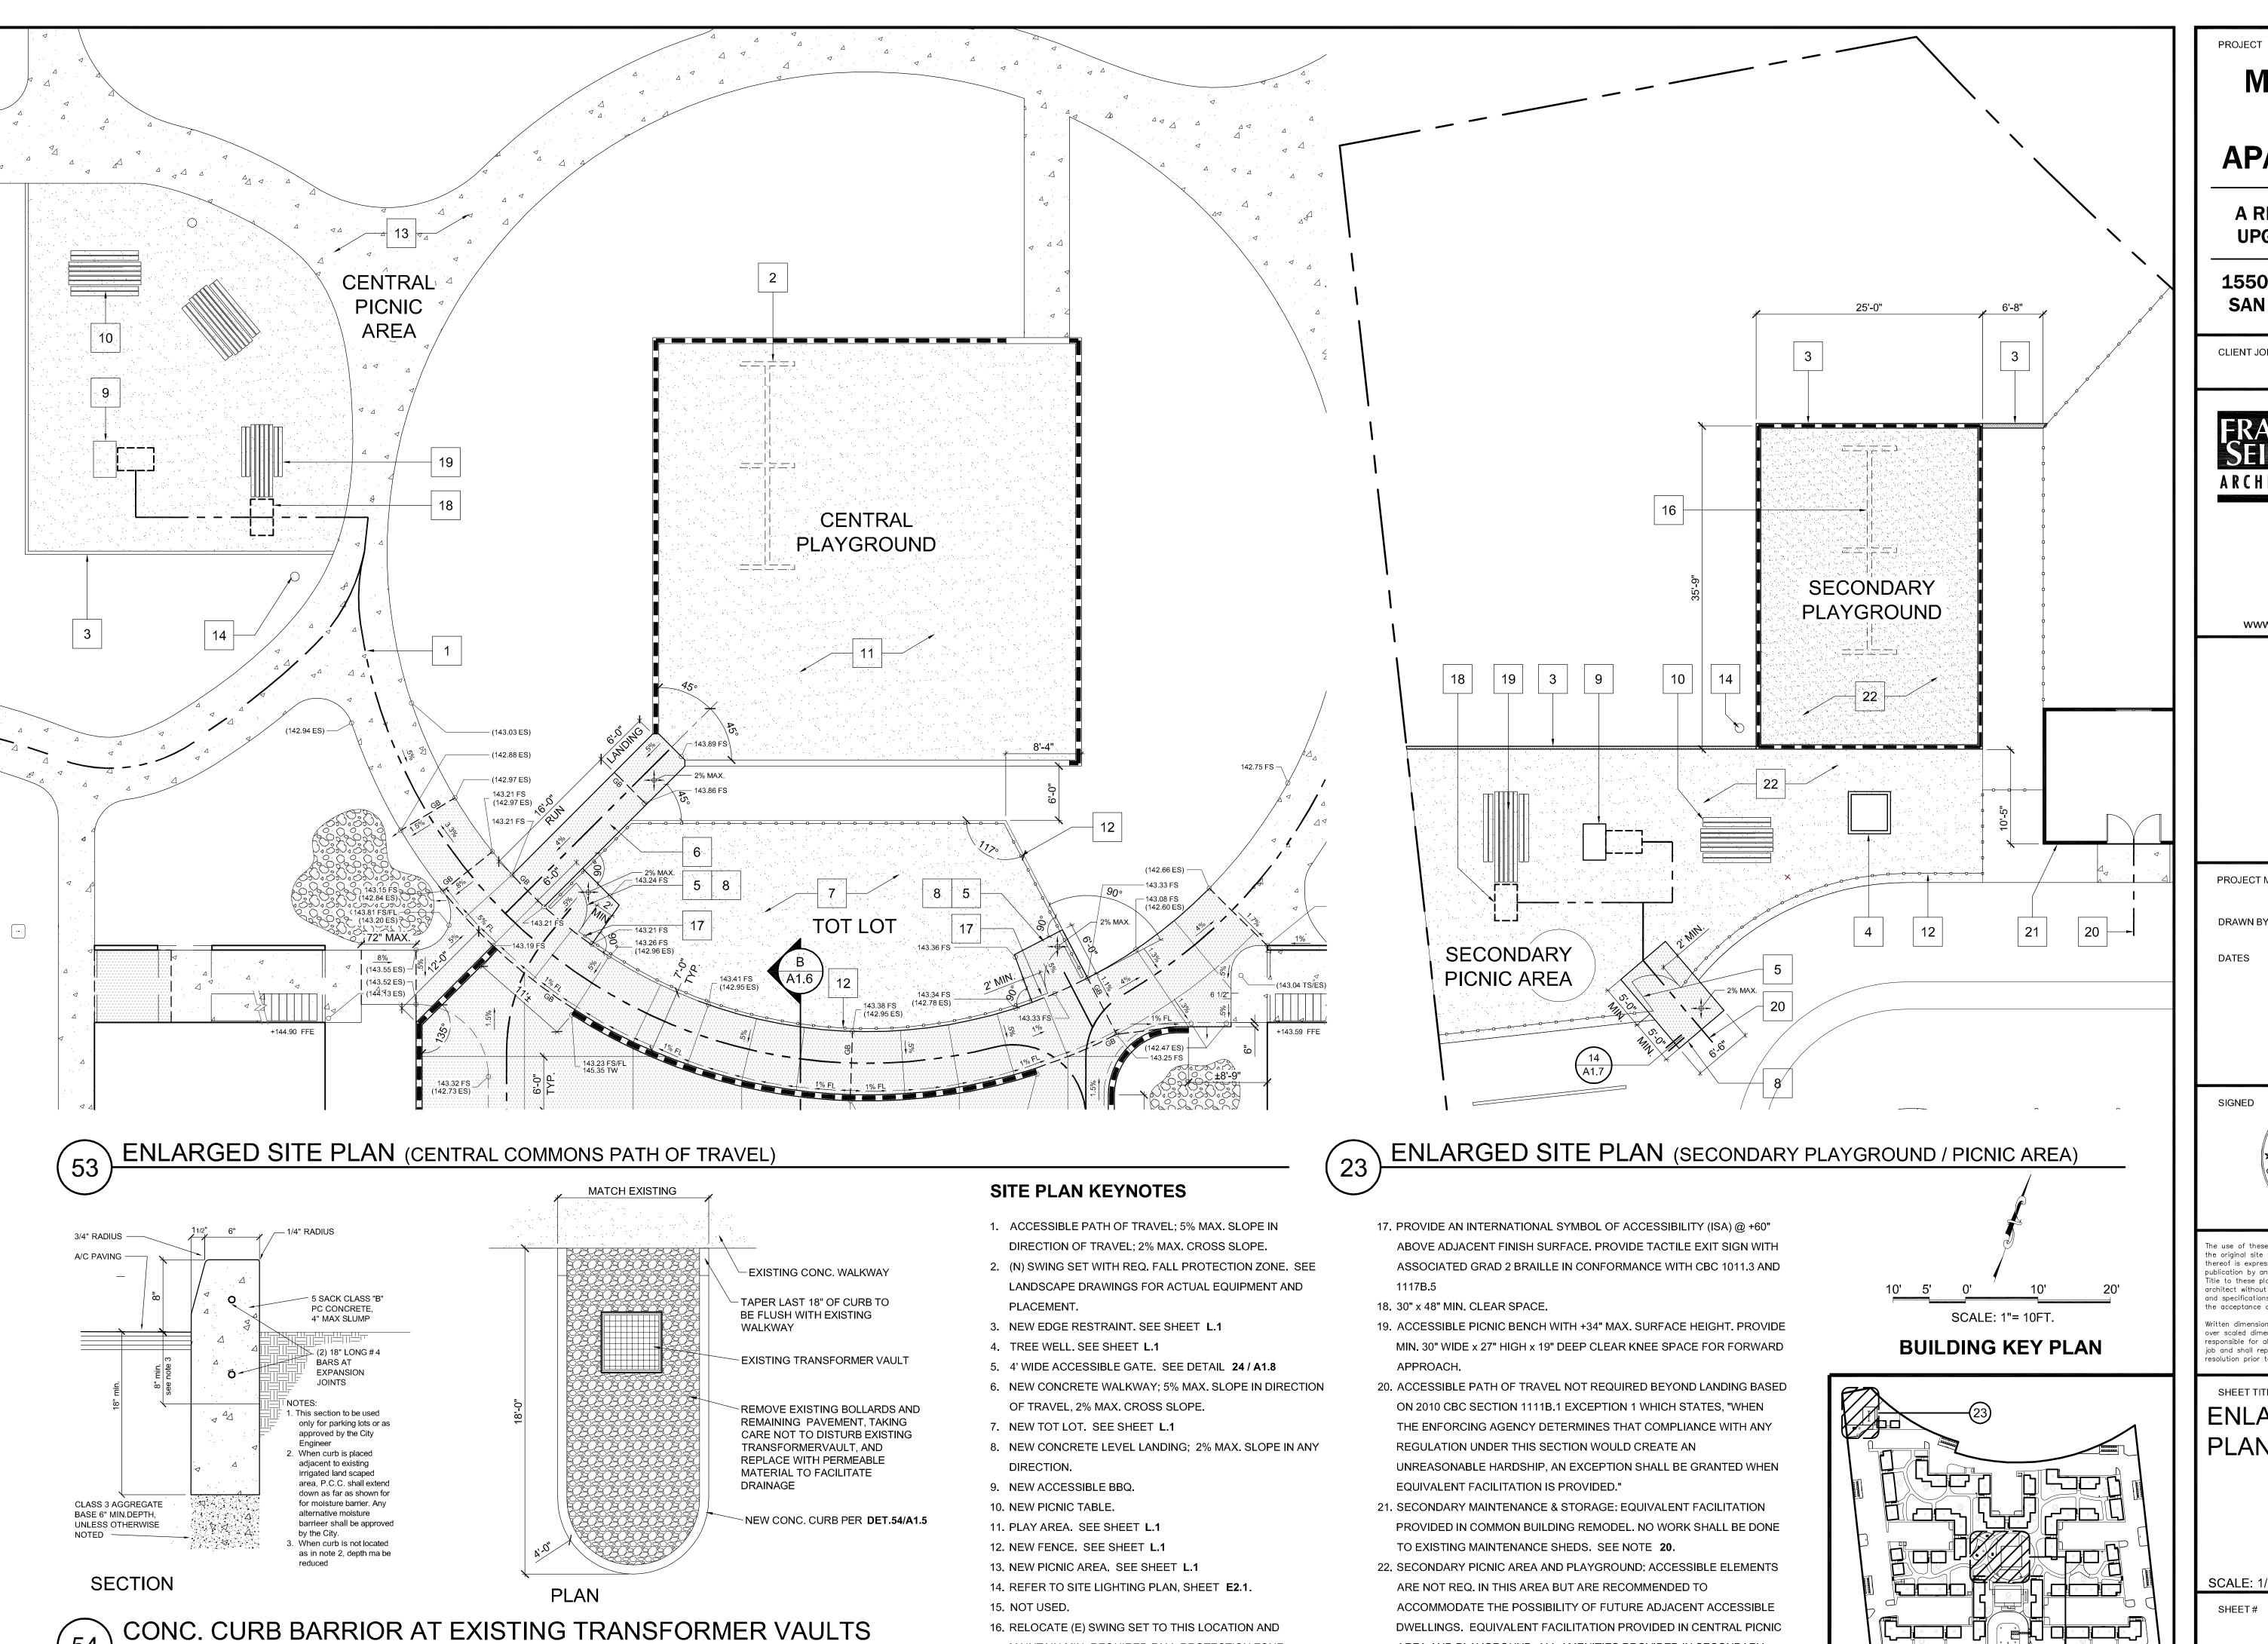

MAINTAIN MIN. REQUIRED FALL PROTECTION ZONE.

AREA AND PLAYGROUND. ALL AMENITIES PROVIDED IN SECONDARY

AREA MUST BE PROVIDED IN CENTRAL AREA. SEE NOTE 20.

MADONNA ROAD APARTMENTS

A RENOVATION AND **UPGRADE PROJECT**

1550 MADONNA ROAD SAN LUIS OBISPO, CA

CLIENT JOB#

1207

ARCHITECT JOB#



971 OSOS STREET SAN LUIS OBISPO CALIFORNIA 93401

805-544-6161


www.fraserseiplearchitects.com

PROJECT MANAGER BDF

DRAWN BY DDL

08-08-2012 1st SUBMITTAL 09-19-2012 1st RE-SUBMITTAL

10-05-2012 FOR CONSTRUCTION

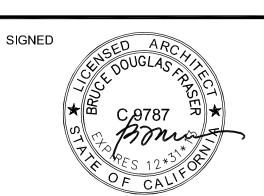


he use of these plans and specifications shall be restricted the original site for which they were prepared and publication thereof is expressly limited to such use. Reproduction or publication by any method, in whole or in part, is prohibited Title to these plans and specifications remain with the architect without prejudice. Visual contact with these plans and specifications shall constitute prima facie evidence of e acceptance of these restrictions.

Written dimensions on these drawings shall have precedence over scaled dimensions. Contractors shall verify and be responsible for all dimensions and existing conditions on the job and shall report any discrepancies to the architect for resolution prior to commencing work.


ENLARGED SITE PLANS

SCALE: 1/8" = 1'=0"

SHEET#

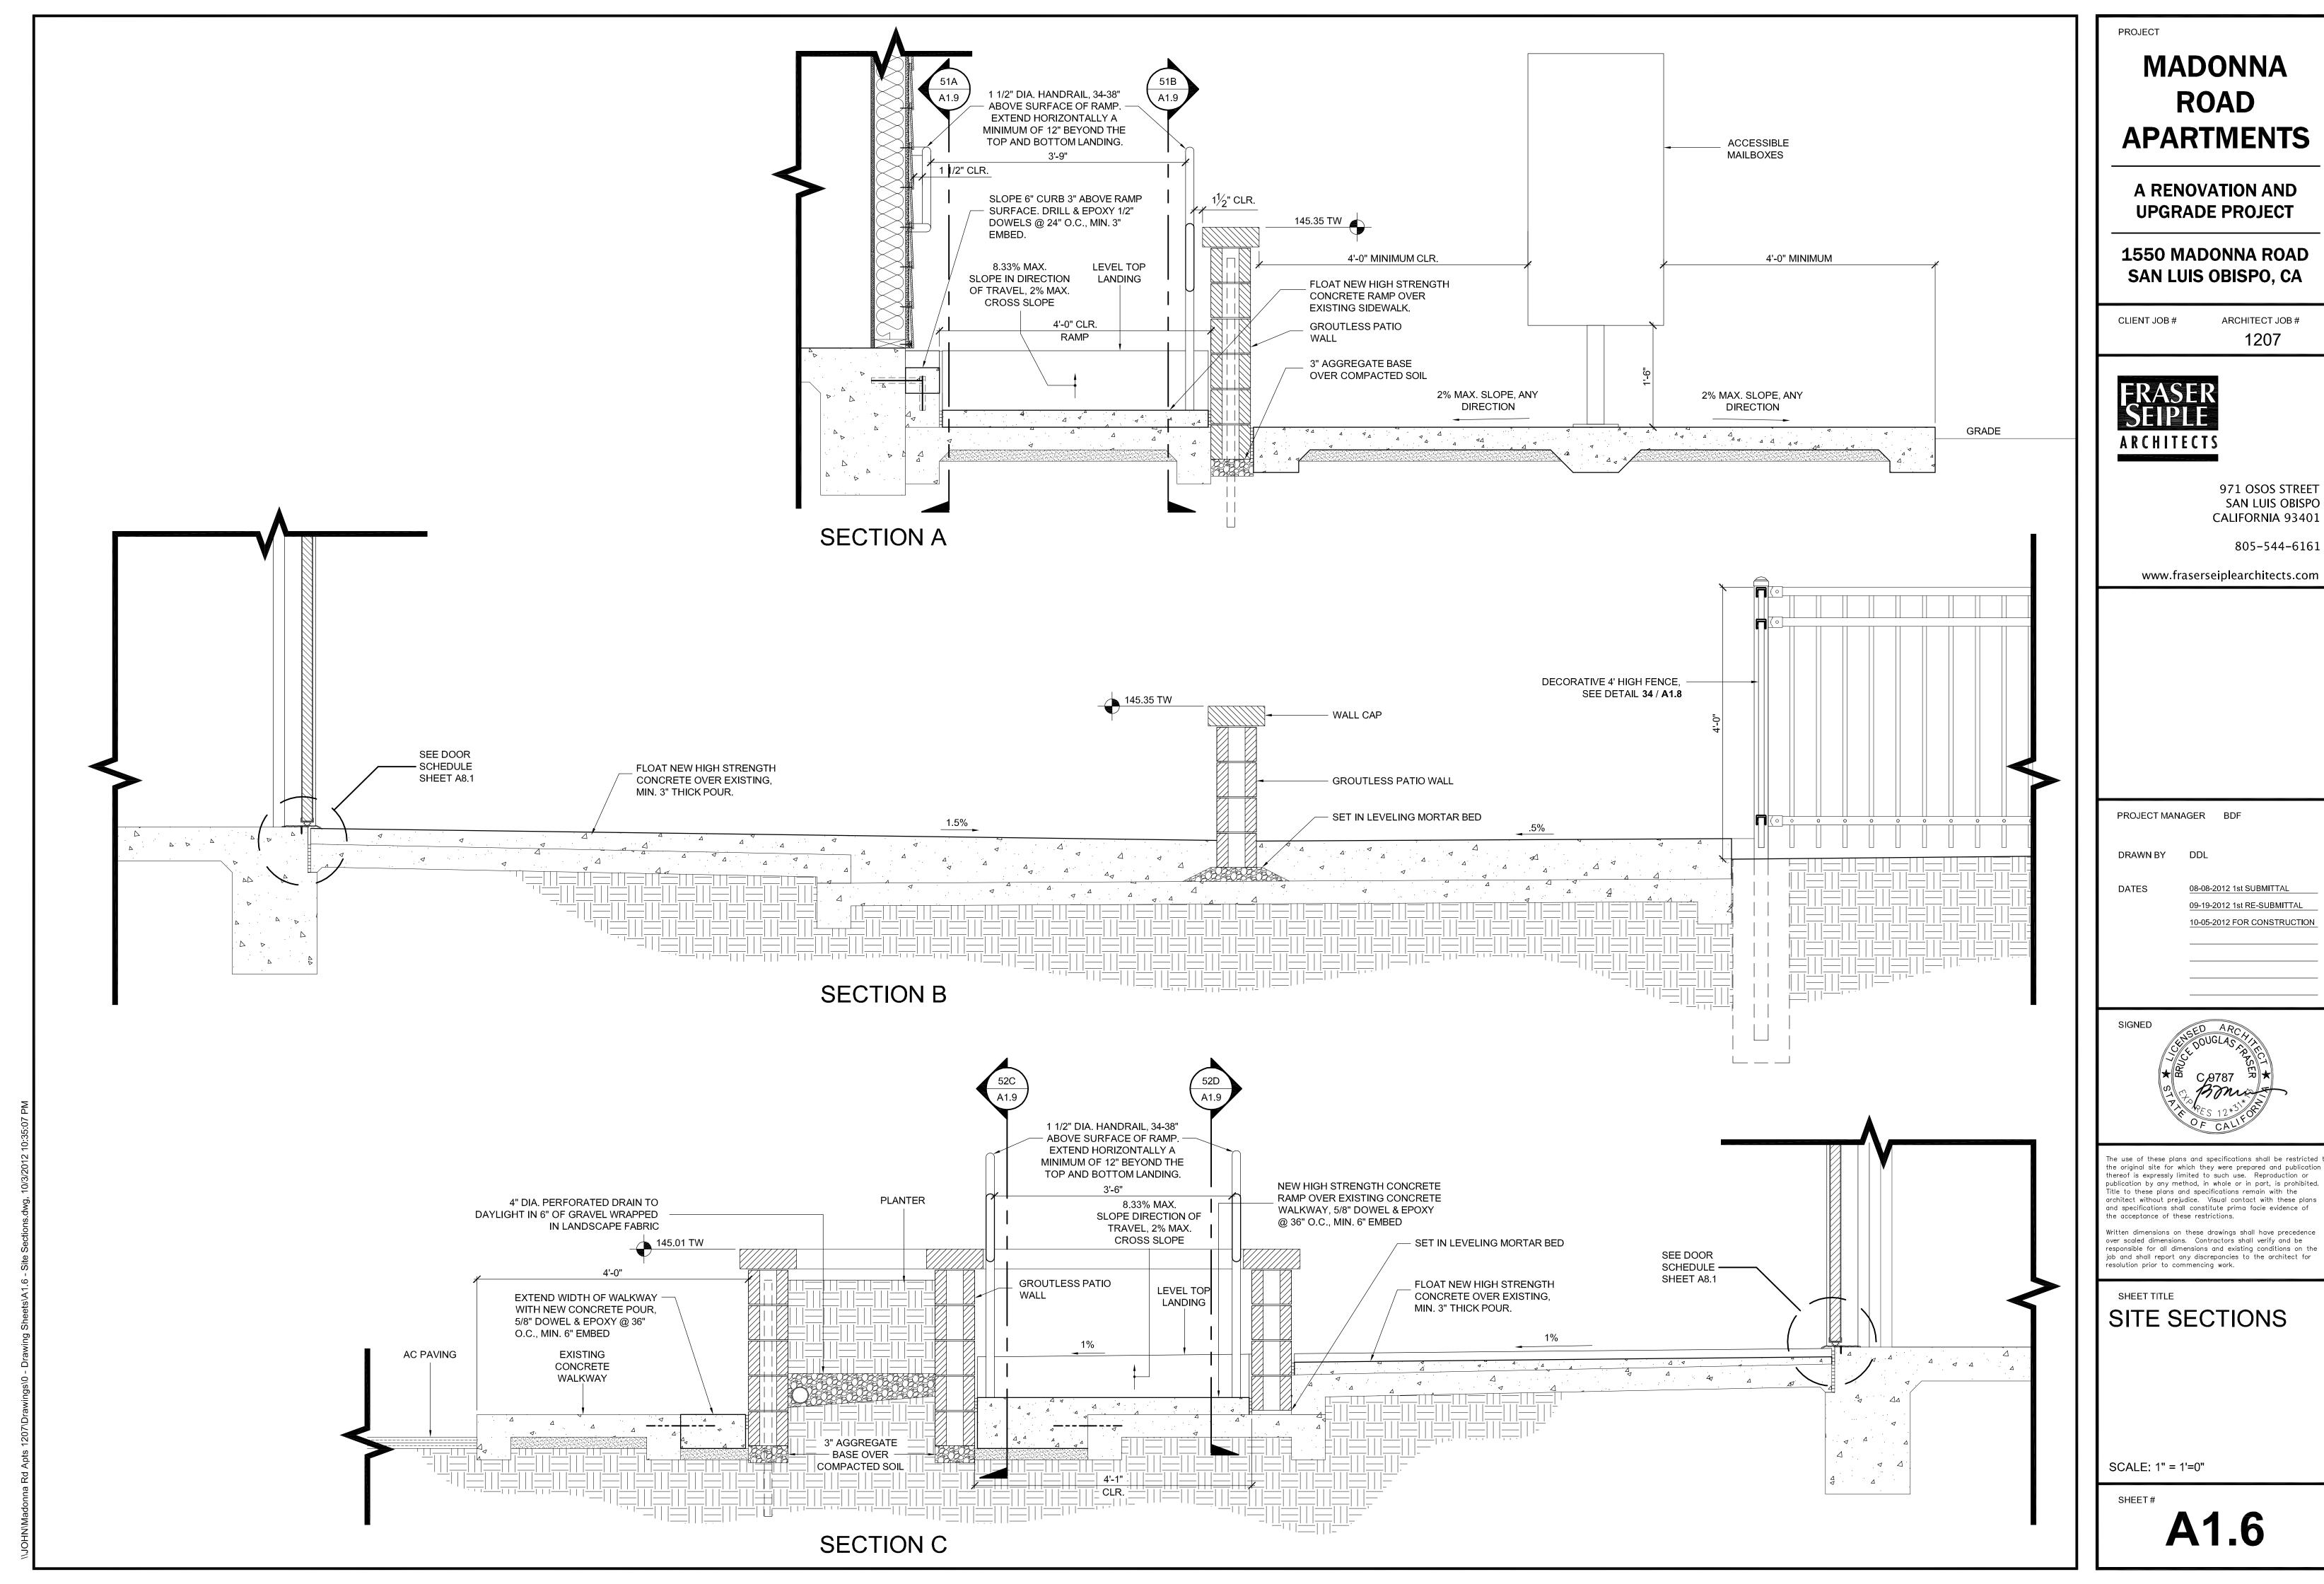

www.fraserseiplearchitects.com

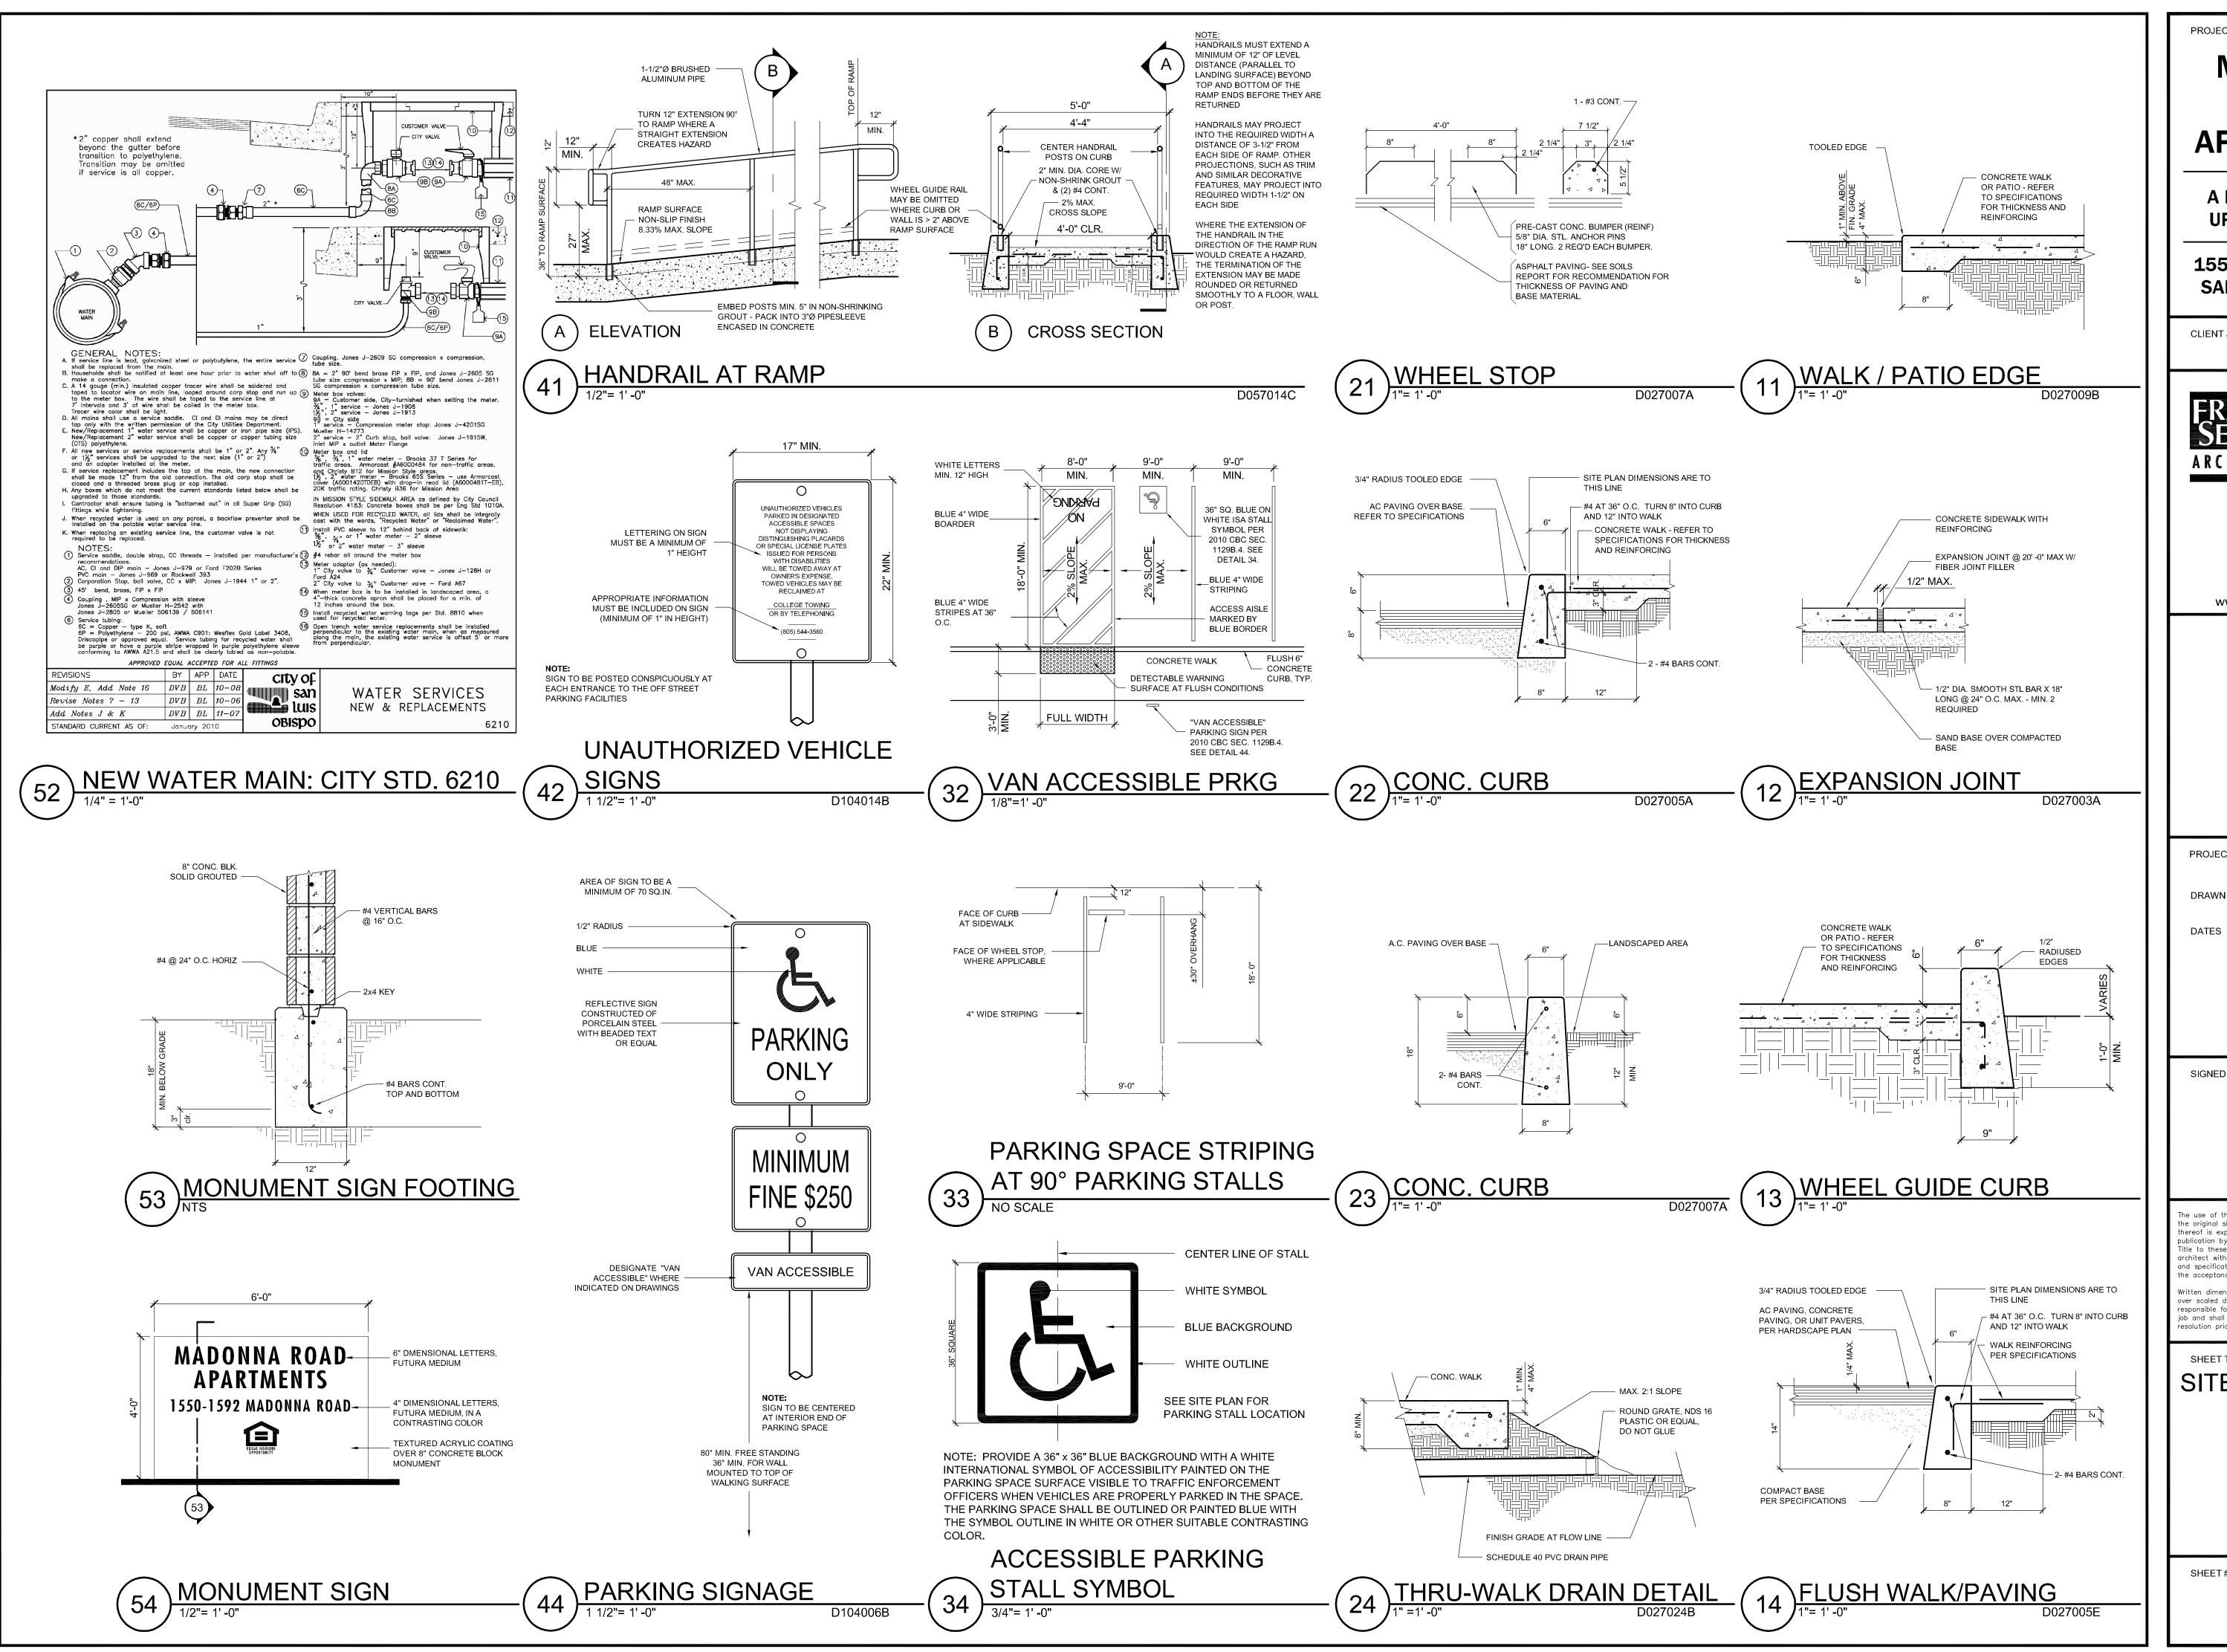

MADONNA ROAD **APARTMENTS**

A RENOVATION AND **UPGRADE PROJECT**

1550 MADONNA ROAD SAN LUIS OBISPO, CA

CLIENT JOB#

1207

ARCHITECT JOB#



971 OSOS STREET SAN LUIS OBISPO CALIFORNIA 93401

805-544-6161

www.fraserseiplearchitects.com

PROJECT MANAGER BDF

DRAWN BY DDL


08-08-2012 1st SUBMITTAL 09-19-2012 1st RE-SUBMITTAL

10-05-2012 FOR CONSTRUCTION

The use of these plans and specifications shall be restricted the original site for which they were prepared and publication nereof is expressly limited to such use. Reproduction or publication by any method, in whole or in part, is prohibited Fitle to these plans and specifications remain with the architect without prejudice. Visual contact with these plans and specifications shall constitute prima facie evidence of e acceptance of these restrictions.

Written dimensions on these drawings shall have precedence over scaled dimensions. Contractors shall verify and be esponsible for all dimensions and existing conditions on the job and shall report any discrepancies to the architect for resolution prior to commencing work.

SITE DETAILS

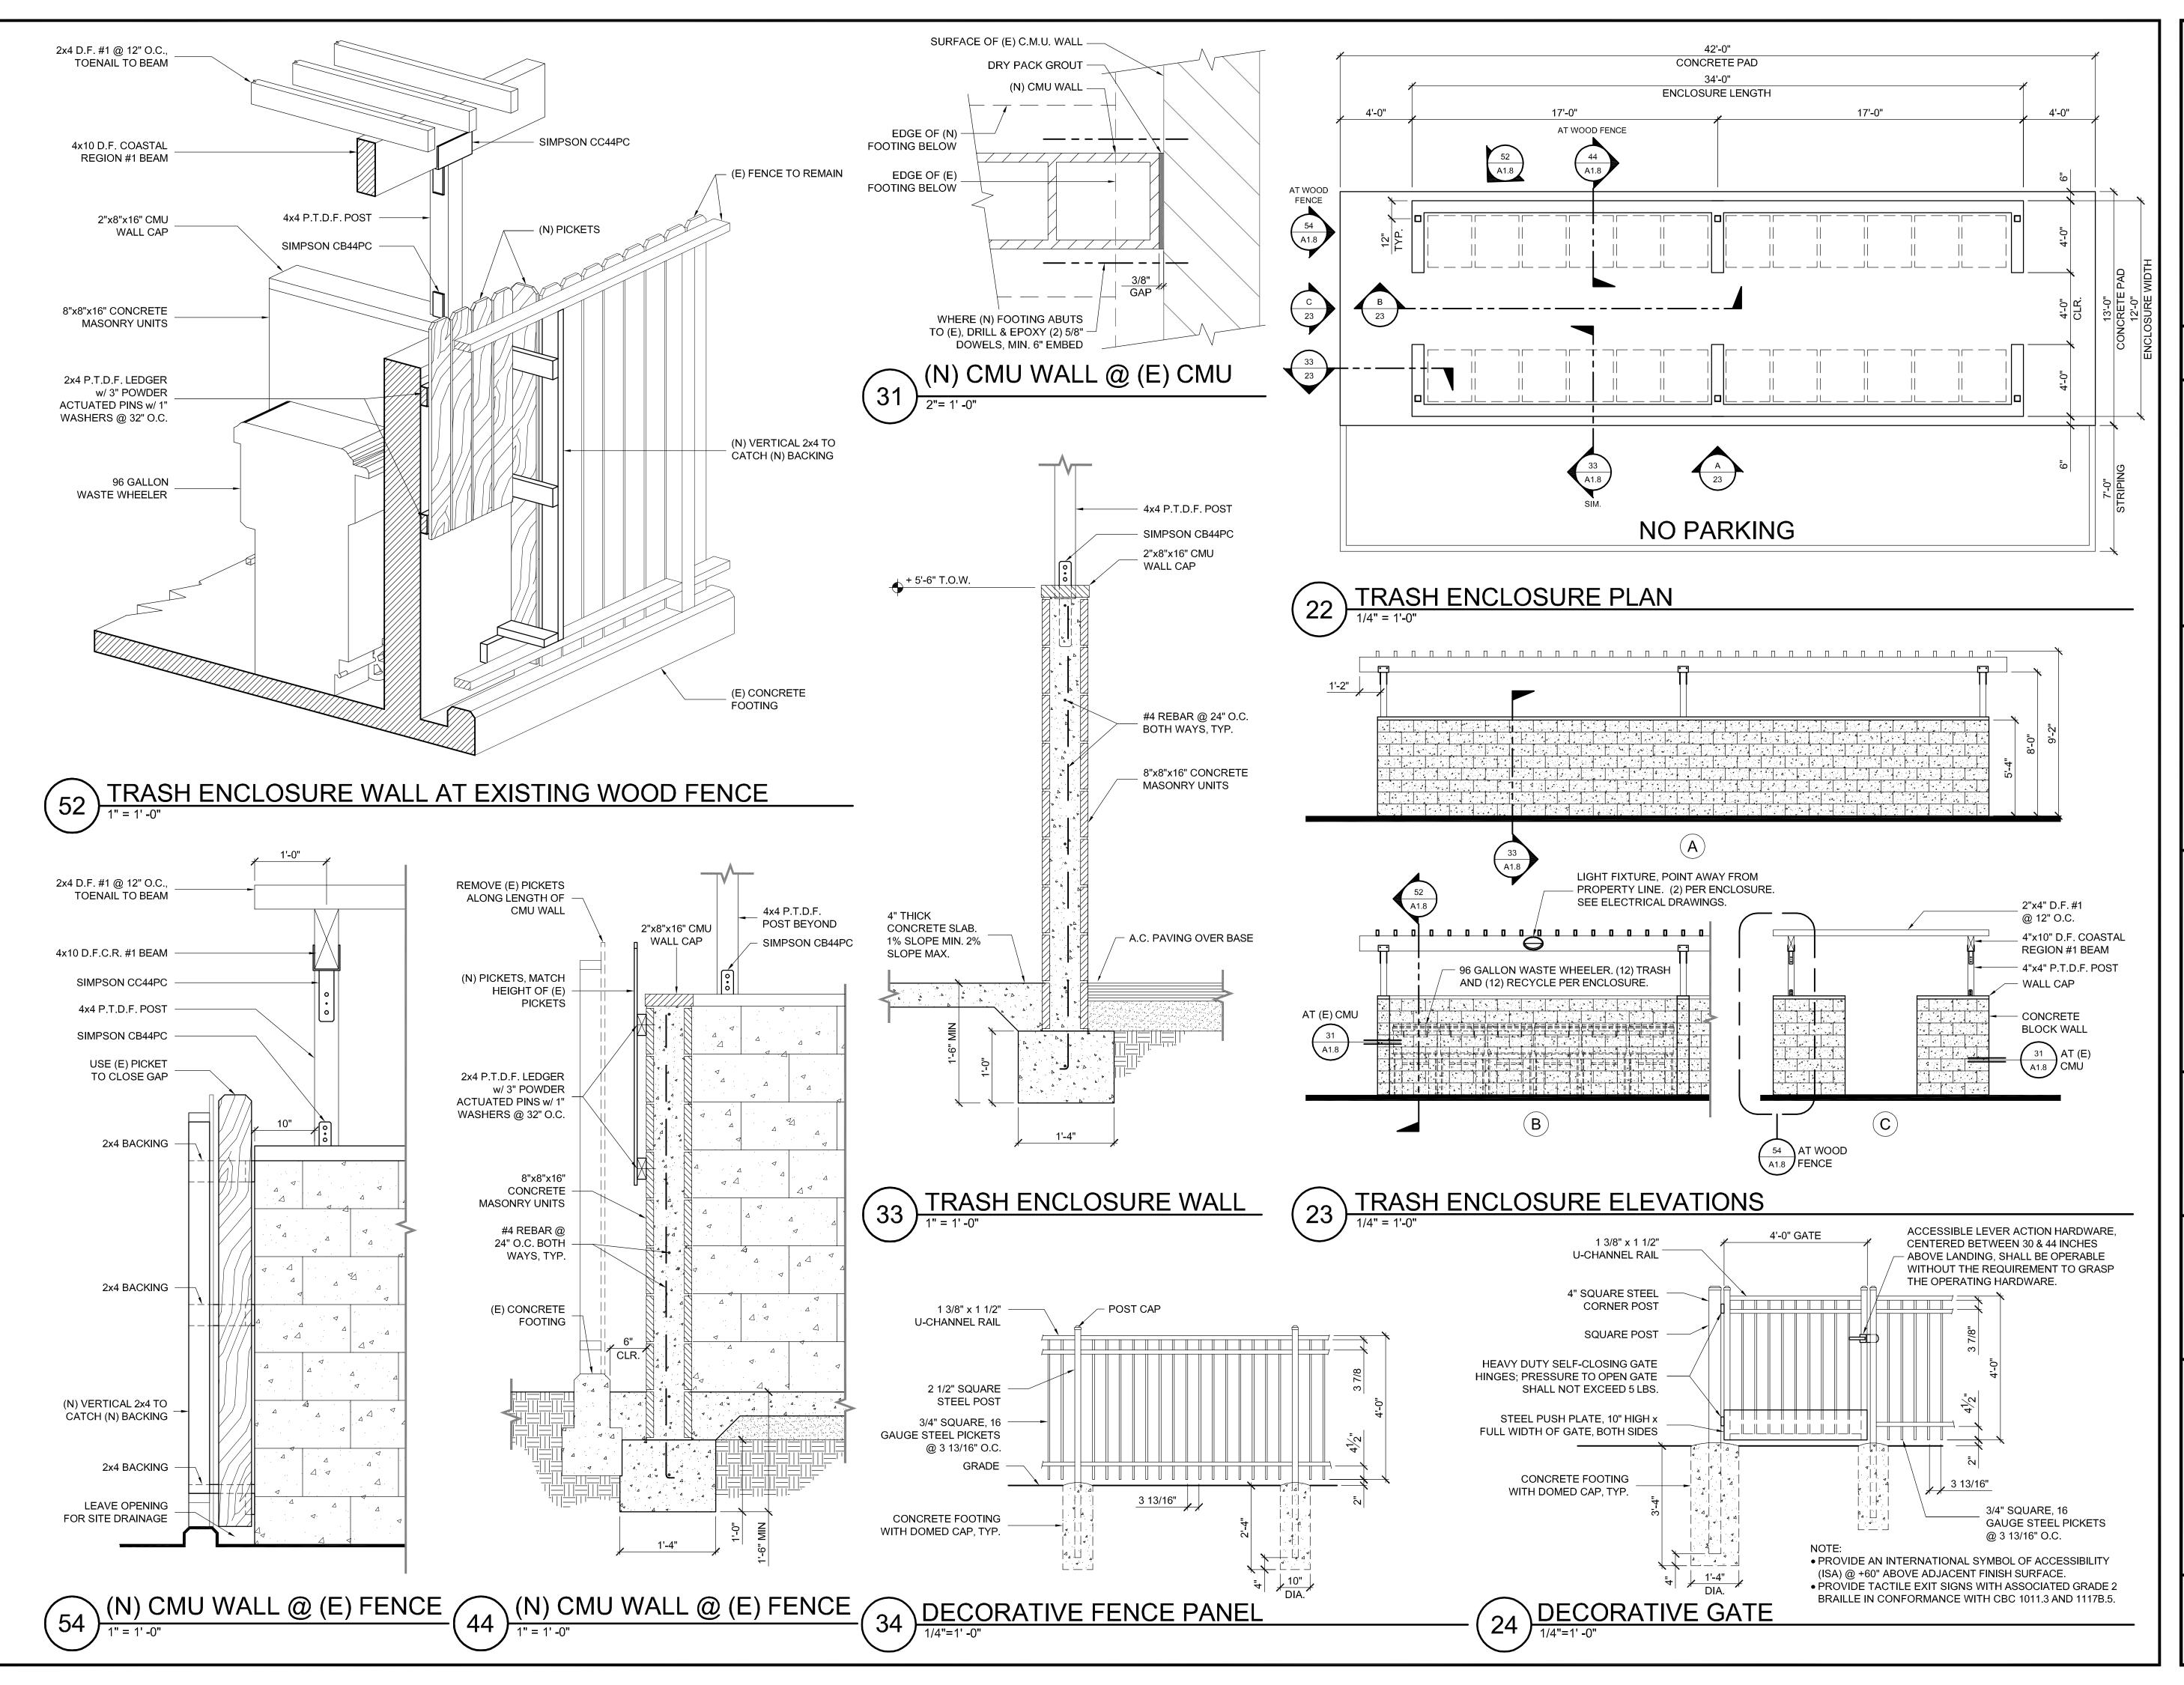

MADONNA ROAD APARTMENTS

A RENOVATION AND UPGRADE PROJECT

1550 MADONNA ROAD SAN LUIS OBISPO, CA

CLIENT JOB# ARCHITECT JOB# 1207



971 OSOS STREET SAN LUIS OBISPO CALIFORNIA 93401

805-544-6161

www.fraserseiplearchitects.com

PROJECT MANAGER BDF

DRAWN BY DDL

08-08-2012 1st SUBMITTAL
09-19-2012 1st RE-SUBMITTAL
10-05-2012 FOR CONSTRUCTION

SIGNED

SIGNED

ARCA

OUGLAS

FROM

C 9787

R

FROM

F


The use of these plans and specifications shall be restricted the original site for which they were prepared and publication thereof is expressly limited to such use. Reproduction or publication by any method, in whole or in part, is prohibited. Title to these plans and specifications remain with the architect without prejudice. Visual contact with these plans and specifications shall constitute prima facie evidence of the acceptance of these restrictions.

written dimensions on these drawings shall have precedence over scaled dimensions. Contractors shall verify and be responsible for all dimensions and existing conditions on the job and shall report any discrepancies to the architect for resolution prior to commencing work.

SHEET TITLE

SITE DETAILS

SHFFT#

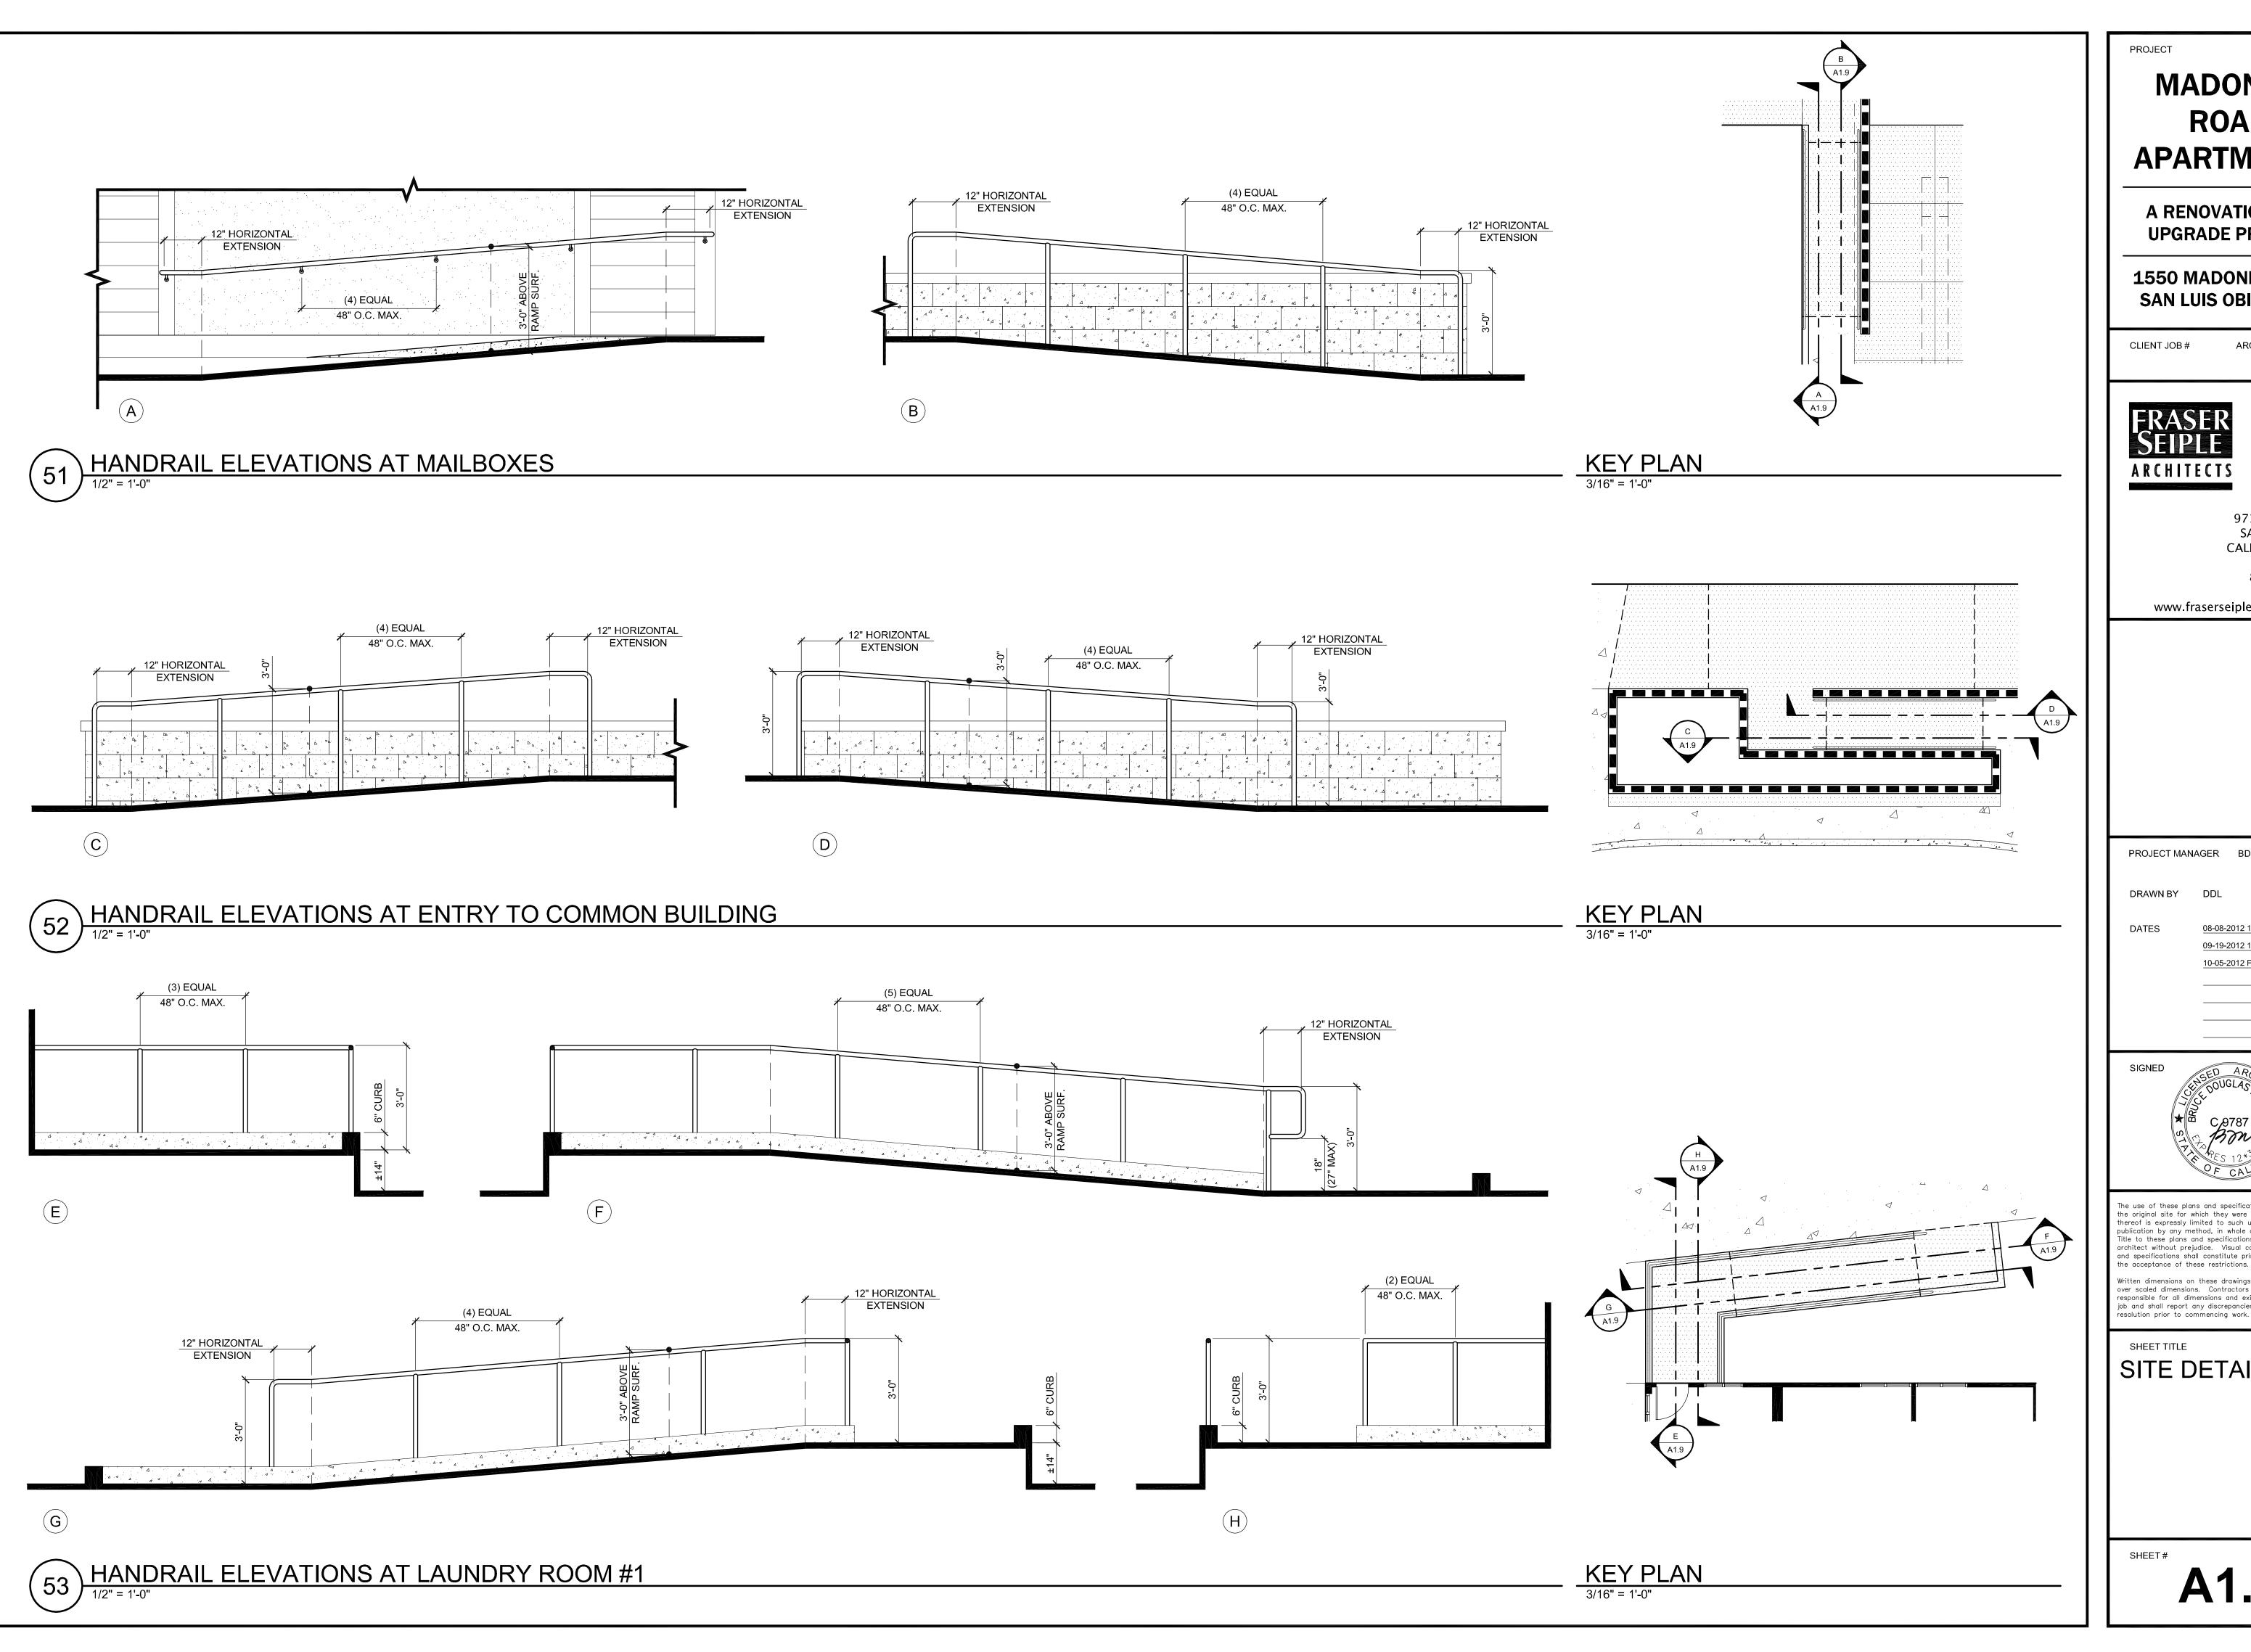

MADONNA ROAD APARTMENTS

A RENOVATION AND **UPGRADE PROJECT**

1550 MADONNA ROAD SAN LUIS OBISPO, CA

CLIENT JOB#

ARCHITECT JOB# 1207



971 OSOS STREET SAN LUIS OBISPO CALIFORNIA 93401

805-544-6161

www.fraserseiplearchitects.com

PROJECT MANAGER BDF


DRAWN BY DDL


08-08-2012 1st SUBMITTAL 09-19-2012 1st RE-SUBMITTAL 10-05-2012 FOR CONSTRUCTION

The use of these plans and specifications shall be restricted the original site for which they were prepared and publication thereof is expressly limited to such use. Reproduction or publication by any method, in whole or in part, is prohibited. Title to these plans and specifications remain with the architect without prejudice. Visual contact with these plans and specifications shall constitute prima facie evidence of


Written dimensions on these drawings shall have precedence over scaled dimensions. Contractors shall verify and be responsible for all dimensions and existing conditions on the job and shall report any discrepancies to the architect for resolution prior to commencing work.

SITE DETAILS

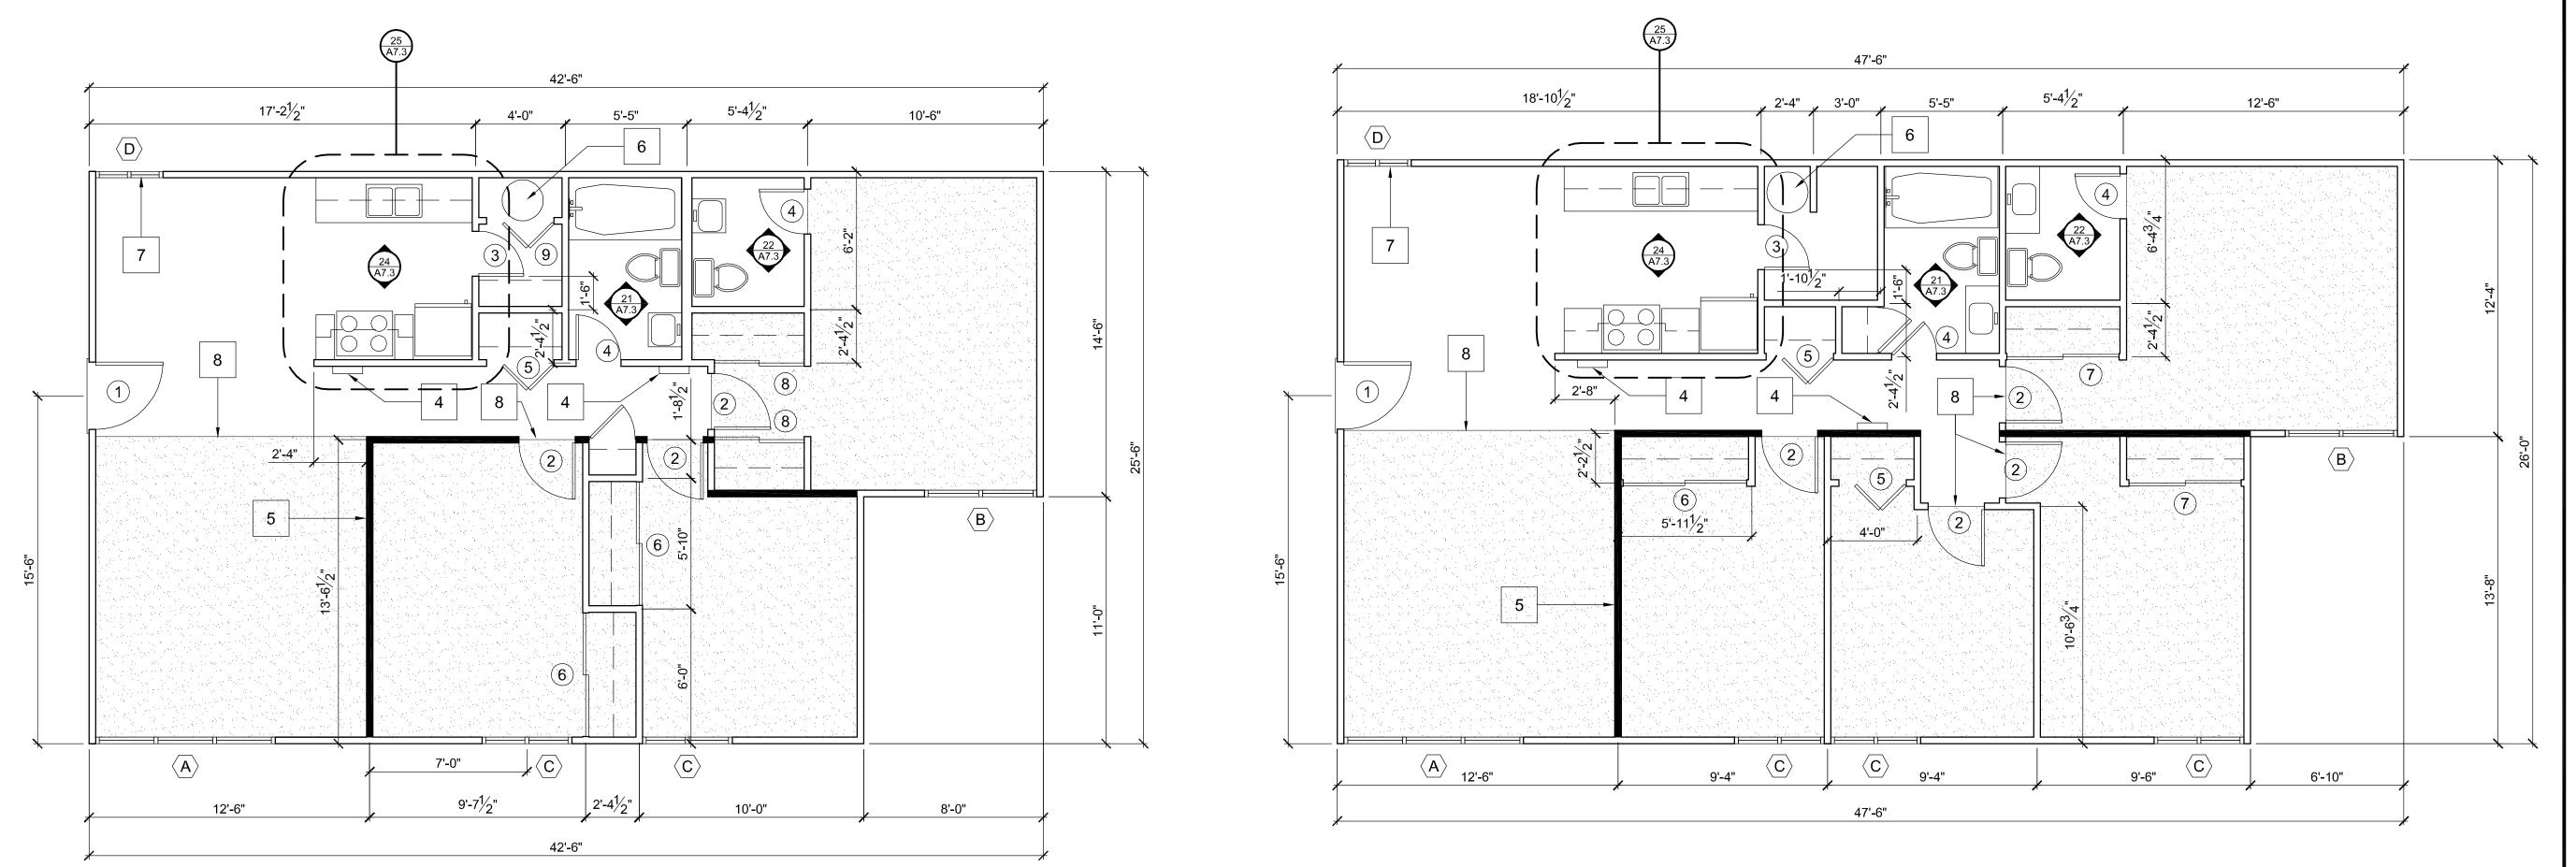

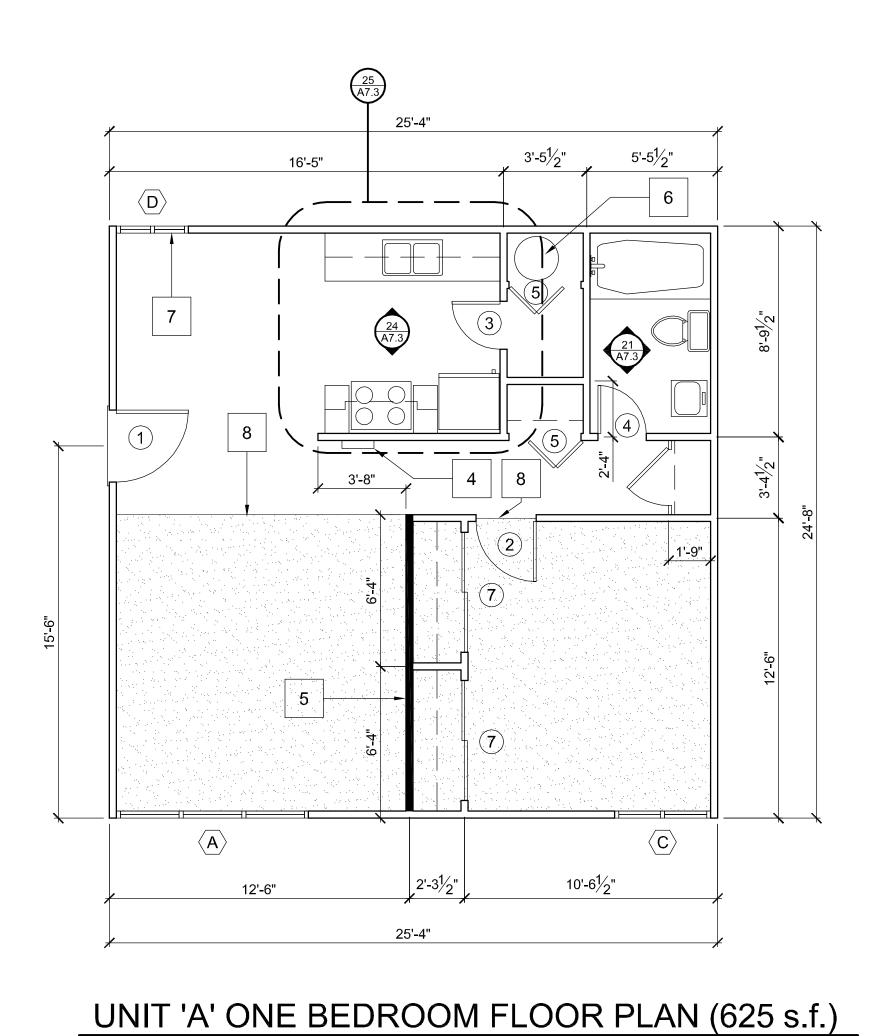

UNIT 'C' THREE BEDROOM FLOOR PLAN (996 s.f.)

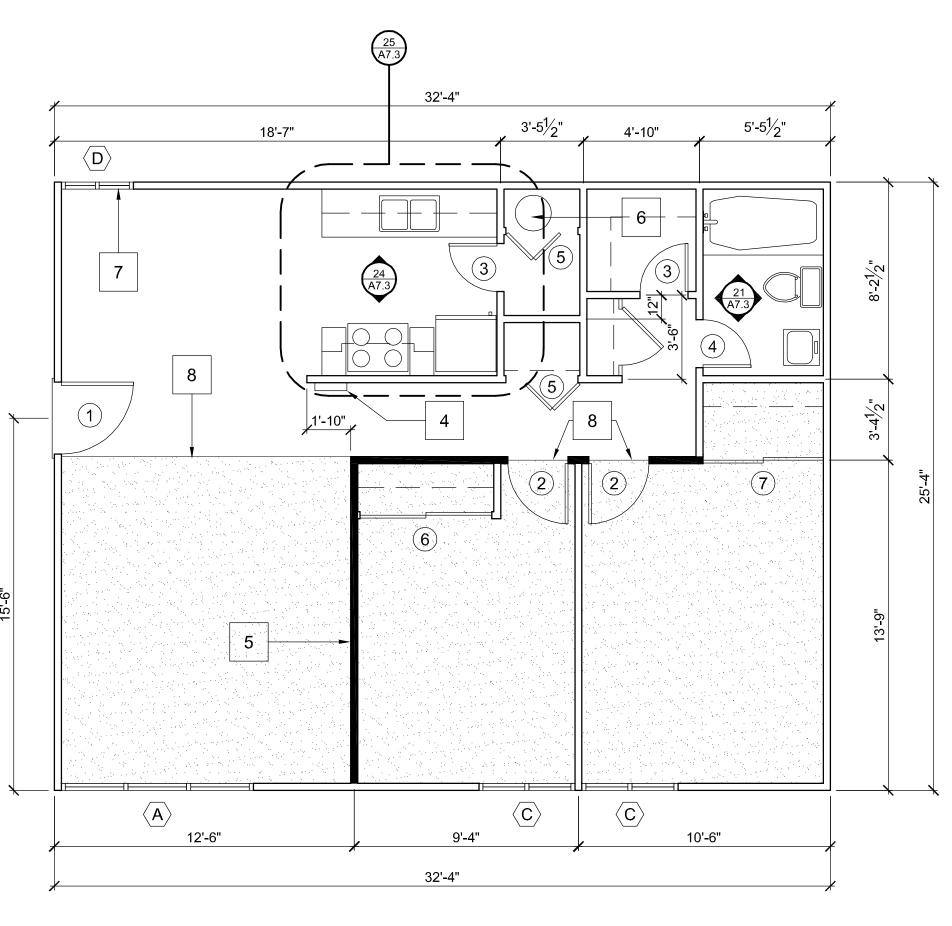

UNIT 'D' FOUR BEDROOM FLOOR PLAN (1,142 s.f.)

1 1'-10"	4	8	3'-472"
5	6		13'-9"
A 12'-6"	9'-4"	C 10'-6"	
	32'-4"		

UNIT 'B' TWO BEDROOM FLOOR PLAN (820 s.f.)

UNIT	TYPE	QUANTITY
A B C	ONE BEDROOM TWO BEDROOM THREE BEDROOM	20 44 40
D	FOUR BEDROOM	<u>16</u> 120

- X SEE DOOR SCHEDULE SHEET A8.1
- X SEE WINDOW SCHEDULE SHEET A8.1

UNIT PLAN KEYNOTES

- 1. REFER TO CONTRACTOR'S UNIT MATRIX FOR UNIT-BY-UNIT DESCRIPTION OF WORK.
- 2. SEE MECHANICAL, PLUMBING AND ELECTRICAL DRAWINGS FOR EXTENT OF WORK IN RESTROOMS AND KITCHENS.
- 3. REFER TO DOOR, WINDOW AND FINISH SCHEDULES ON SHEET A8.1
- 4. EXISTING WALL FURNACE.
- 5. EXISTING BEARING WALLS (SHOWN SOLID FILLED).
- 6. ALL WATER HEATER COMPARTMENTS HAVE THROUGH-WALL COMBUSTION AIR VENTS AT TOP AND
- 7. AT EVERY DINING ROOM WINDOW REMOVE EXISTING WINDOW AND FILL FRAME ABOVE AND BELOW TO SET NEW WINDOW HEAD AT 6'-8" TO MATCH (E) ADJACENT
- 8. PATTERN INDICATES EXTENT OF (E) CARPET TO REMAIN. CUT CARPET AND INSTALL TRANSITION STRIPS PER DETAIL **51 / A10.1**.

MADONNA ROAD APARTMENTS

A RENOVATION AND **UPGRADE PROJECT**

1550 MADONNA ROAD SAN LUIS OBISPO, CA



971 OSOS STREET SAN LUIS OBISPO CALIFORNIA 93401

ARCHITECT JOB#

1207


805-544-6161

www.fraserseiplearchitects.com

PROJECT MANAGER BDF

DRAWN BY DDL

08-08-2012 1st SUBMITTAL 09-19-2012 1st RE-SUBMITTAL 10-05-2012 FOR CONSTRUCTION

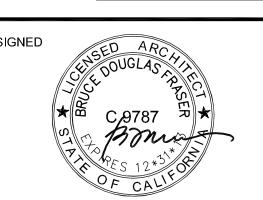

The use of these plans and specifications shall be restricted the original site for which they were prepared and publication thereof is expressly limited to such use. Reproduction or publication by any method, in whole or in part, is prohibited. Title to these plans and specifications remain with the architect without prejudice. Visual contact with these plans and specifications shall constitute prima facie evidence of e acceptance of these restrictions.


over scaled dimensions. Contractors shall verify and be responsible for all dimensions and existing conditions on the job and shall report any discrepancies to the architect for resolution prior to commencing work.

SHEET TITLE

UNIT FLOOR PLANS

(1st & 2nd FLOORS ARE IDENTICAL)


SCALE: 1/4" = 1'=0"

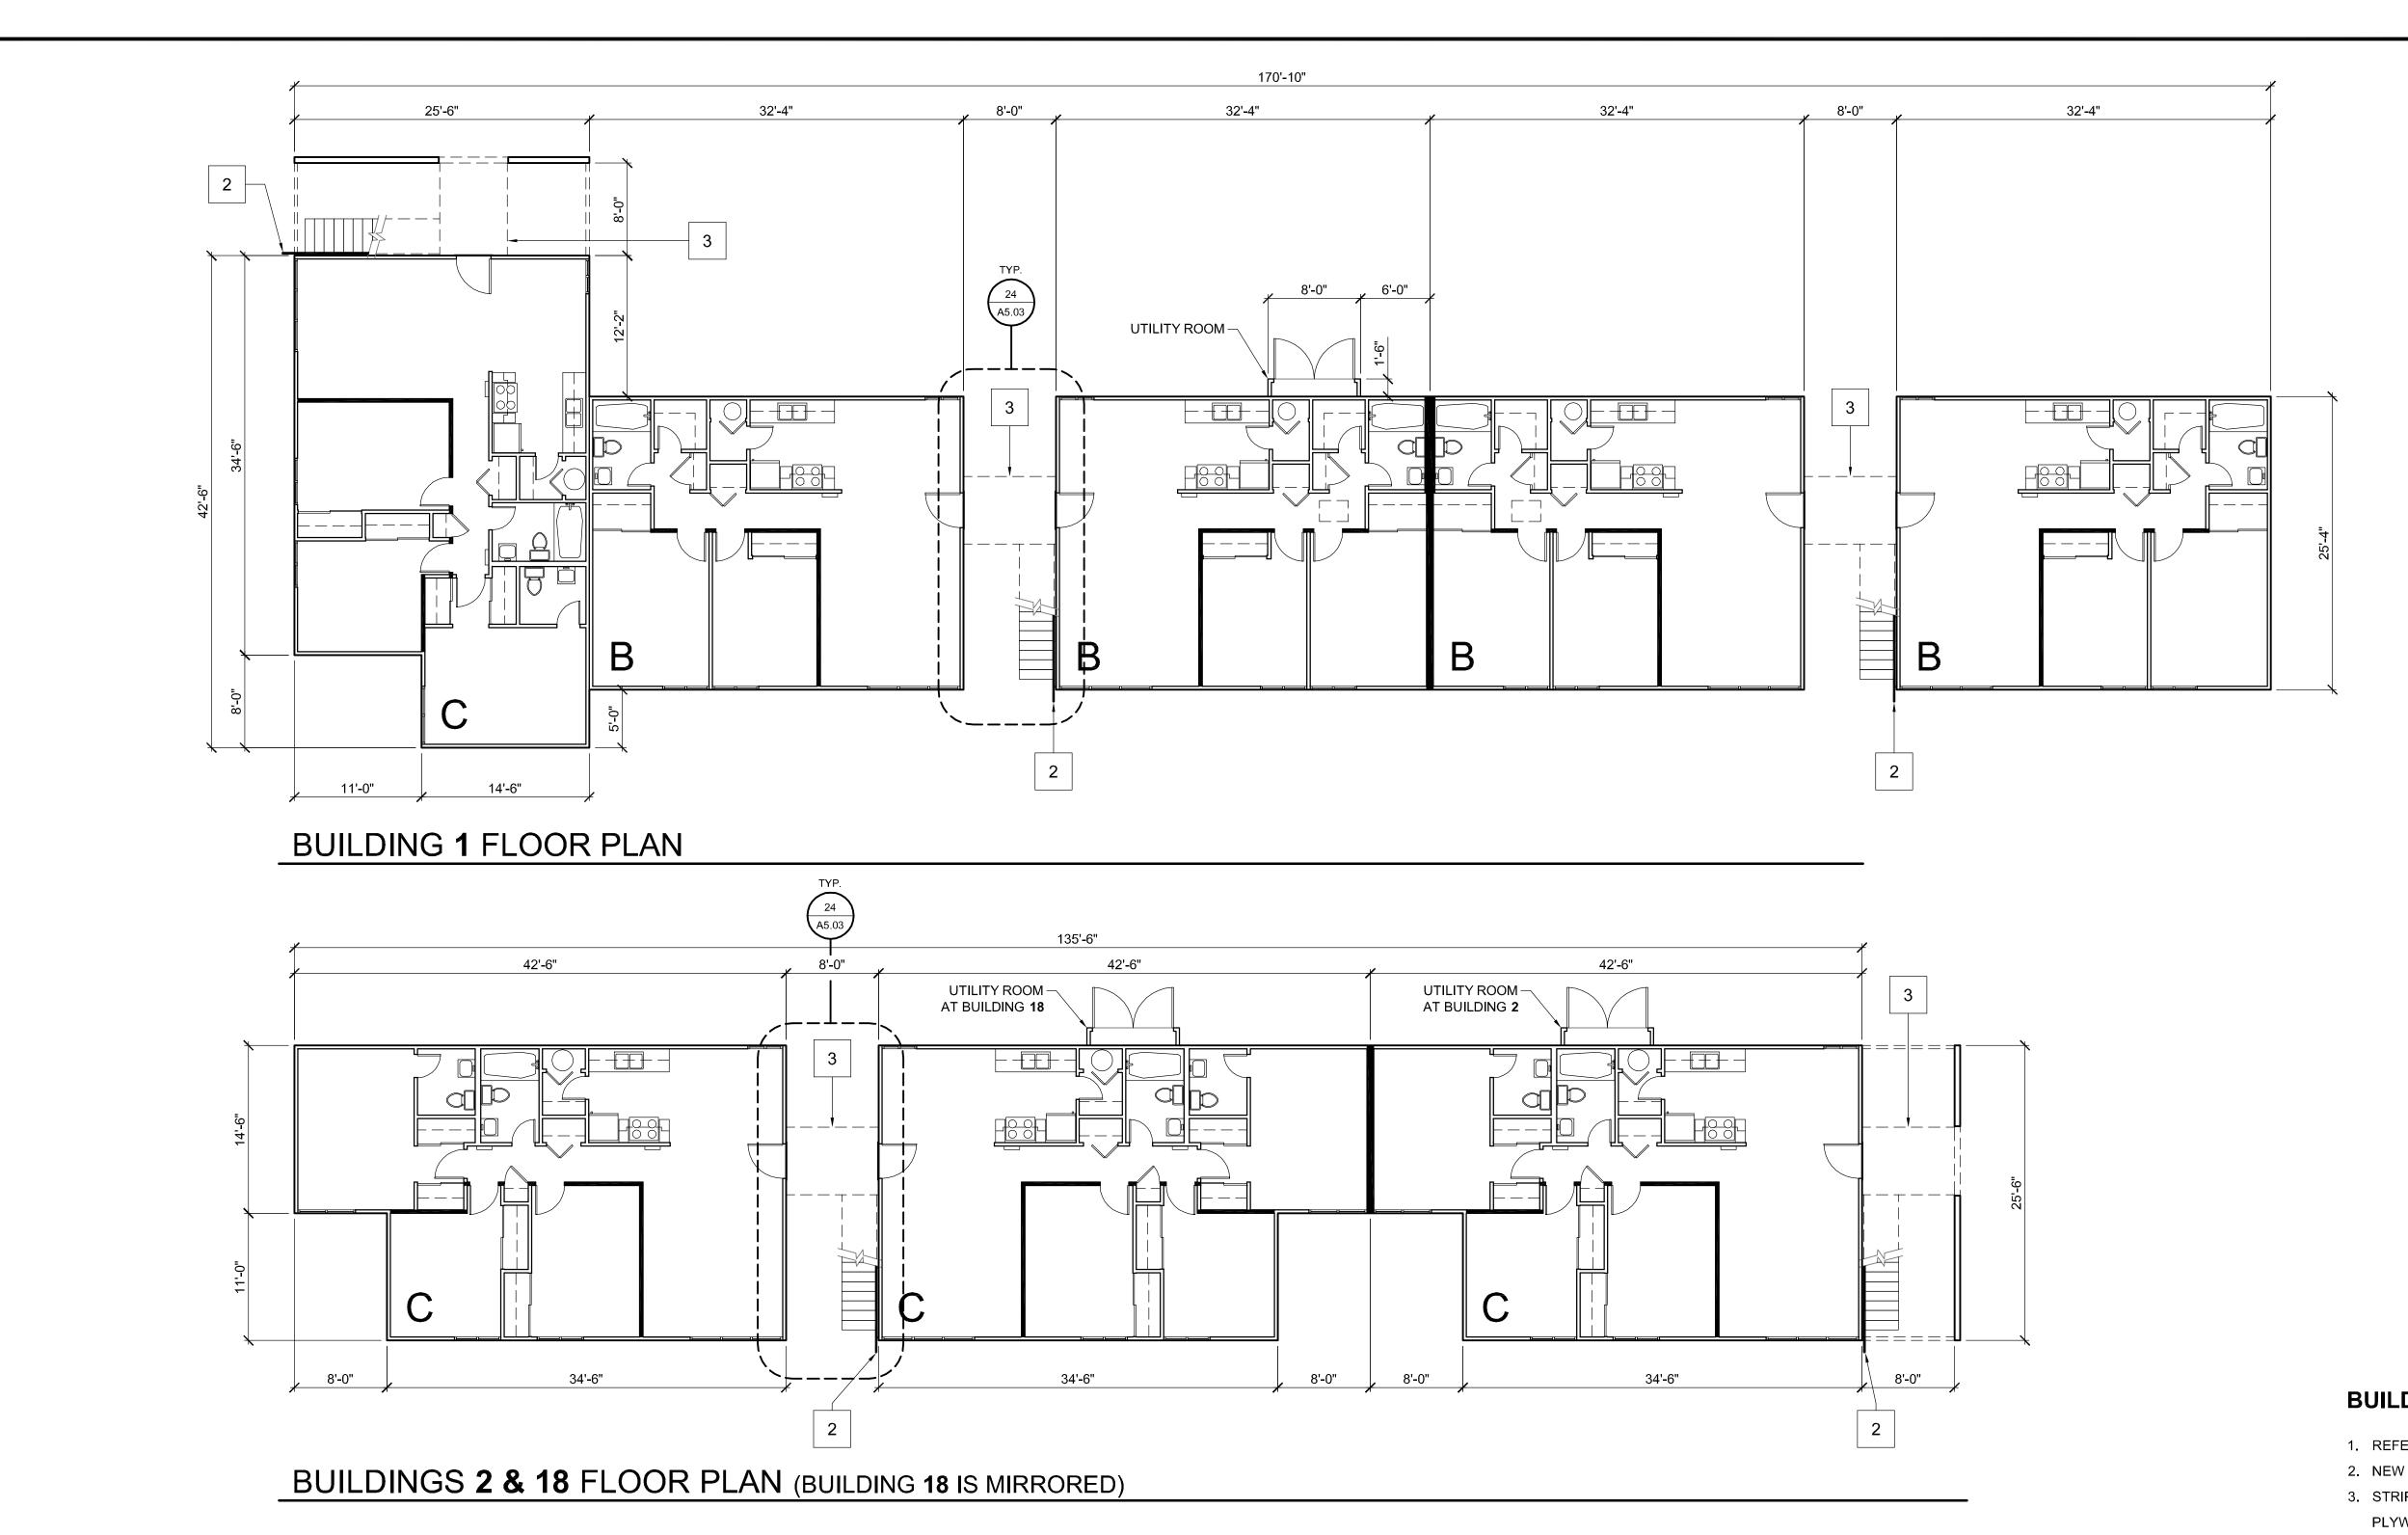

BUILDING PLAN KEYNOTES

- 1. REFER TO SHEET A2.01 FOR UNIT FLOOR PLANS.
- 2. NEW WALL MOUNTED HANDRAIL. SEE 41 / A5.03.
- 3. STRIP EXISTING DECK WEATHERPROOFING DOWN TO PLYWOOD AND INSTALL NEW TRAFFIC COATING SYSTEM. SEE SHEET A5.04.
- 4. SEE MECHANICAL, PLUMBING AND ELECTRICAL DRAWINGS FOR EXTENT OF WORK IN RESTROOMS AND KITCHENS.
- 5. REFER TO DOOR, WINDOW AND FINISH SCHEDULES ON SHEET A8.1

BUILDING KEY PLAN

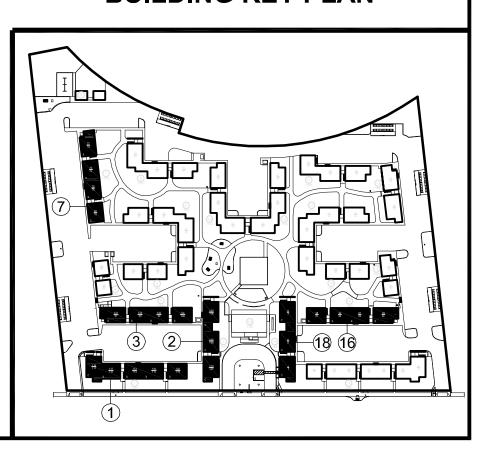

MADONNA ROAD APARTMENTS

A RENOVATION AND **UPGRADE PROJECT**

1550 MADONNA ROAD SAN LUIS OBISPO, CA

ARCHITECT JOB# 1207



971 OSOS STREET SAN LUIS OBISPO CALIFORNIA 93401

805-544-6161

www.fraserseiplearchitects.com

PROJECT MANAGER BDF

DRAWN BY DDL

08-08-2012 1st SUBMITTAL 10-05-2012 FOR CONSTRUCTION

he original site for which they were prepared and publication thereof is expressly limited to such use. Reproduction or publication by any method, in whole or in part, is prohibited. Title to these plans and specifications remain with the

e acceptance of these restrictions.


architect without prejudice. Visual contact with these plans and specifications shall constitute prima facie evidence of


over scaled dimensions. Contractors shall verify and be responsible for all dimensions and existing conditions on the job and shall report any discrepancies to the architect for resolution prior to commencing work.

BUILDING FLOOR PLANS **1,2,3,7,16,18**

(1st & 2nd FLOORS ARE IDENTICAL)

SCALE: 1/8" = 1'=0"

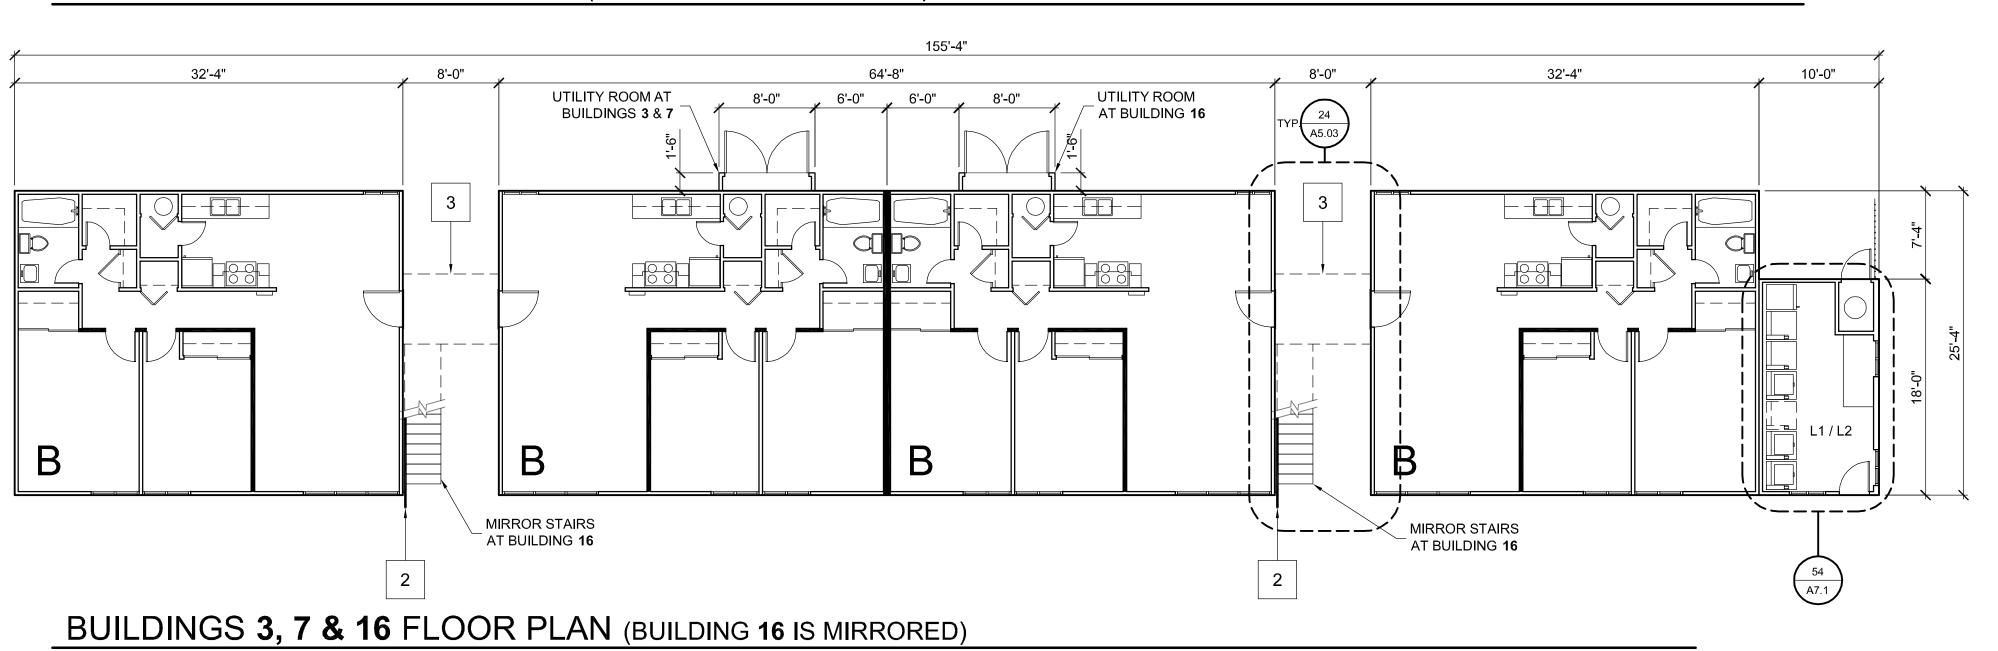

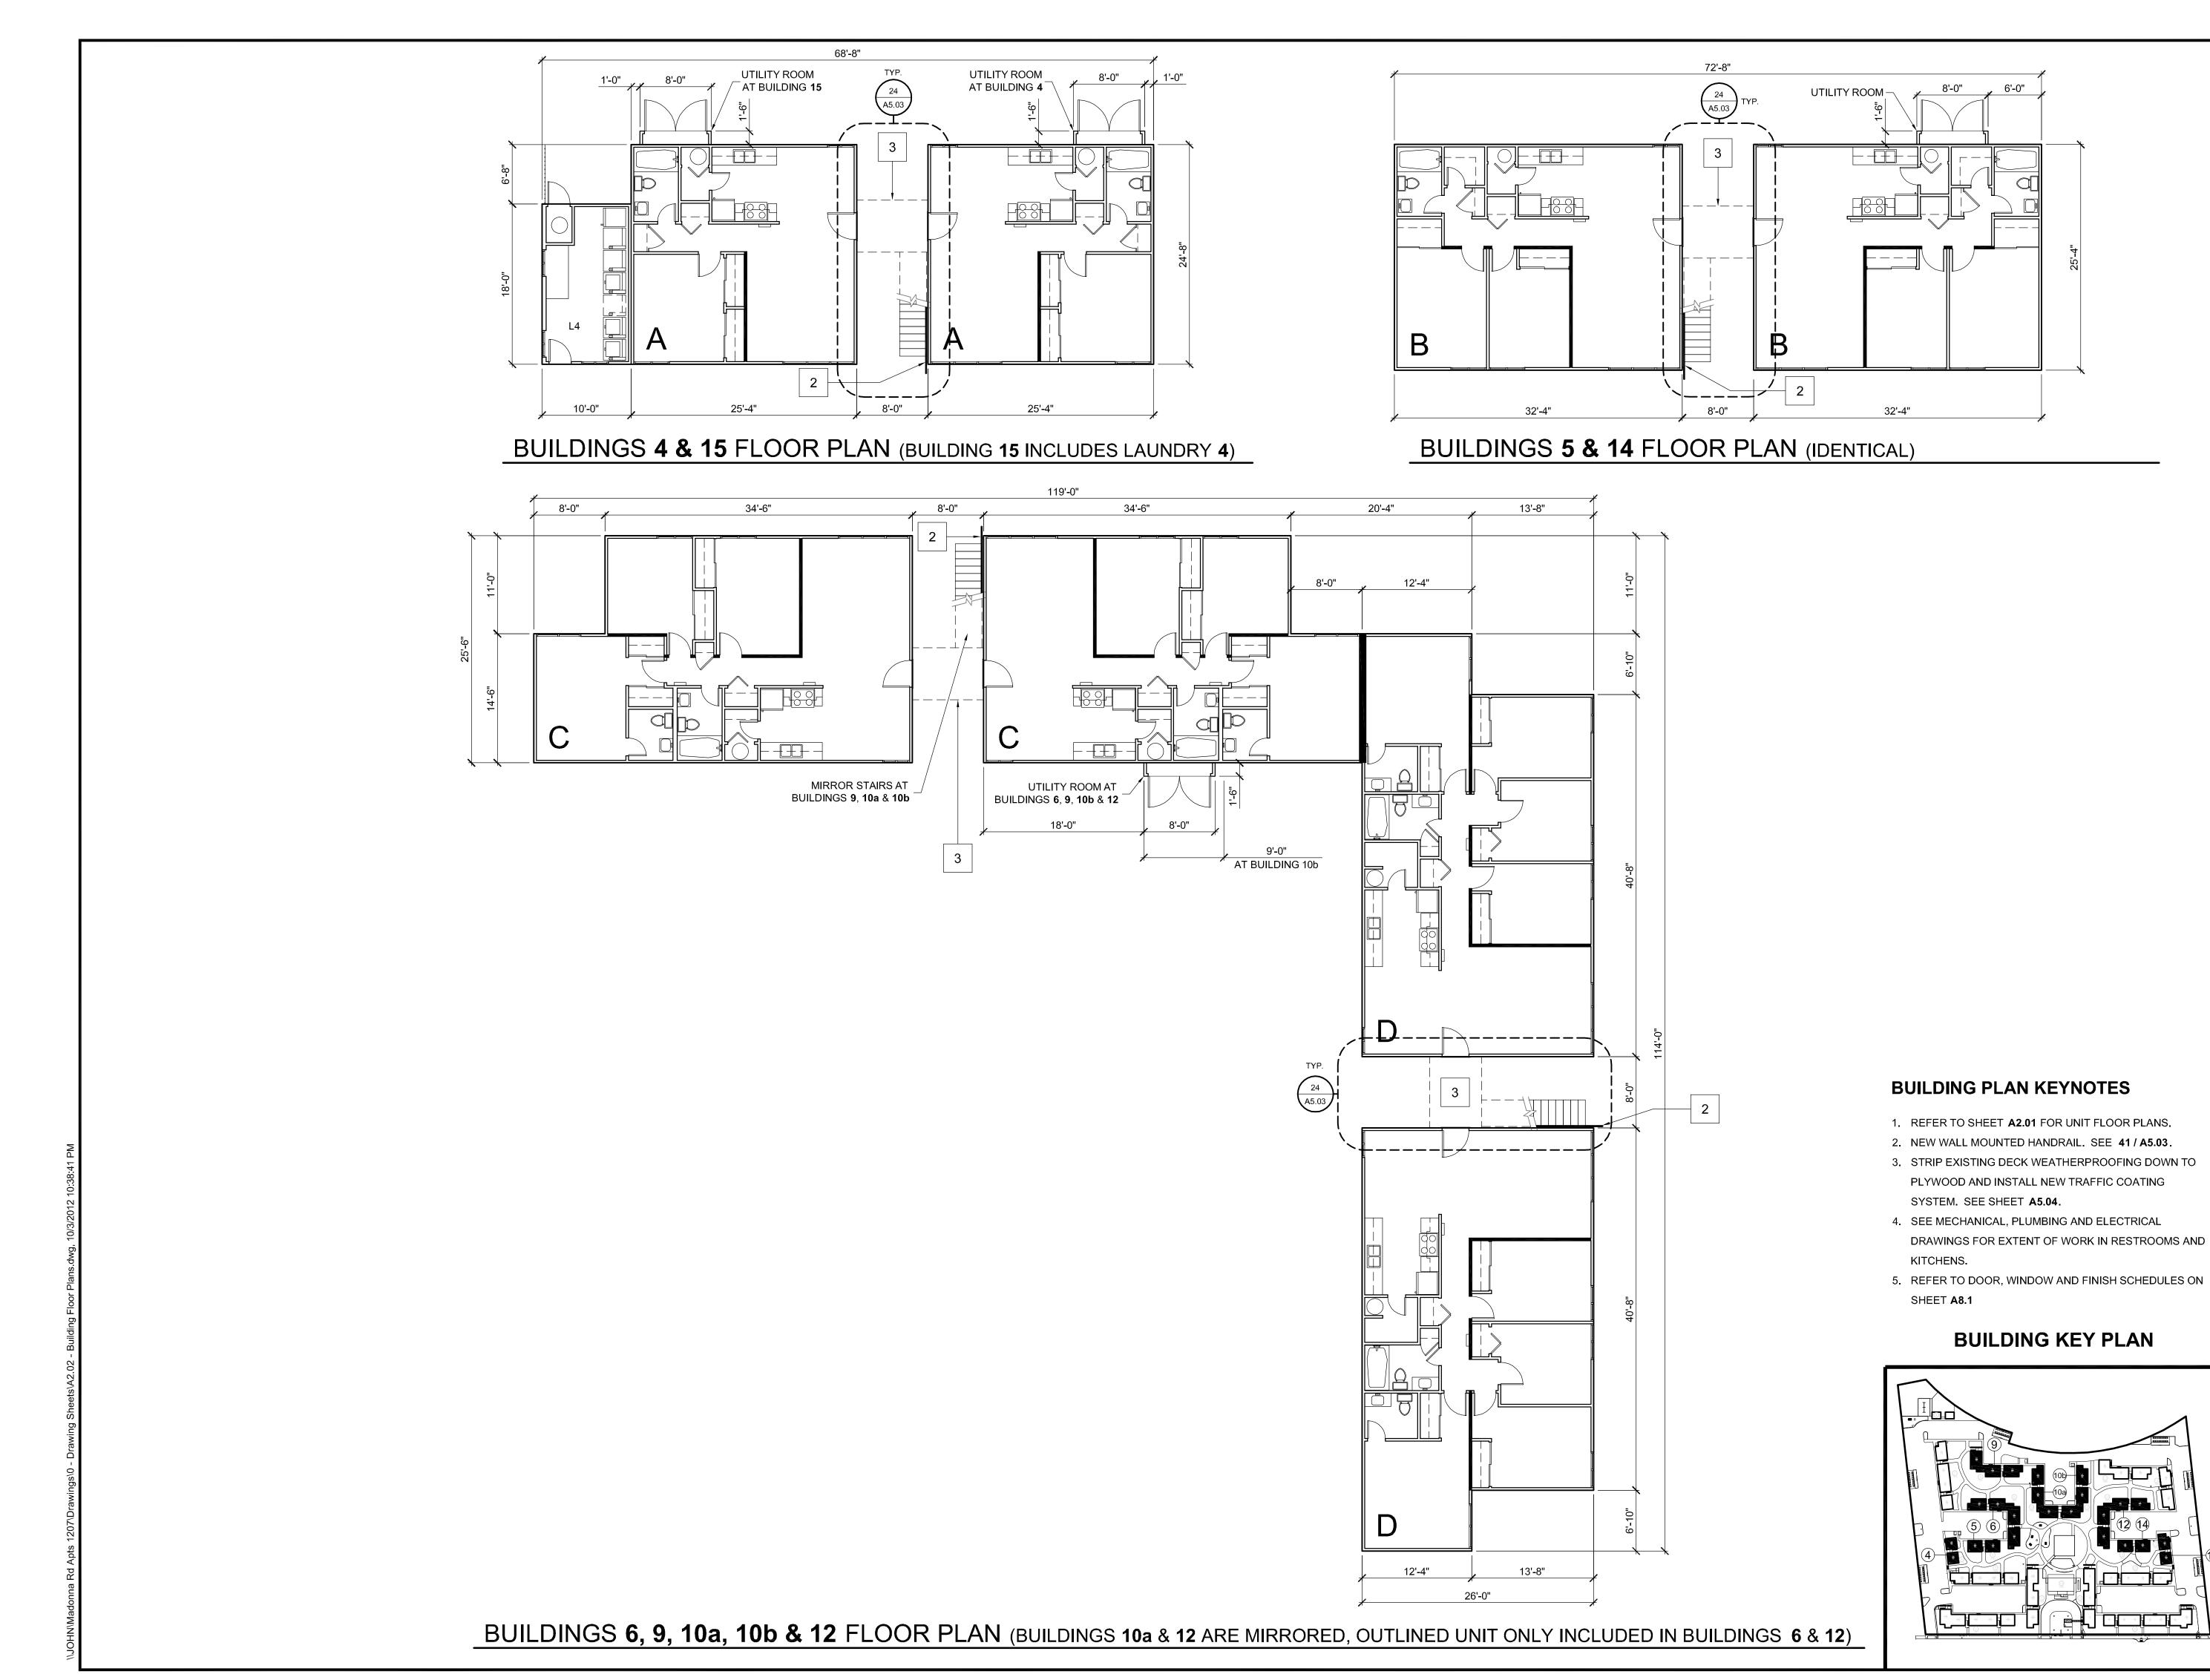

PROJE

MADONNA ROAD APARTMENTS

A RENOVATION AND UPGRADE PROJECT

1550 MADONNA ROAD SAN LUIS OBISPO, CA

CLIENT JOB#

ARCHITECT JOB#
1207



971 OSOS STREET SAN LUIS OBISPO CALIFORNIA 93401

805-544-6161

www.fraserseiplearchitects.com


PROJECT MANAGER BDF

DRAWN BY DDL

ATES (

08-08-2012 1st SUBMITTAL
09-19-2012 1st RE-SUBMITTAL
10-05-2012 FOR CONSTRUCTION

10-05-2012 FOR CONSTRUCTION

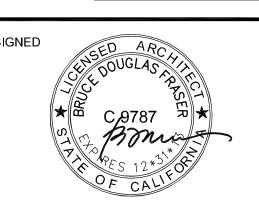

The use of these plans and specifications shall be restricted the original site for which they were prepared and publication thereof is expressly limited to such use. Reproduction or publication by any method, in whole or in part, is prohibited. Title to these plans and specifications remain with the architect without prejudice. Visual contact with these plans and specifications shall constitute prima facie evidence of

over scaled dimensions. Contractors shall verify and be responsible for all dimensions and existing conditions on the job and shall report any discrepancies to the architect for resolution prior to commencing work.

e acceptance of these restrictions.


SHEET TITLE

BUILDING FLOOR PLANS **4,5,6,9,10a,10b,**

12,14,15
(1st & 2nd FLOORS ARE IDENTICAL)

SCALE: 1/8" = 1'=0"

SHFFT#

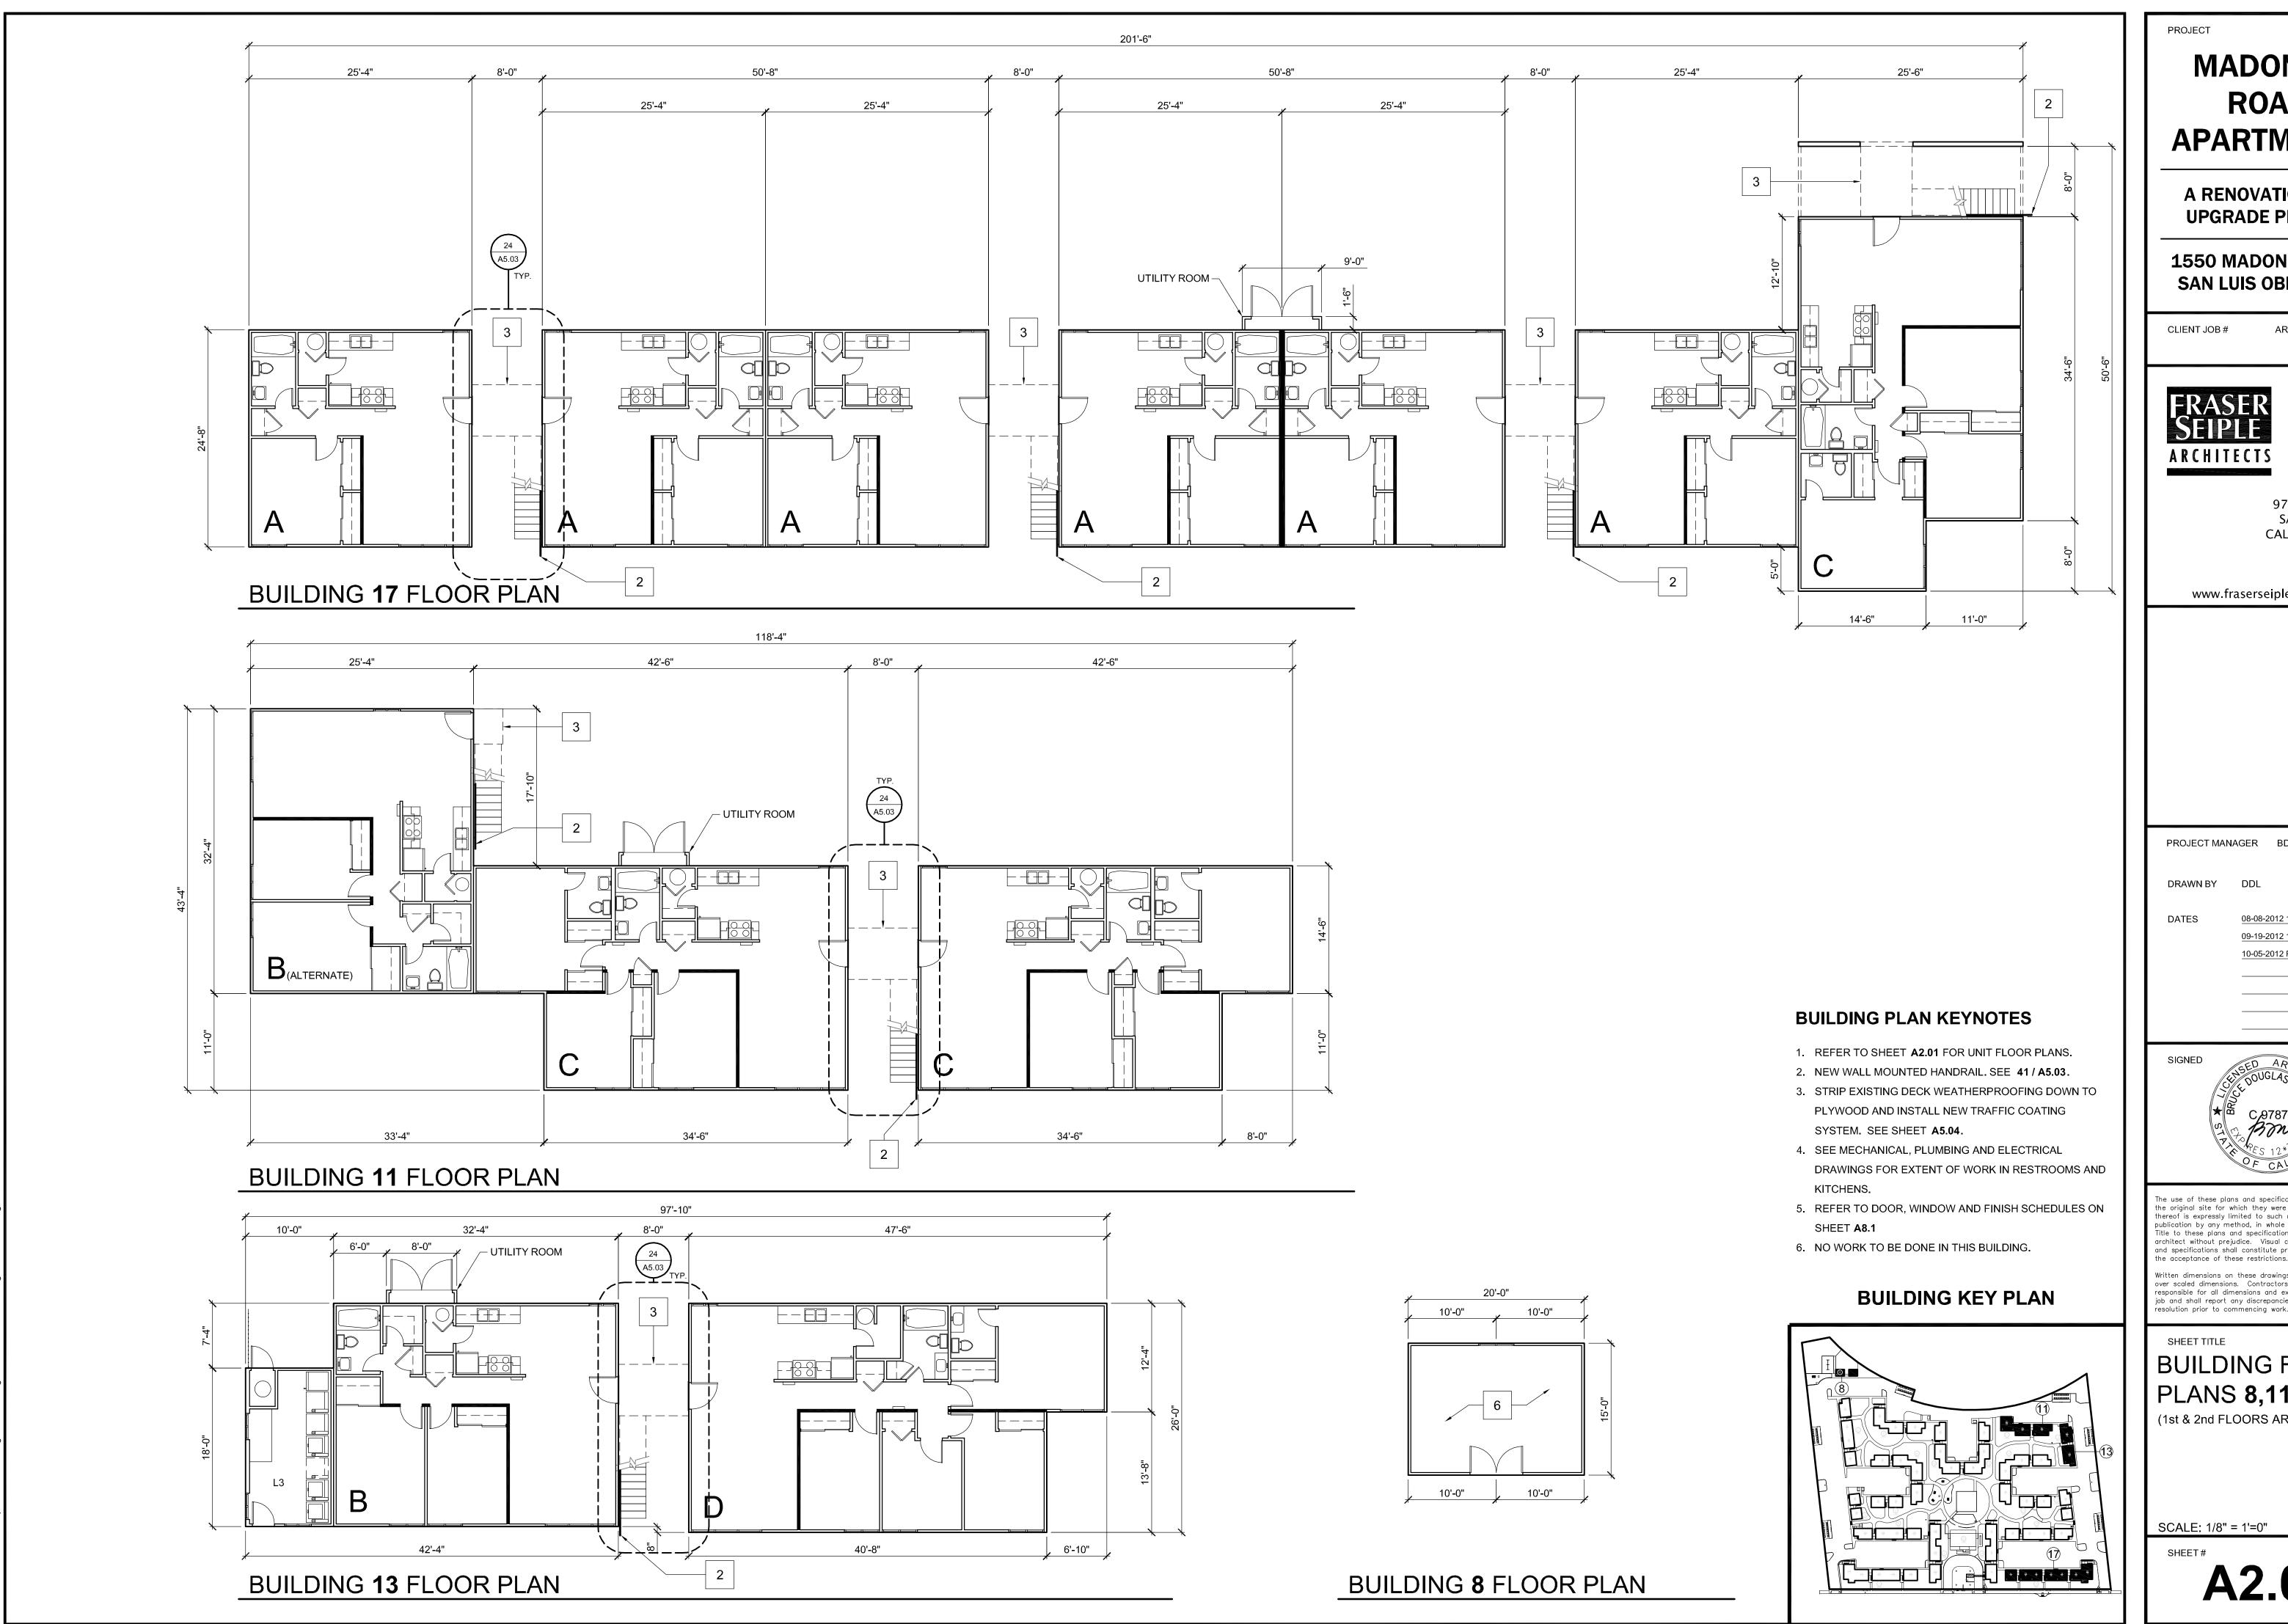

MADONNA ROAD APARTMENTS

A RENOVATION AND **UPGRADE PROJECT**

1550 MADONNA ROAD SAN LUIS OBISPO, CA

ARCHITECT JOB# CLIENT JOB#

1207



971 OSOS STREET SAN LUIS OBISPO CALIFORNIA 93401

805-544-6161

www.fraserseiplearchitects.com

PROJECT MANAGER BDF

DRAWN BY DDL

08-08-2012 1st SUBMITTAL 09-19-2012 1st RE-SUBMITTAL 10-05-2012 FOR CONSTRUCTION




the original site for which they were prepared and publication thereof is expressly limited to such use. Reproduction or publication by any method, in whole or in part, is prohibited. Title to these plans and specifications remain with the architect without prejudice. Visual contact with these plans and specifications shall constitute prima facie evidence of

over scaled dimensions. Contractors shall verify and be responsible for all dimensions and existing conditions on the job and shall report any discrepancies to the architect for resolution prior to commencing work.

BUILDING FLOOR PLANS **8,11,13,17**

(1st & 2nd FLOORS ARE IDENTICAL)

SCALE: 1/8" = 1'=0"

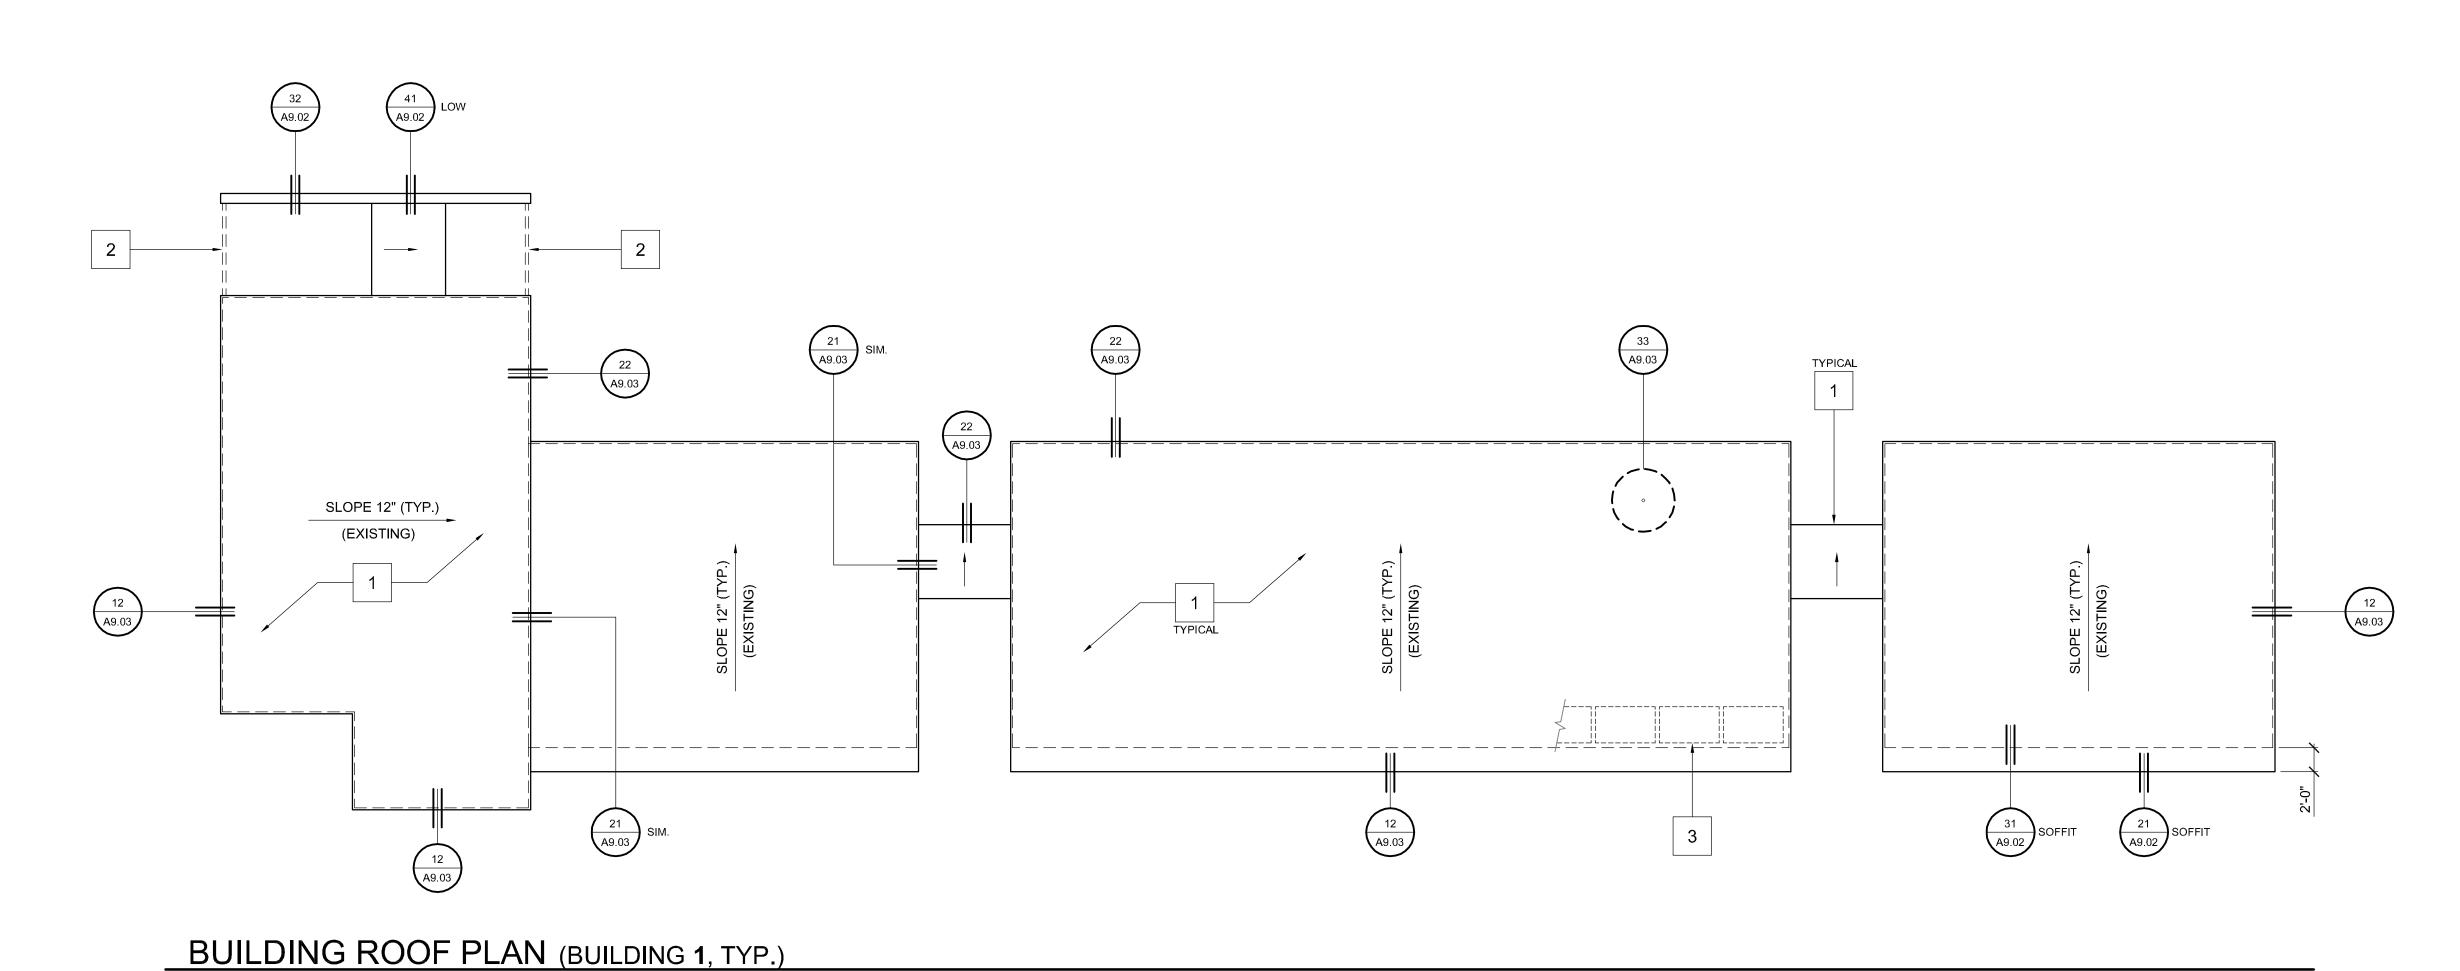


- DEMOLISH ALL (E) 4-PLY CAP SHEET ROOF SYSTEMS DOWN TO PLYWOOD SHEATHING. INSTALL NEW SINGLE-PLY ROOF MEMBRANE SYSTEM OVER 1/4" DENSDECK. SEE SHEET A9.03.
- 2. INSTALL 22 GAUGE METAL FLASHING CAPS ON ALL EXPOSED BEAMS.

ROOF PLAN KEYNOTES

3. COORDINATE LOCATION OF ROOF WALKWAY PADS IN FIELD IN CONJUNCTION WITH PHOTOVOLTAIC SYSTEM INSTALLATION.

BUILDING KEY PLAN

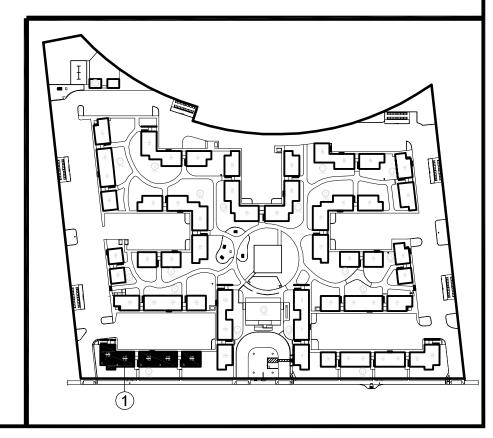

PROJ

MADONNA ROAD APARTMENTS

A RENOVATION AND UPGRADE PROJECT

1550 MADONNA ROAD SAN LUIS OBISPO, CA

CLIENT JOB#

1207

ARCHITECT JOB#



971 OSOS STREET SAN LUIS OBISPO CALIFORNIA 93401

805-544-6161

www.fraserseiplearchitects.com

PROJECT MANAGER BDF

DRAWN BY DDL

TES 08-08-2012 1st SUBMITTAL

09-19-2012 1st RE-SUBMITTAL
10-05-2012 FOR CONSTRUCTION

SED ARCHION DOUGLAS AND TO CARREST AND THE CAR

The use of these plans and specifications shall be restricted to the original site for which they were prepared and publication thereof is expressly limited to such use. Reproduction or publication by any method, in whole or in part, is prohibited. Title to these plans and specifications remain with the architect without prejudice. Visual contact with these plans and specifications shall constitute prima facie evidence of

Written dimensions on these drawings shall have precedence over scaled dimensions. Contractors shall verify and be responsible for all dimensions and existing conditions on the job and shall report any discrepancies to the architect for resolution prior to commencing work.

the acceptance of these restrictions.

SHEET TITLE


BUILDING ROOF
PLAN
(BUILDING 1, TYP.)

SCALE: 1/8" = 1'=0"

SHEET#

A3.01

addillia IND Apts 1207 (Drawings) O - Drawing Ollects (A.C.) - Dailding (NOT Francismy), 10/3/2012 10:39:42 F M

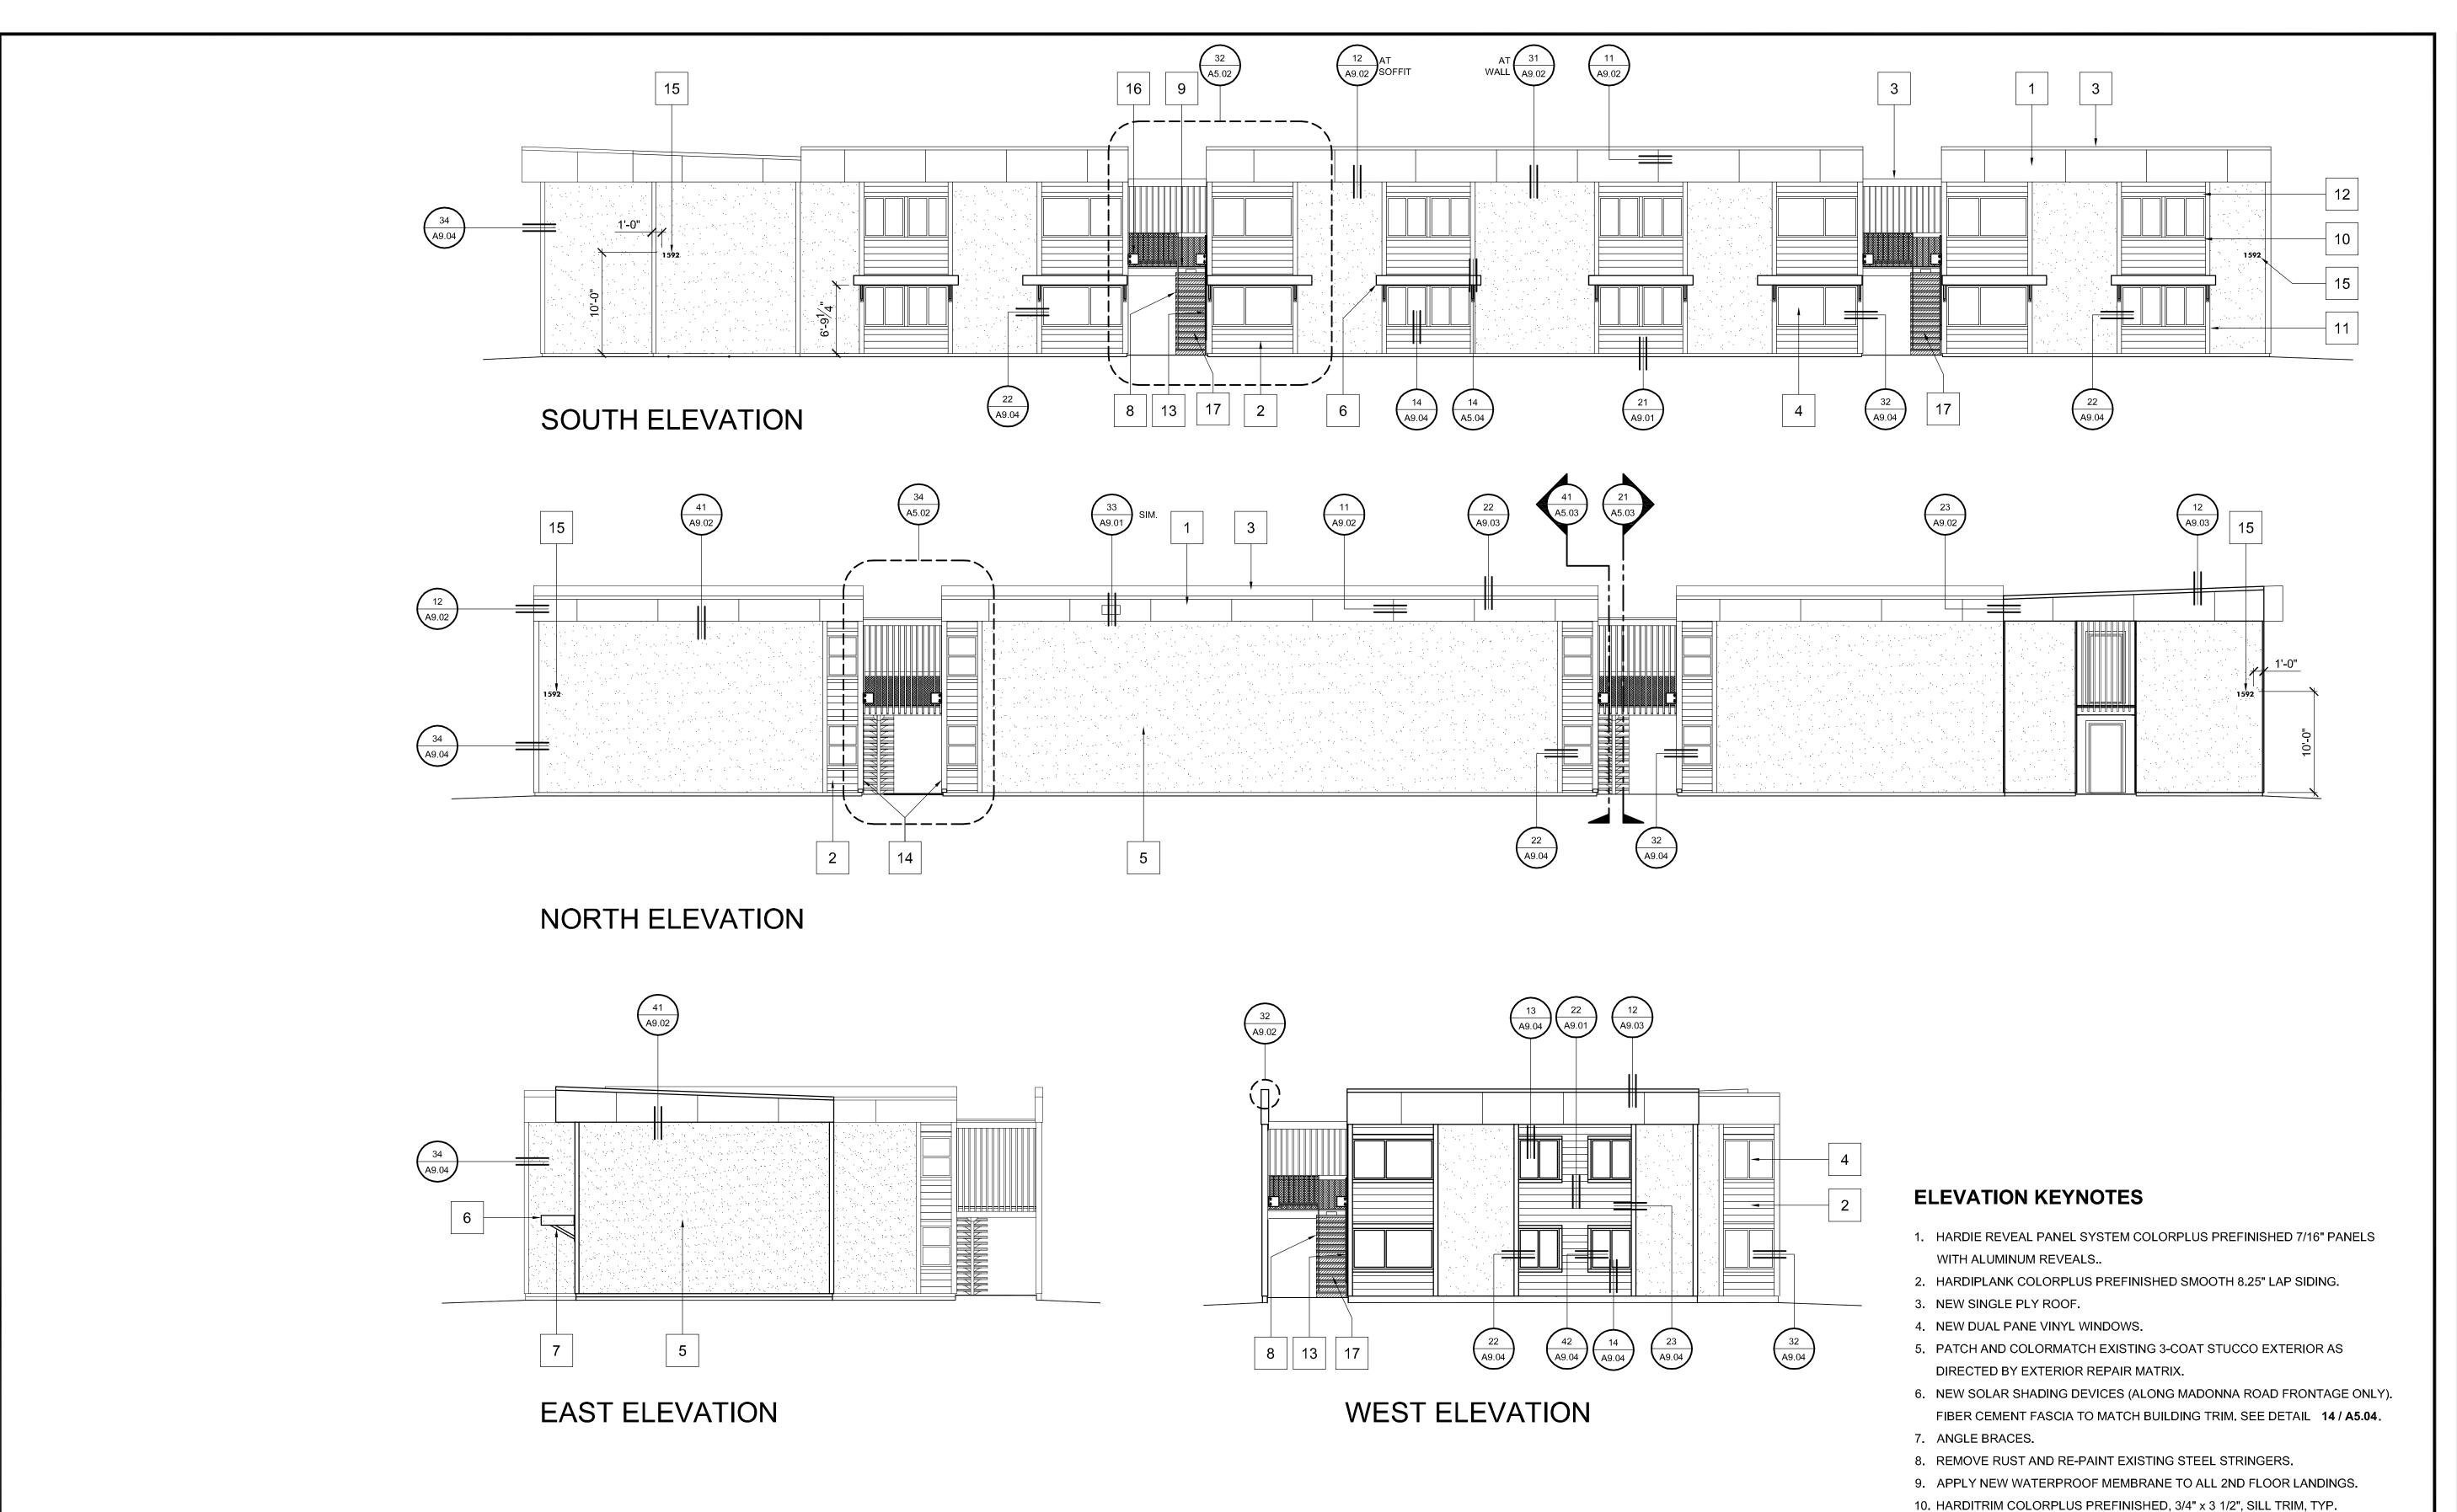

MADONNA ROAD APARTMENTS

A RENOVATION AND UPGRADE PROJECT

1550 MADONNA ROAD SAN LUIS OBISPO, CA

CLIENT JOB#

3# ARCHITECT JOB# **1207**



971 OSOS STREET SAN LUIS OBISPO CALIFORNIA 93401

805-544-6161

www.fraserseiplearchitects.com

PROJECT MANAGER BDF

DRAWN BY DDL

08-08-2012 1st SUBMITTAL
09-19-2012 1st RE-SUBMITTAL

09-19-2012 1st RE-SUBMITTAL

10-05-2012 FOR CONSTRUCTION

SIGNED

SIGNED

SIGNED

ARCHIVE

OUGLAS

PROFIT

SIGNED

ARCHIVE

OUGLAS

The use of these plans and specifications shall be restricted to the original site for which they were prepared and publication thereof is expressly limited to such use. Reproduction or publication by any method, in whole or in part, is prohibited. Title to these plans and specifications remain with the architect without prejudice. Visual contact with these plans and specifications shall constitute prima facie evidence of the acceptance of these restrictions.

Written dimensions on these drawings shall have precedence over scaled dimensions. Contractors shall verify and be responsible for all dimensions and existing conditions on the job and shall report any discrepancies to the architect for resolution prior to commencing work.

SHEET TITLE

11. HARDITRIM COLORPLUS PREFINISHED, 3/4" x 7 1/4", VERT. TRIM, TYP.12. HARDITRIM COLORPLUS PREFINISHED, 3/4" x 5 1/4", HEAD TRIM, TYP.

14. REPLACE ALL EXISTING DOWNSPOUTS AND GUTTERS.

BREEZEWAY, TYP.

13. NEW WALL MOUNTED HANDRAIL AT ALL STAIRWAYS. SEE DETAIL 41 / A5.03.

FUTURA MEDIUM, MOUNT AT BUILDING CORNERS TO BE CLEARLY VISIBLE

PLAQUE, FLAG MOUNTED TO WALL OR CORNER TRIM, BOTH ENDS OF EACH

15. NEW BUILDING ADDRESS SIGNAGE: 6" DIMENSIONAL PLASTIC NUMBERS,

16. NEW UNIT ADDRESS SIGNAGE: 3" NUMBERS, FUTURA MEDIUM, ON 12"x12"

17. PROVIDE PERMANENT NOSING MARKINGS OF STAIRS AND STEPS FOR THE

18. PROVIDE 2 LAYERS OF GRADE D BUILDING PAPER, OR EQUAL, BEHIND

VISUALLY IMPAIRED - 2" MINIMUM WIDE FOR FULL WIDTH OF TREAD WITH

CONTRASTING COLOR AT EACH TREAD OF EXTERIOR STAIRWAY OR STEPS.

EXTERIOR PLASTER WHERE INSTALLED OVER WOOD-BASED SHEATHING.

FROM ALL DRIVEWAYS. SEE NOTE 19 / A1.2 FOR LOCATIONS.


BUILDING

ELEVATIONS (BUILDING 1, TYP.)

SCALE: 1/8" = 1'=0"

SHEET#

A5.01

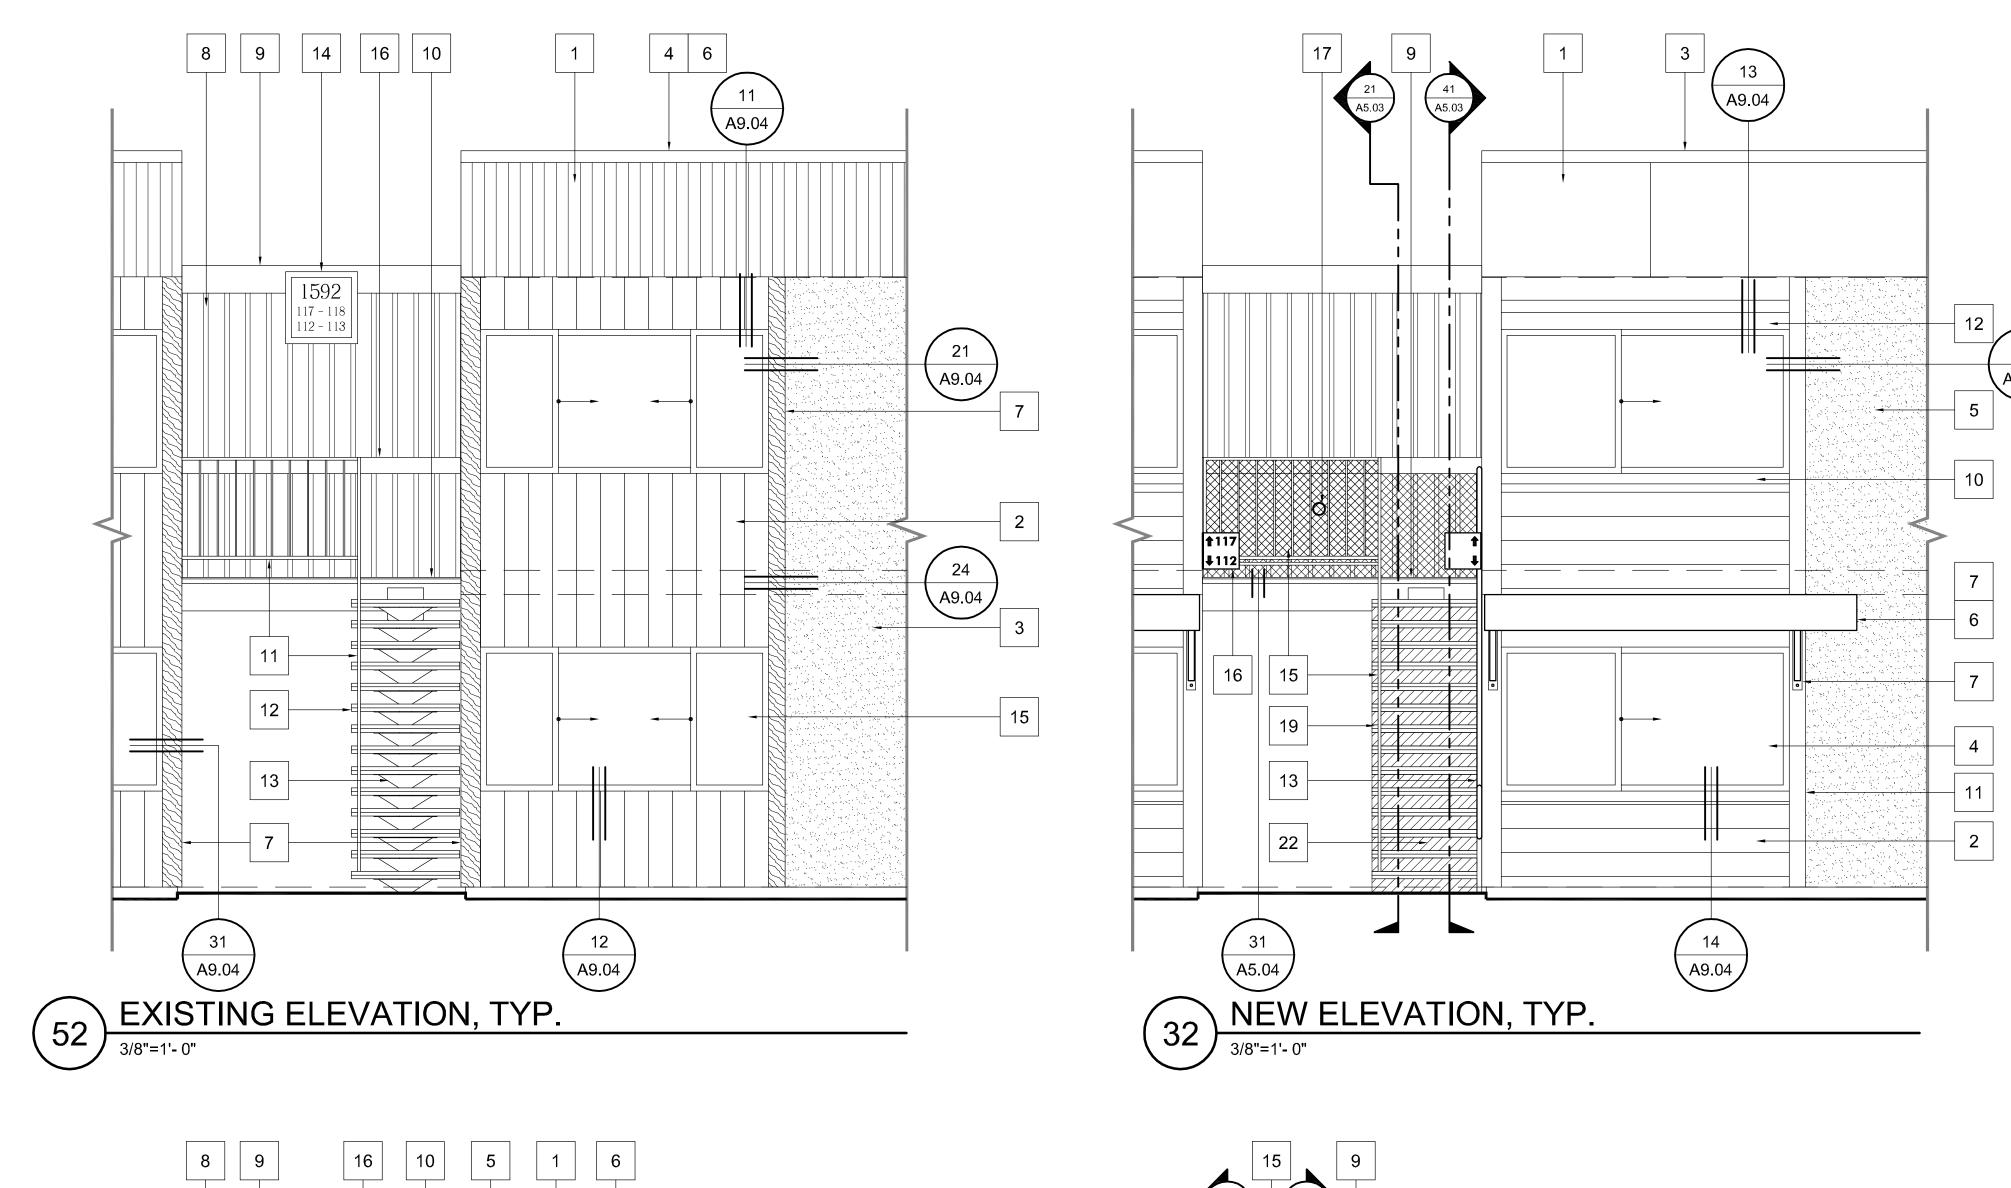



(52) 54) EXISTING ELEVATION KEYNOTES

- 1. FASCIA & SOFFIT: ROUGH SAWN CEDAR PLYWOOD SIDING W/ VERTICAL REVEALS @ 4" O.C.
- 2. SIDING: ROUGH SAWN CEDAR PLYWOOD SIDING W/ VERTICAL REVEALS @ 8" O.C.
- CEMENT PLASTER.
- 4. 26 GA. GRAVEL STOP.
- 5. 26 GA. GUTTER @ DOWNSPOUT.
- 6. ROOF: 4 PLY BUILT-UP CAP SHEET.
- 7. REMOVE ALL (E) 2x PAINTED TRIM. 8. 2x2 PAINTED SLATS @ 6" O.C..
- 9. BREEZWAY ROOF: 2x6 T&G OVER 3x LEDGERS W/ CAP SHEET ROOF.
- 10. TOP LANDING: 1/2" EXTERIOR GRADE PLYWOOD OVER 2x6 T&G DECKING WITH WATERPROOF DECK TOPPING.
- 11. GUARDRAILS: 1" SQ. METAL TUBE TOP AND BOTTOM RAILS; 1/2" SQ. STEEL BARS @ 6" O.C.
- 12. TREADS: PRECAST CONCRETE.
- 13. STRINGER: 4"x7"x1/4" TUBE STEEL, PAINTED.
- 14. ADDRESS SIGNAGE ON PAINTED PLYWOOD BACKING.
- 15. ALUMINUM FRAMED SINGLE PANE WINDOW.
- 16. 4x6 PAINTED HANDRAIL.

PROJECT

MADONNA ROAD APARTMENTS

A RENOVATION AND **UPGRADE PROJECT**

1550 MADONNA ROAD SAN LUIS OBISPO, CA

CLIENT JOB#

ARCHITECT JOB# 1207



971 OSOS STREET SAN LUIS OBISPO CALIFORNIA 93401

805-544-6161

www.fraserseiplearchitects.com


PROJECT MANAGER BDF

DRAWN BY DDL

08-08-2012 1st SUBMITTAL 09-19-2012 1st RE-SUBMITTAL

10-05-2012 FOR CONSTRUCTION

SIGNED

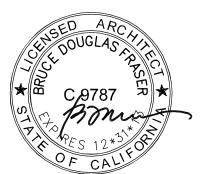

The use of these plans and specifications shall be restricted the original site for which they were prepared and publication thereof is expressly limited to such use. Reproduction or publication by any method, in whole or in part, is prohibited. Title to these plans and specifications remain with the architect without prejudice. Visual contact with these plans and specifications shall constitute prima facie evidence of the acceptance of these restrictions.

Written dimensions on these drawings shall have precedence over scaled dimensions. Contractors shall verify and be responsible for all dimensions and existing conditions on the job and shall report any discrepancies to the architect for resolution prior to commencing work.


SHEET TITLE

ENLARGED ELEVATIONS

(BUILDING 1, TYP.)


SCALE: 3/8"=1'-0"

A5.02

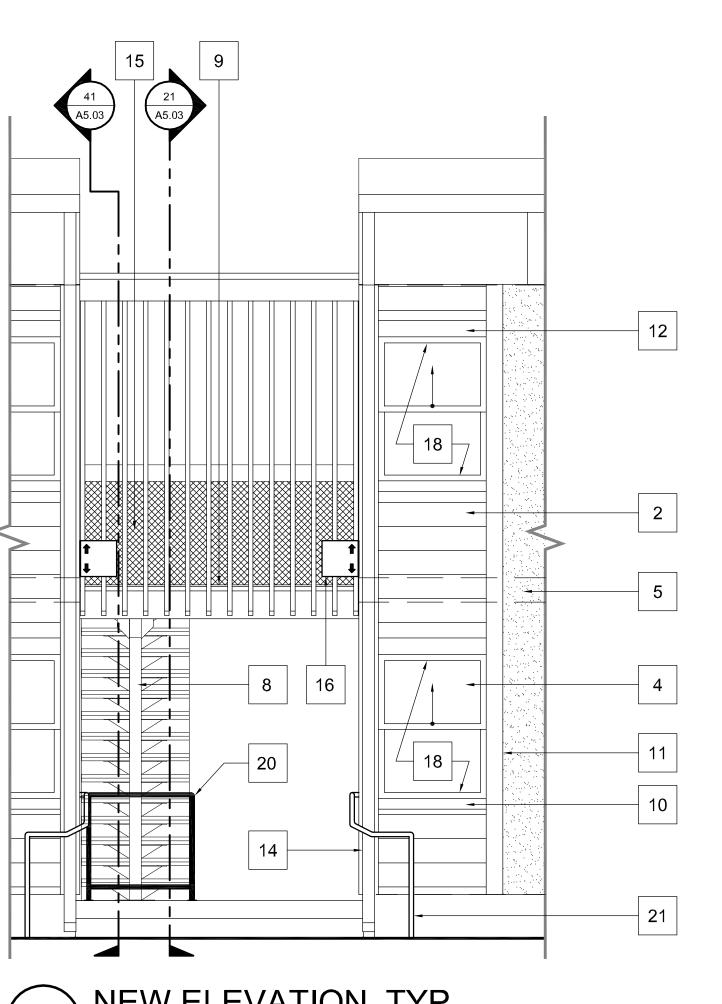





- 1. FASCIA & SOFFIT: HARDIE REVEAL PANEL SYSTEM COLORPLUS PREFINISHED 7/16" PANELS WITH ALUMINUM REVEALS. SEE SHEET A9.02.
- 2. SIDING: HARDIPLANK COLORPLUS PREFINISHED SMOOTH 8.25" LAP SIDING. SEE SHEET A9.01.
- 3. NEW SINGLE PLY ROOF. SEE SHEET A9.03.
- 4. NEW DUAL PANE VINYL WINDOWS.
- 5. PATCH AND COLORMATCH EXISTING 3-COAT STUCCO EXTERIOR AS DIRECTED BY EXTERIOR REPAIR MATRIX.
- 6. NEW SOLAR SHADING DEVICE. FIBER CEMENT FASCIA TO MATCH BUILDING TRIM. SEE DETAIL 14 / A5.04.
- 7. HARDITRIM COLORPLUS PREFINISHED, 3/4" x 11 1/4", SOLAR SHADING DEVICE FASCIA, TYP.
- 8. REMOVE RUST AND RE-PAINT EXISTING STEEL STRINGERS.
- 9. APPLY NEW WATERPROOF MEMBRANE TO ALL 2ND FLOOR LANDINGS. SEE DETAILS 21, 31 & 41 / A5.04.
- 10. HARDITRIM COLORPLUS PREFINISHED, 3/4" x 3 1/2", SILL TRIM, TYP.
- 11. HARDITRIM COLORPLUS PREFINISHED, 3/4" x 7 1/4", VERT. TRIM, TYP. 12. HARDITRIM COLORPLUS PREFINISHED, 3/4" x 5 1/4", HEAD TRIM, TYP.
- 13. NEW WALL MOUNTED HANDRAIL AT ALL STAIRWAYS. SEE DETAIL 24 / A5.04.
- 14. REPLACE ALL EXISTING DOWNSPOUTS AND GUTTERS.
- 15. 1 1/4" SQUARE BLACK VINYL COATED EXPANDED METAL MESH INFILL PANEL WITH 'U' EDGE TRIM ALL AROUND, MECHANICALLY ATTACHED TO (E)
- 16. ADDRESS SIGNAGE: 3" NUMBERS, FUTURA MEDIUM, ON 12"x12" PLAQUE, FLAG MOUNTED TO WALL OR CORNER TRIM. SEE SPECS.
- 17. GUARDRAILS SHALL NOT HAVE OPENINGS WHICH ALLOW PASSAGE OF A SPHERE 4" IN DIAMETER.
- 18. FILL FRAME ABOVE AND BELOW TO SET NEW WINDOW AT +6'-8" A.F.F.
- 19. PROVIDE PERMANENT NOSING MARKINGS OF STAIRS AND STEPS FOR THE VISUALLY IMPAIRED - 2" MINIMUM WIDE FOR FULL WIDTH OF TREAD WITH CONTRASTING COLOR AT EACH TREAD OF EXTERIOR STAIRWAY OR STEPS.
- 20. NEW 36" WIDE SURFACE MOUNT GUARDRAIL AT UNDERSIDE OF STAIRS, TYP. SEE DETAIL 34 / A5.04.
- 21. NEW HANDRAILS PROVIDED WHEN TWO OR MORE EXISTING RISERS ARE PRESENT. SEE DETAIL 44 / A5.03.
- 22. NEW CLOSED RISERS PER DETAIL 23 / A5.04.

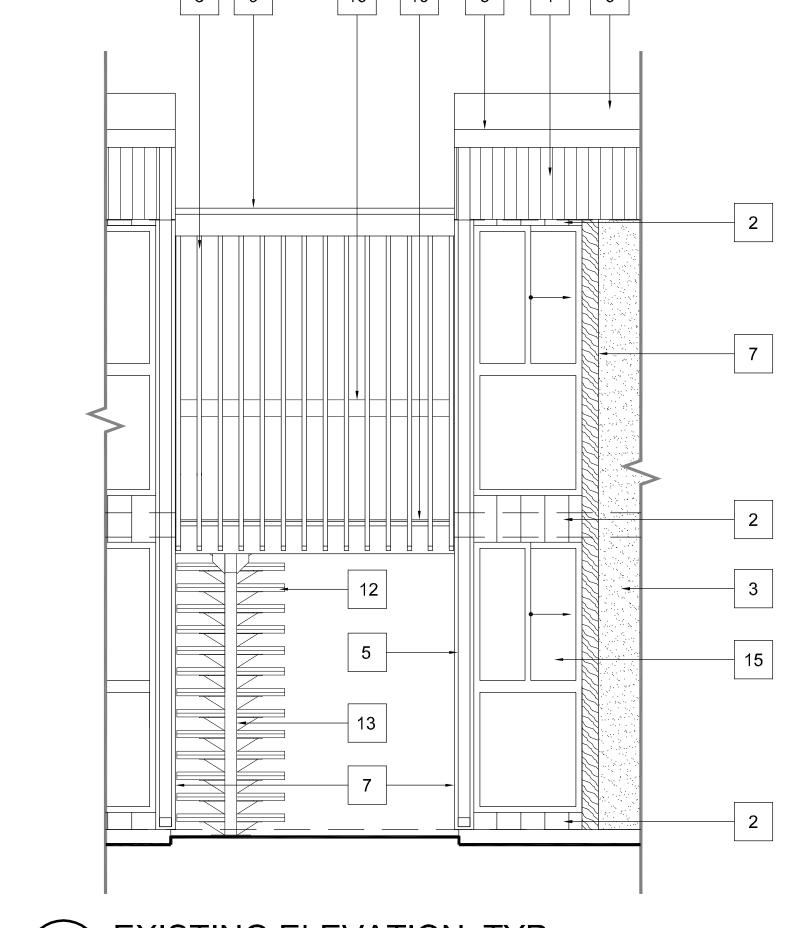


NEW ELEVATION, TYP.

EXISTING ELEVATION, TYP.

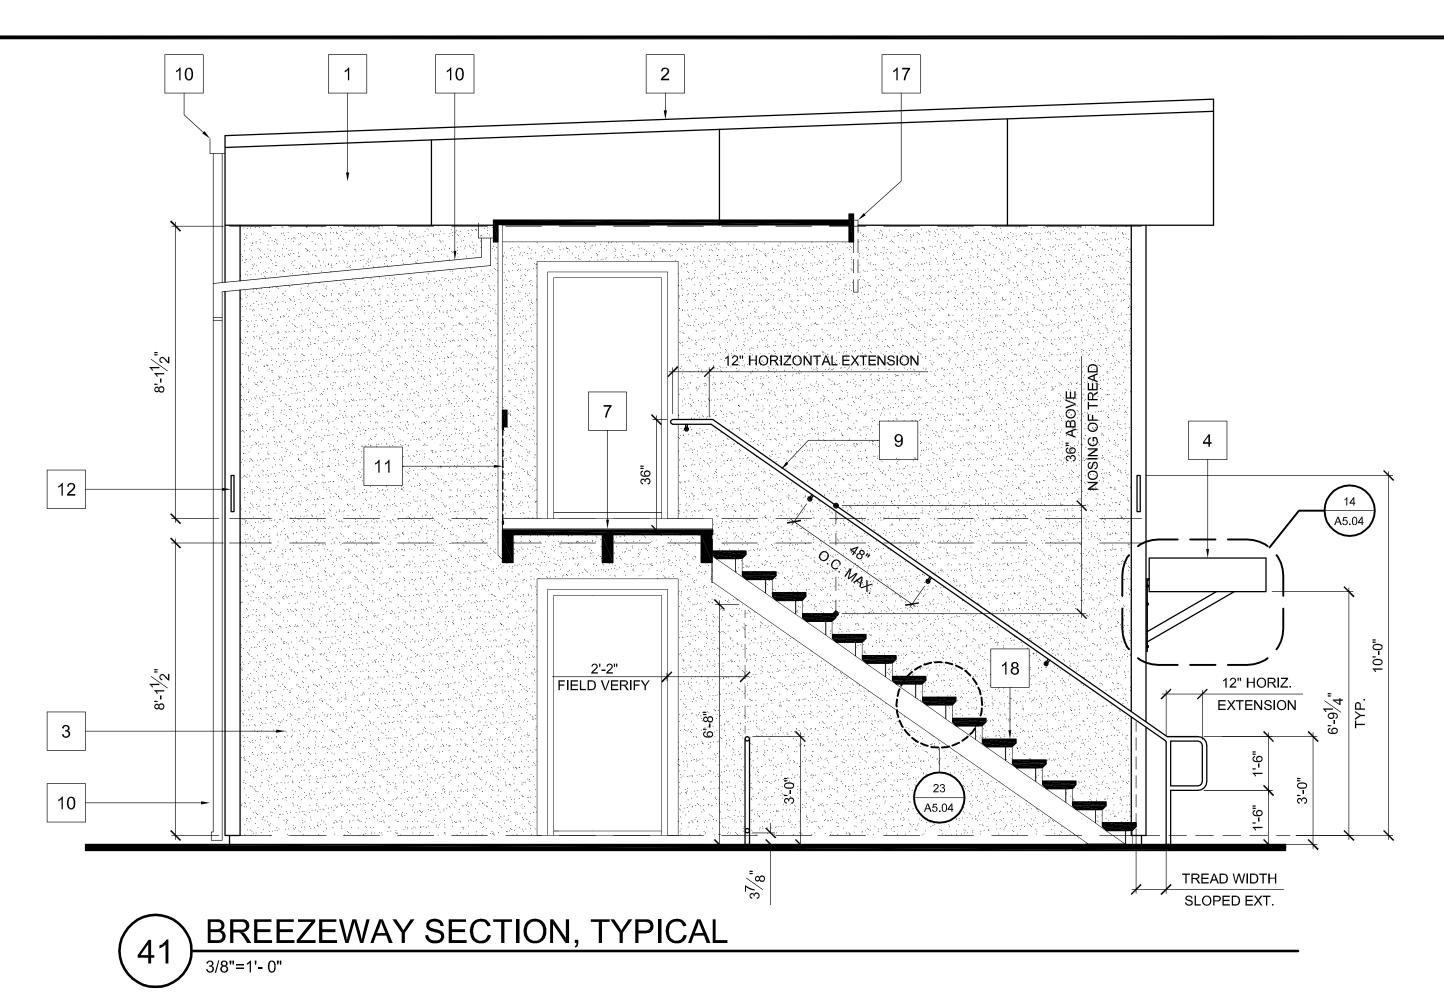

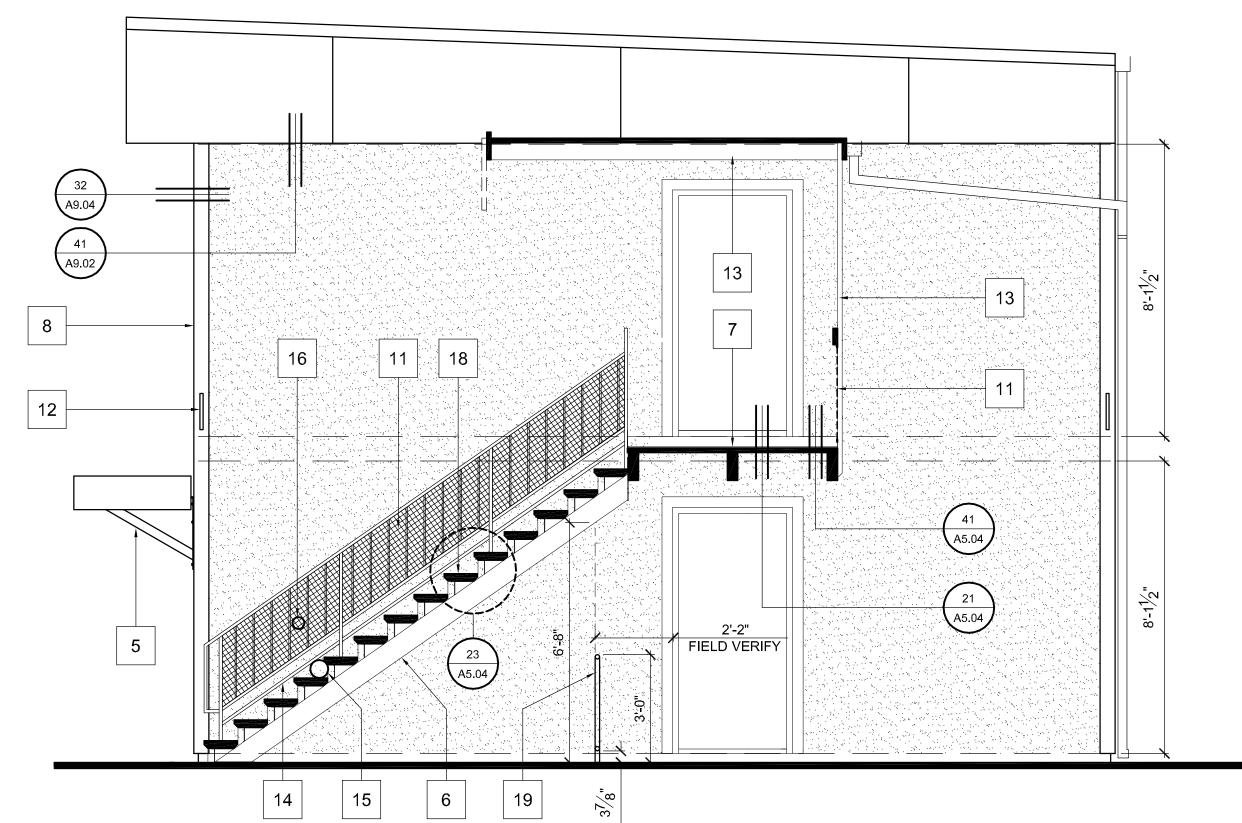


BREEZEWAY SECTION, TYPICAL

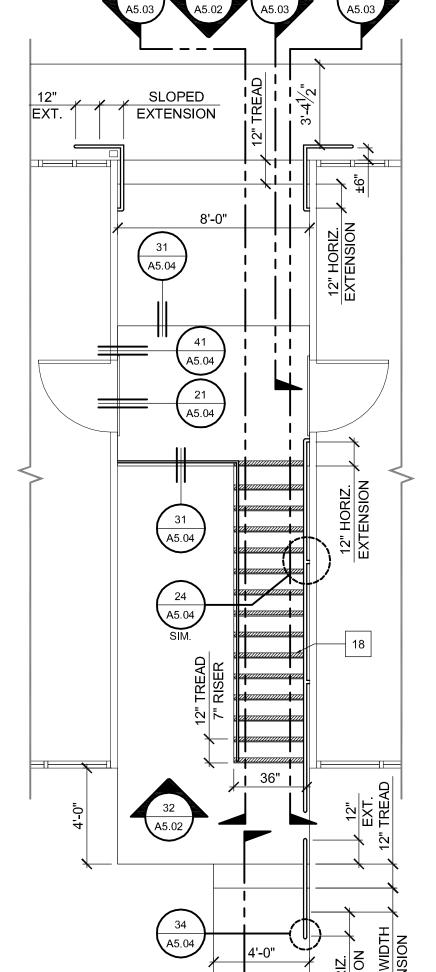

NEW ELEVATION KEYNOTES


- 1. FASCIA & SOFFIT: HARDIE REVEAL PANEL SYSTEM COLORPLUS PREFINISHED 7/16" PANELS WITH ALUMINUM REVEALS. SEE SHEET A9.02 FOR DETAILS.
- 2. NEW SINGLE PLY ROOF, ALL ROOFS, SEE SHEET A9.03 FOR DETAILS.
- 3. PATCH AND COLORMATCH EXISTING 3-COAT STUCCO EXTERIOR AS DIRECTED BY EXTERIOR REPAIR MATRIX.
- 4. NEW SOLAR SHADING DEVICE. FIBER CEMENT FASCIA TO MATCH BUILDING TRIM. SEE DETAIL 14 / A5.04.
- 5. ANGLE BRACE.
- 6. REMOVE RUST AND RE-PAINT EXISTING STEEL STRINGERS.
- 7. APPLY NEW WATERPROOF MEMBRANE TO ALL 2ND FLOOR LANDINGS.
- 8. HARDITRIM COLORPLUS PREFINISHED, 3/4" x 3 1/2"
- 9. NEW WALL MOUNTED HANDRAIL AT ALL STAIRWAYS. SEE DETAIL 24/ **A5.04.** HANDRAIL ONLY PROVIDED ON ONE SIDE OF STAIRWAYS PER 2010 CBC SECTION 1009.12 EXCEPTION 2.
- 10. REPLACE ALL EXISTING DOWNSPOUTS AND GUTTERS.
- 11. 1 1/4" SQUARE BLACK VINYL COATED EXPANDED METAL MESH INFILL PANEL WITH 'U' EDGE TRIM ALL AROUND.
- 12. ADDRESS SIGNAGE: 3" NUMBERS, FUTURA MEDIUM, ON 12"x12" PLAQUE, FLAG MOUNTED TO WALL OR CORNER TRIM.
- 13. PAINT EXISTING 2x2 VERTICAL SLATS AND BREEZWAY FRAMING WHITE TO MATCH TRIM.
- GUARDRAIL.
- FORMED BY AT THE RISER, TREAD AND BOTTOM RAIL SHALL NOT
- 16. GUARDRAILS SHALL NOT HAVE OPENINGS WHICH ALLOW PASSAGE OF A SPHERE 4" IN DIAMETER.
- 17. EXISTING ADDRESS SIGNAGE TO BE REMOVED.
- TREAD WITH CONTRASTING COLOR AT EACH TREAD OF EXTERIOR
- 19. NEW 36" WIDE SURFACE MOUNT GUARDRAIL FOR UNDERSIDE OF
- PAINT. HANDRAIL PROVIDED ON ONE SIDE OF SITE STEPS WITH SECTION 1003.5 EXCEPTION 2.

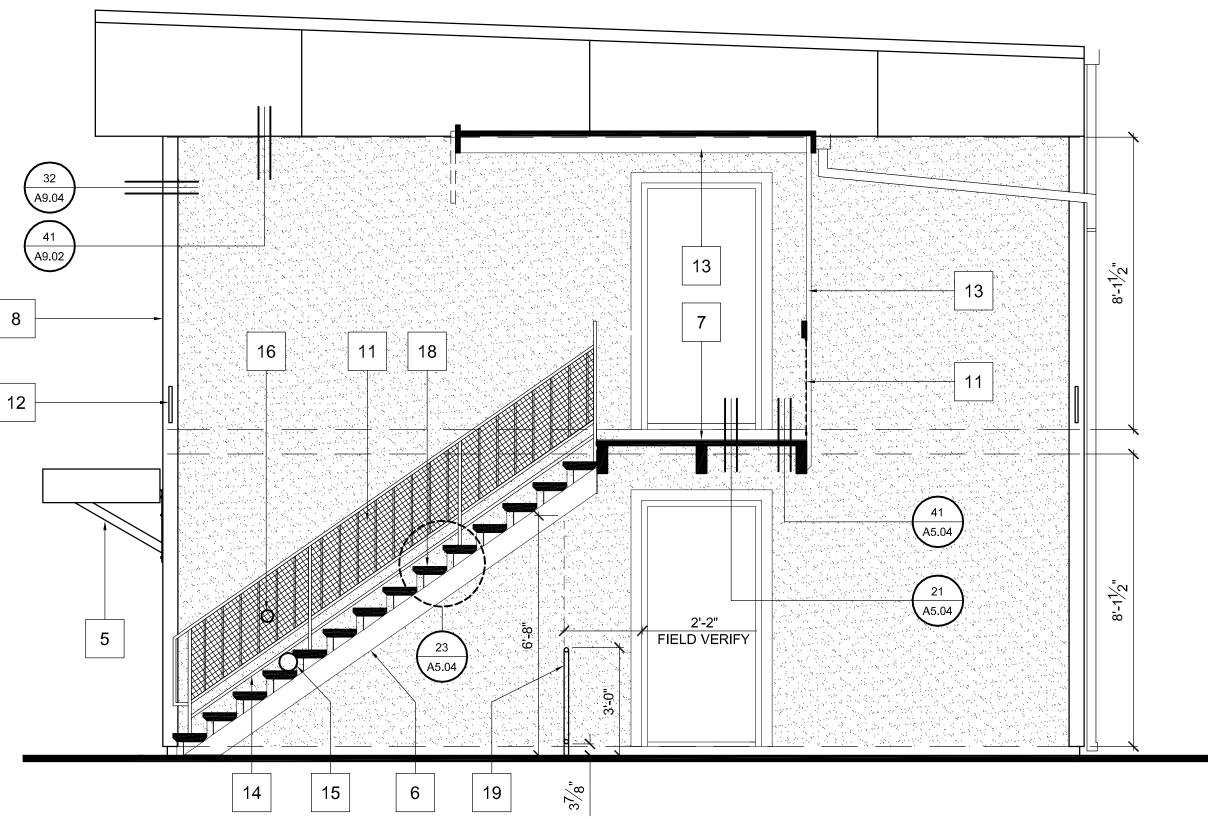


14. NEW 1" SQUARE HORIZONTAL RAIL., MATCH AND WELD TO EXISTING 15. THE TRIANGULAR OPENINGS AT THE OPEN SIDES OF A STAIR,


ALLOW PASSAGE OF A SHERE 6" IN DIAMETER.

- 18. PROVIDE PERMANENT NOSING MARKINGS OF STAIRS AND STEPS FOR THE VISUALLY IMPAIRED - 2" MINIMUM WIDE FOR THE FULL WIDTH OF STAIRWAY OR STEPS.
- STAIRS, TYP.
- 20. NEW 1 1/2" DIA. STEEL HANDRAIL WITH BLACK EXTERIOR ENAMEL MORE THAN 1 RISER AND LESS THAN 5' WIDE BASED ON 2010 CBC

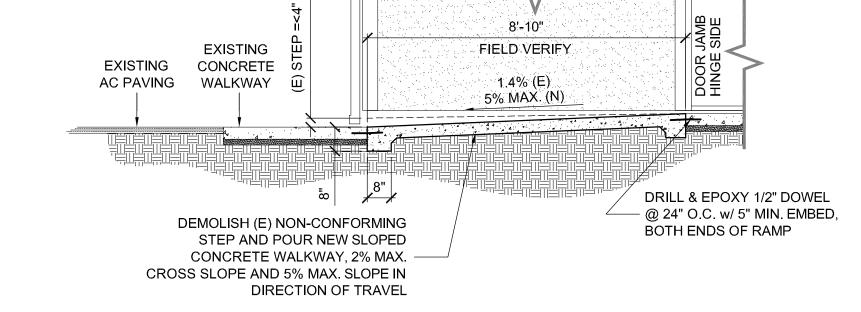

NEW SLOPED WALKWAY WHEN STEP < 4"

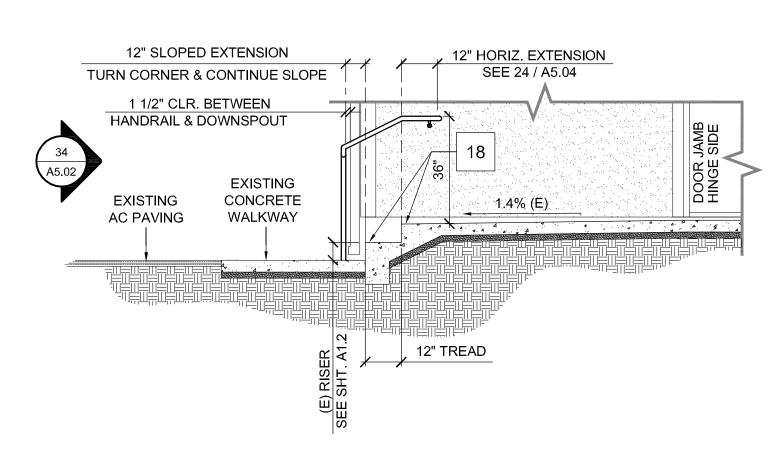

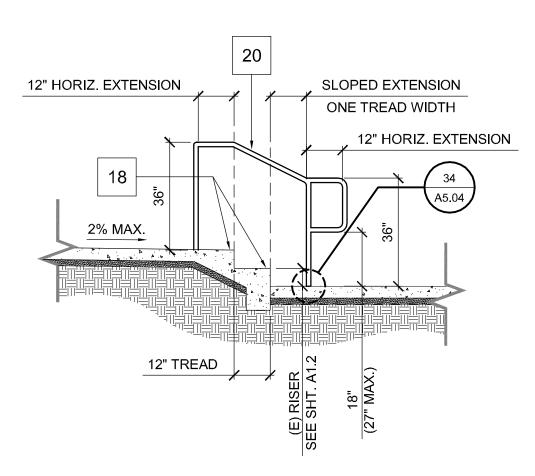

HANDRAILS AT REAR OF BREEZEWAY

STRAIGHT HANDRAIL

BREEZEWAY PLAN, TYP.

24

PROJECT

MADONNA ROAD APARTMENTS

A RENOVATION AND **UPGRADE PROJECT**

1550 MADONNA ROAD SAN LUIS OBISPO, CA

CLIENT JOB#



971 OSOS STREET SAN LUIS OBISPO CALIFORNIA 93401

ARCHITECT JOB#

1207

805-544-6161


www.fraserseiplearchitects.com

PROJECT MANAGER BDF

DRAWN BY DDL

08-08-2012 1st SUBMITTAL 09-19-2012 1st RE-SUBMITTAL

10-05-2012 FOR CONSTRUCTION

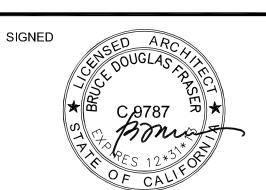

The use of these plans and specifications shall be restricted the original site for which they were prepared and publication thereof is expressly limited to such use. Reproduction or publication by any method, in whole or in part, is prohibited. Title to these plans and specifications remain with the architect without prejudice. Visual contact with these plans and specifications shall constitute prima facie evidence of e acceptance of these restrictions.

Written dimensions on these drawings shall have precedence over scaled dimensions. Contractors shall verify and be responsible for all dimensions and existing conditions on the job and shall report any discrepancies to the architect for resolution prior to commencing work.


SHEET TITLE

ELEVATION **DETAILS**

(BREEZEWAYS)

SCALE: AS NOTED

A5.03

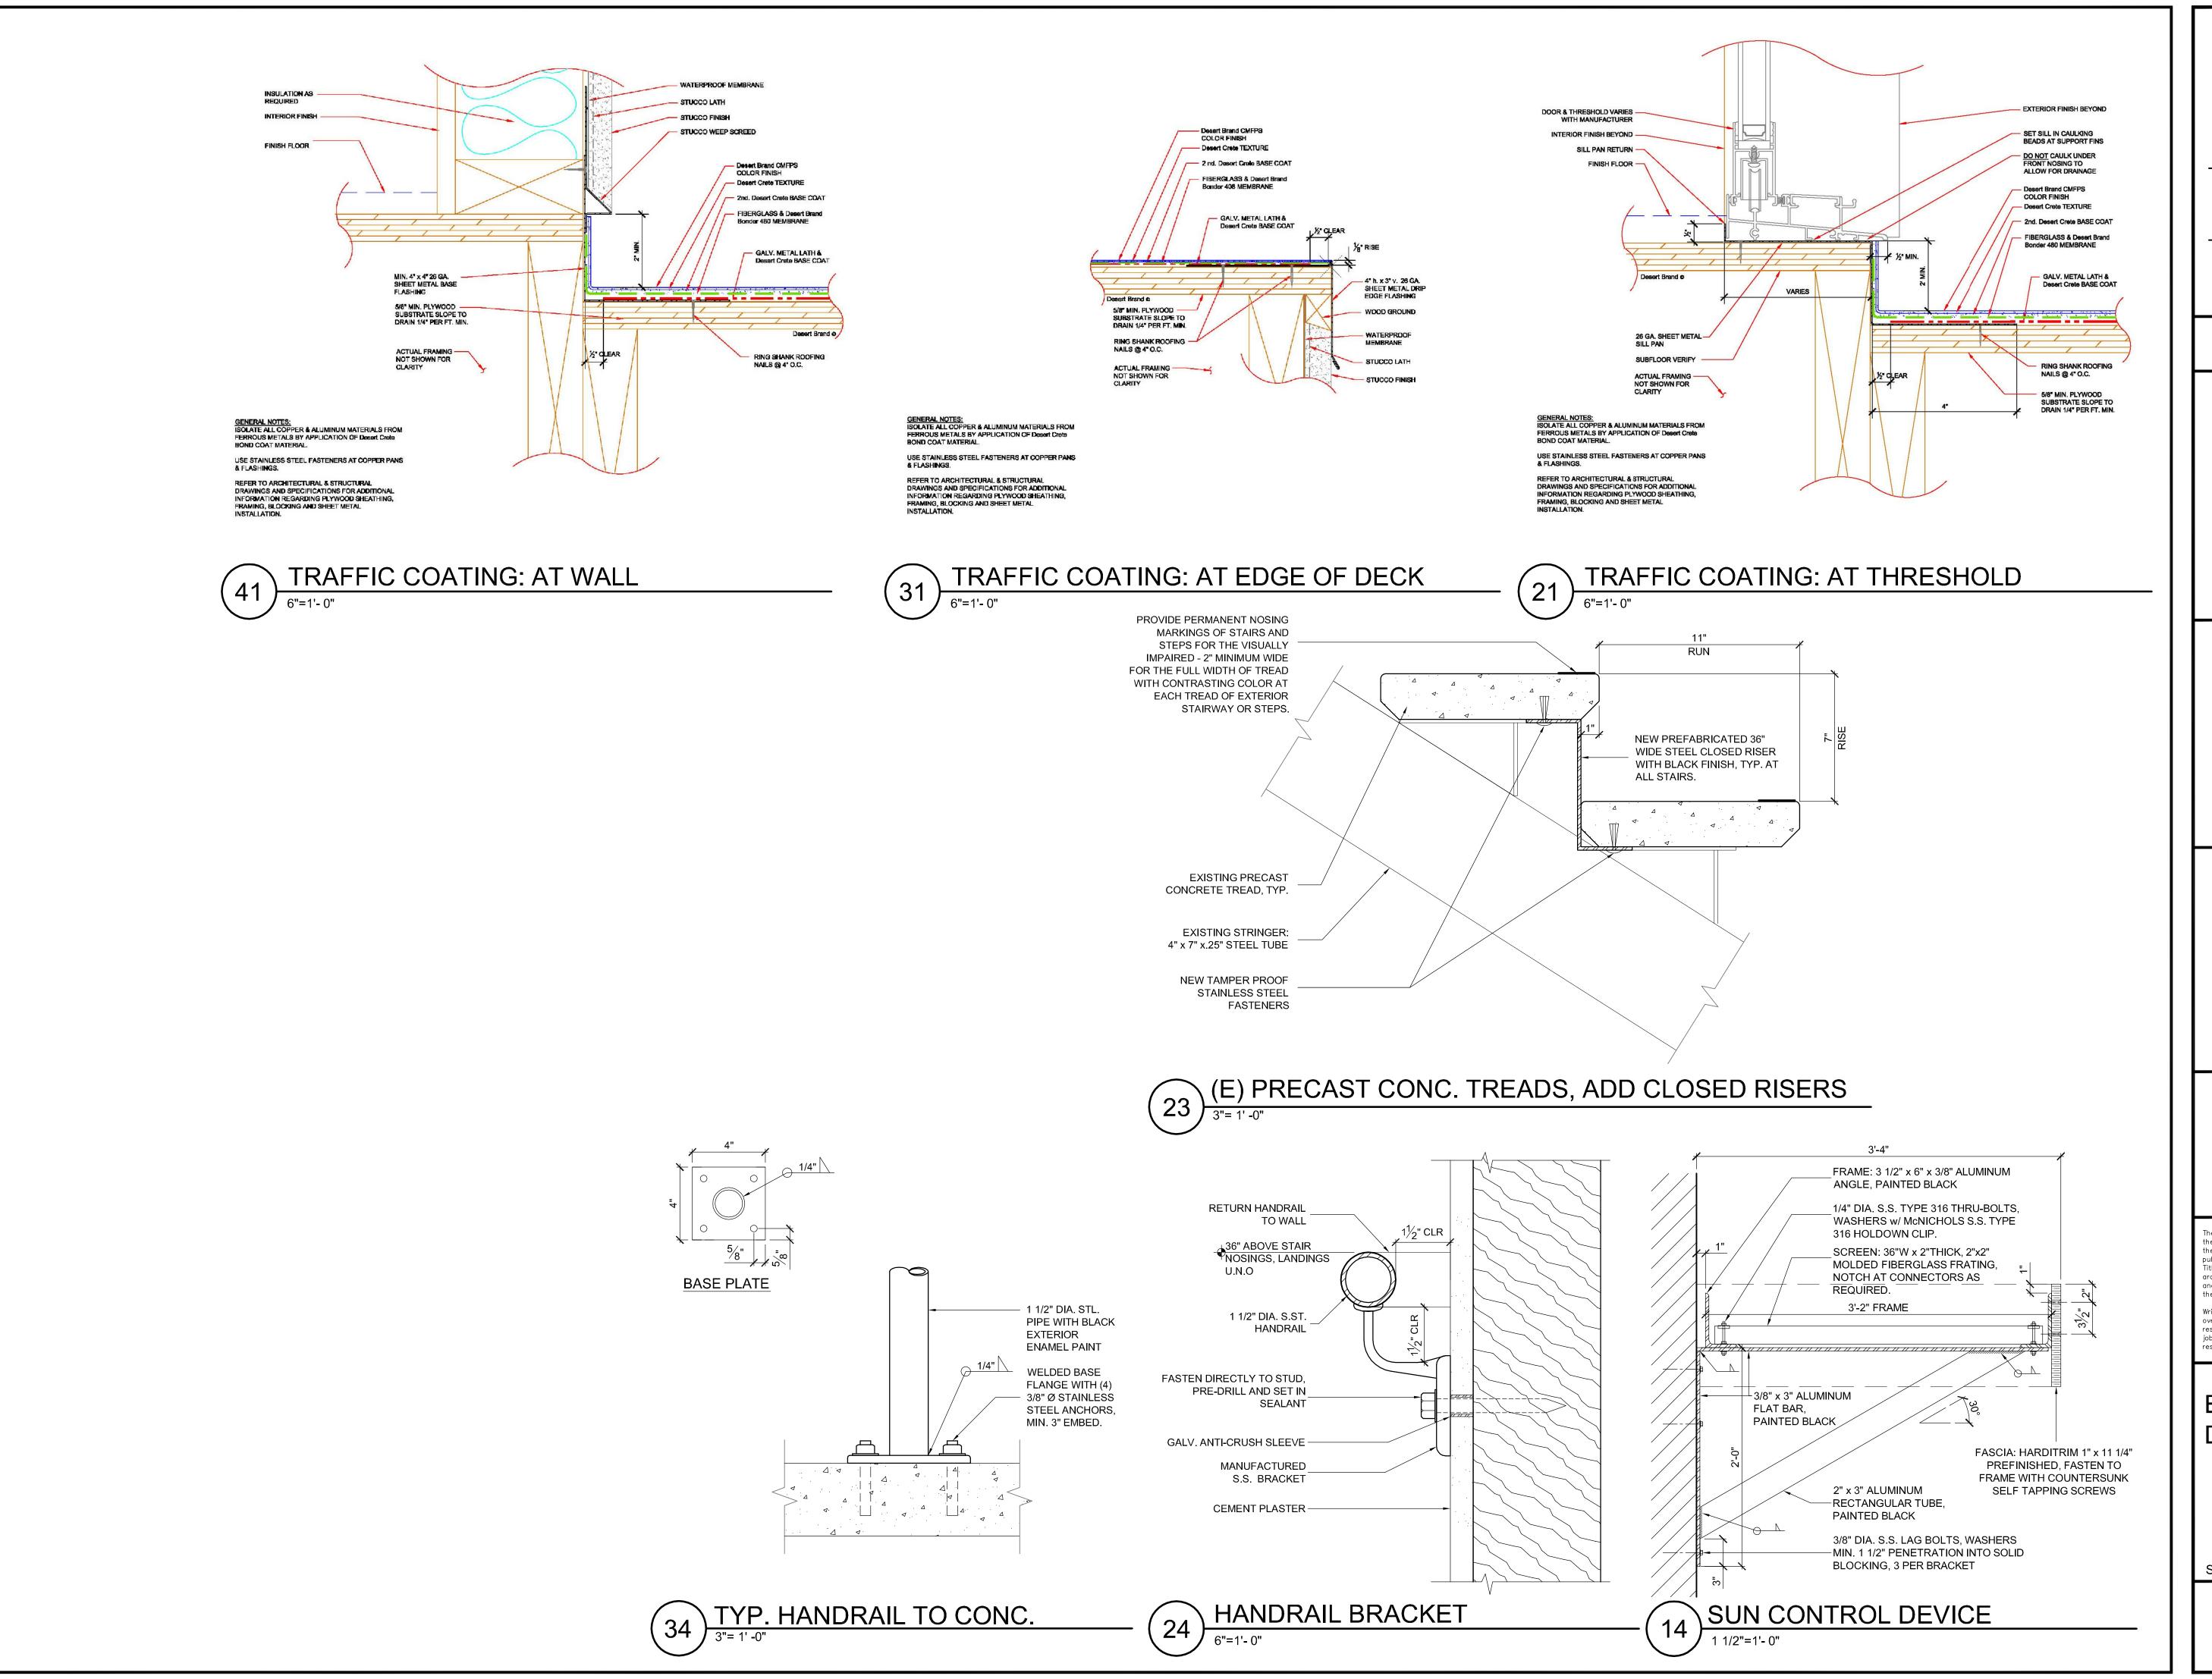

PROJE

MADONNA ROAD APARTMENTS

A RENOVATION AND UPGRADE PROJECT

1550 MADONNA ROAD SAN LUIS OBISPO, CA

CLIENT JOB#

1207

ARCHITECT JOB#



971 OSOS STREET SAN LUIS OBISPO CALIFORNIA 93401

805-544-6161

www.fraserseiplearchitects.com

PROJECT MANAGER BDF

DRAWN BY DDL

08-08-2012 1st SUBMITTAL
09-19-2012 1st RE-SUBMITTAL
10-05-2012 FOR CONSTRUCTION

SIGNED SED A

The use of these plans and specifications shall be restricted the original site for which they were prepared and publication thereof is expressly limited to such use. Reproduction or publication by any method, in whole or in part, is prohibited. Title to these plans and specifications remain with the architect without prejudice. Visual contact with these plans and specifications shall constitute prima facie evidence of the acceptance of these restrictions.

Written dimensions on these drawings shall have precedence over scaled dimensions. Contractors shall verify and be responsible for all dimensions and existing conditions on the job and shall report any discrepancies to the architect for resolution prior to commencing work.

SHEET TITLE

ELEVATION DETAILS

SCALE: AS NOTED

SHEET#

A5.04

										Uı	nit			 					k	itche	n							E	Bathro	om					
	Unit #	ω Bed Rooms	1.5 Bath Rooms	Exterior Door	Door Hardware	Carpet	Light Fixtures	1 Blinds	т Smoke Detectors	Paint	Drywall Repairs	Interior Door	Closet Doors	1 Wall Heaters	Hot Water Heater Misc.	1 Kitchen Cabinets	Zitcho	Niccient right Tatale	eru s		Stove		Vinyl Plank Flooring					2 GFCl's	1 Paint	Grab Bars	N Toilet Paper Dispenser	⊳ Towel Bar	□ Vinyl Plank Flooring	Bathroom Base/Drywall Patch Bath / Kitchen Base	
Building 1	112 B 113 B 114 B 115 B	2 2 2	1.3 1 1 1		1			1 1 1	1 1 1					1	1	1 1 1			2 :	L L		1 1 Paint Hall Cabinets Water Heater Door / Door Stops Leaking Tub above / Bedroom Closet Doors	Buildi
	116 C 117 B 118 B 119 B	2	1.5 1 1		1			1 1 1	1					1 1 1		1 1 1			2 :	L L	1	1	1 1 1		1 1 1	2 1 1	1	2 1 1	1 1 1		2 1 1	2 1 1	1 1 1	Paint Hall Cabinets Replace Smoke Alarm / Replace Attic Access / Missing Closet Doors Door Stops	Buildi
	120 B 105 C 106 C	2 3 3	1 1.5 1.5					1 1 1	1 1 1					1		1 1		:	2 :	L L	1	1 1 1	1 1 1		1 1 1	1 2 2	1 1 1	1 2 2	1 1 1		1 2 2	1 2 2	1 1 1	Paint Hall Cabinets / Replace Attic Access / Door Stops	Buildi
Building 2	107 C 108 C 109 C 110 C	3 3 3	1.5 1.5 1.5 1.5					1 1 1	1 1 1					1 1 1	1	1 1 1		:	2 :	L L		1 1 1	1 1 1		1 1 1	2 2 2	1 1 1	2 1 2	1 1 1			2 2 1 2		Water Damage in Bedroom Ceiling / Door Stops Missing one wall heater completely. (It has been removed & drywalled over.) Replace Bathroom Door / Bathroom Base / Damaged Subfloor	Buildi
Building 3	97 B 98 B 99 B 100 B			1	1			1 1 1	1		1		1		1	1 1 1			2 :	L L	1	1	1	1	1	1	1	1	1 1 1		1	1 1 1	1 1 1	Leaking Tub Above Full Interior paint Door Stops	
	101 B 102 B 103 B 104 B	2	1 1 ,	:	2 :	L :	1	1	Replace bahtroom faucet Bathroom Base / Paint Hall Cabinets / Door Stops Replace Attic Access / Paint Hall Cabinets / Door Stops	
Building 4	93 A 94 A 95 A 96 A	1 1 1	1	1	1			1 1 1	1 1 1		1			1	1	1 1 1		:	2 :	L	1	1	1 1 1 1		1	1	1	1	1 1 1		1 1 1	1 1 1	1 1 1	Paint Hall Cabinets Paint Hall Cabinets Paint Hall Cabinets	Buildi
Building 5	89 B 90 B 91 B 92 B			1	1			1 1 1	1			1	1 1 1		1	1 1 1			2 :	L L		1	1 1 1		1	2	1	1	1 1 1		1 1 1	1 1 1	1 1 1	Paint Hall Cabinets / Patch Ceiling in Hallway / Door Stops Door Stops / Paint Hall Cabinets / Attic Access	
Building 6	81 C 82 C 83 D 84 D 85 C	3 4 4 3	1.5 1.5 1.5 1.5	1	1 1 1			1 1 1 1 1	1 1 1		1			2	1 1 1 1	1			2 : 2 : 2 : 2 :	L L :	1 1 1	1 1 1	1 1 1 1 1		1 1 1	2 2 2 2	1 1 1	2 2 2 2	1 1 1 1			2 2 2 2	1 1 1	Bathroom Base Replace exterior door frame Patch Ceiling in Hallway	Buildi
	86 C 87 D 88 D 73 B	4	1.5 1.5 1.5		1			1 1 1	1				1	1 1 1	1	1 1 1		:	2 1	L I	1	1	1 1 1		1	2	1	2	1 1 1		2 2 1	2 2 2	1 1 1	Replace attic access hatch Patch Ceiling in Closet	D. III
Building 7	74 B 75 B 76 B 77 B	2 2 2 2	1		1			1 1 1	1				1	1 1 1	1 1 1	1 1 1		:	2 :	L L		1 1 Paint Hall Cabinets Paint Hall Cabinets / Door Stops	Bu ildi Total
Building 8	78 B 79 B 80 B Maintenar		1 1	1	1			1 1 1	1				1	1 1	1	1 1		:	2 :	L		1	1 1 1		1	1	1	1 1	1 1 1		1 1 1	1 1	1 1 1	Paint Hall Cabinets Replace Attic Access	
Building 9	67 C 68 C 69 D 70 C 71 C	3 4 3 3	1.5 1.5 1.5 1.5		1			1 1 1 1	1 1 1				1	2	1	1 1 1 1 1			2 : 2 : 2 : 2 :	L L L		1 1 1	1 1 1 1 1		1 1 1	2 2 2 2	1 1 1	2 2 2 2	1 1 1 1		2 2 2 2 2 2	2 2 2 2 2 2	1 1 1 1 1	Add Seismic Strap to Water Heater Replace Water Heater Door	
Building 10a	72 D 58 D 59 C 60 C 64 D 65 C	4 3 3 4	1.5 1.5 1.5 1.5 1.5	1	1			1 1 1 1 1	1 1 1 1 1				1		1	1 1 1 1			2 : 2 : 2 : 2	L L	1	1 1 1	1 1 1 1 1		1 1 1	2 2 2 2	1 1 1	2	1 1 1 1 1		2 2 2 2 2 2	2 2 2 2 2 2	1 1 1 1 1	Paint Hall Cabinets / Door Stops Add Seismic Strap to Water Heater Add Seismic Strap to Water Heater Missing Hall Cabinet Door / Bathroom Base	
Building 10b	66 C 55 C 56 C 57 D 61 C	3 3 4 3	1.5 1.5 1.5 1.5					1 1 1 1 1	1 1 1 1 1			1	1 4		1	1 1 1 1			2 :	L L	1	1	1 1 1 1 1		1 1 1 1	2 2 2 2	1 1 1	2 2 2 2 2	1 1 1 1		2 2 2 2 2	2 2 2 2 2	1 1 1 1 1	Replace vent in hot water heater closet. Replace Water Heater Door	
Building 11	62 C 63 D 49 B 50 C 51 C	2 3	1.5 1.5 1 1.5 1.5		1			1 1 1 1	1 1 1				1 1 1	2 2 2		1 1 1 1			2 1	L L		1	1 1 1 1		1 1 1	2 1 2	1 1 1	1 2	1 1 1 1		2	2 2 1 2 2	1 1 1 1	Add Seismic Strap to Water Heater Door Stops Add Seismic Strap to Water Heater Add Seismic Strap to Water Heater Add Seismic Strap to Water Heater / Door Stops	
building 11	52 B 53 C 54 C 41 D	2 3 3	1 1.5 1.5	1	1			1 1 1	1 1 1				1 1 1	1 2 1	1	1 1 1		:	2 :	L L	1 1 1	1 1 1	1 1 1		1 1 1	2 2 2	1 1 1	1 2 2	1		1 2 2 2	1 2 2 2	1	Replace Hall Closet Door with Bi-Fold / Paint Hall Cabinets Paint Hall Cabinets / Door Stops Replace Exterior Door Frame	
Building 12	42 D 43 C 44 C 45 D 46 D	3 3 4	1.5 1.5 1.5 1.5	1				1 1 1 1 1	1		1		1	1 1 1	1	1 1 1 1			2 :	L L	1	1 1 1	1 1 1 1 1		1 1 1	2 2 2 2	1 1 1	2	1 1 1 1		2 2 2 2 2	2 2 2 2 2	1 1 1 1	Add Seismic Strap to Water Heater / Patch Drywall in Bedroom Add Seismic Strap to Water Heater / Door Stops / Paint Hall Cabinets Add Seismic Strap to Water Heater	
	47 C 48 C		1.5 1.5	1	1			1			1	1	1	2		1		2		L I		1	1			100		2	1		2	2	1	Door Stops / Paint Hallway / Replace Attic Access	

			L							Uni	t						Ц				Kitch	nen			Ц					Bathr	oom				
	Unit # Unit Type	Bed Rooms		Exterior Door	Door Hardware	Carpet	Light Fixtures	Blinds	Smoke Detectors	Paint	Drywall Repairs	Interior Door	Closet Doors	Switches Trim & Receptacles	Wall Heaters	Hot Water Heater	Misc.	Kitchen Cabinets	Kitchen Light Fixture	GFCI's	Paint	Stove	роон	Vinyl Plank Flooring	Refer	Tub / Surround	Toilet	Vanity	GFCI's	Paint	Grab Bars	Toilet Paper Dispenser	Towel Bar	Vinyl Plank Flooring	
	37 D	4 1						1	1		4		3		1	1	-	1		2	1	1	1	1			2	1	2	1		2	2	1	
Building 13	38 B 39 D	2 4 1	1		\dashv			1	1		\dashv				1		-	1	\dashv	2	1		1	1			2	1	2	1	-	2	2	1	Add Seismic Strap to Water Heater Replace Attic Access
	40 B	2	1		\exists			1	1		1				1	1	1	1		2	1		1	1			1		1	1		1	1	1	Replace Attic Access
	33 B	2	1					1	1						1			1		2	1	1	1	1	1	1	1	1	1	1		1	1	1	
Building 14	34 B	2	1					1	1		_							1		2	1		1	1		1	1	1	1	1		1	1	1	
	35 B	2	1					1	1		4	1	1		1			1	_	2	1		1	1		1	1	1	1	1		1	1	1	
	36 B	2	1		\dashv		H	1	1		_		_		1		\dashv	1	\dashv	2	1		1	1	1		1		1	1		1	1	1	Paint Hall Cabinets
	29 A 30 A	1 1	1		\dashv			1	1		1		1		1	1		1		2	1	1	1	1			1		1	1		1	1	1	Paint Hall Cabinets
Building 15	30 A 31 A	1	1					1	1		\exists		2		1			1	\exists	2	1	1	1	1			1		1	1		1	1	1	Ceiling Patch needed
	32 A	1	1					1	1				-		1			1		2	1		1	1			1		1	1		1	1	1	Paint Hall Cabinets
	21 B	2	1					1	1		1	1	1		1	1		1		2	1		1	1		1	1	1	1	1		1	1	1	
	22 B	2	1		\Box			1	1		4				1	1		1	_	2	1		1	1		1	1	1	1	1		1	1	1	Paint Hall Cabinets / Door Stops
	23 B	2	1		\dashv		-	1	1		-		1		\dashv		-	1	\perp	2	1		1	1			1	1	1	1		1	1	1	
Building 16	24 B	2	1		1			1	1		-	1			1		-	1	-	2	1	1	1				1		1	1		1	1	1	Paint Hall Cabinets / Door Stops
	25 B 26 B	2 2	1		1			1	1		-	1			1			1		2	1	1	1	1			1	1	1	1		1	1	1	Add Seismic Strap to Water Heater Paint Hall Cabinets
	27 B	2	1					1	1			1						1		2	1		1	1			1		1	1		1	1	1	Add Seismic Strap to Water Heater
	28 B	2	1 :	1	1			1	1									1		2	1	1	1	1		1	1	1	1	1		1	1	1	Replace Exterior Door Frame / Door
	7 A	1	1					1	1		4							1		2	1		1	1		1	1	1	1	1		1	1	1	
	8 A	1	1		\dashv		-	1	1		_				1			1	_	2	1		1	1			1	1	1	1		1	1	1	Paint Hall Cabinets
	9 A	1	1	1			-	1	1		\dashv						-	1	-	2	1		1	1			1		1	1		1	1	1	D
	10 A 11 A	1 1	1	1	1			1	1		-		1		1		\dashv	1	\dashv	2	1		1	1			1		1	1		1	1	1	Paint Hall Cabinets
	12 A	1	1		\exists			1	1		_					1		1			1	1	1				1		1	1		1	1	1	
Building 17	13 C	3 1	.5					1	1		╛				1			1		2	1		1	1			2		2	1		2	2	1	Add Seismic Strap to Water Heater
bulluing 17	14 A	1	1					1	1						1	1		1		2	1	1	1	1		1	1	1	1	1		1	1	1	Paint Hall Cabinets
	15 A	1	1					1	1		4		1		1	1	_	1	_	2	1	1	1	1	1	1	1	1	1	1		1	1	1	
	16 A	1	1					1	1		-							1	-		1		1	1			1		1	1		1	1	1	Paint Hall Cabinets
	17 A 18 A	1	1					1	1		\dashv				1			1			1	1		1			1		1	1		1	1	1	Paint Hall Cabinets
	18 A 19 A	1 1	1					1	1		\dashv		1		1	1		1	\dashv		1	1	1	1			1		1	1		1	1	1	railit Hall Cabillets
	20 C	3 1		1	1			1	1						2	1		1		2	1		1	1			2		2	1		2	2	1	
	1 C	3 1						1	1						1	1		1		2	1	1	1	1			2		2	1		2	2	1	
	2 C	3 1	.5					1	1				2		1			1		2	1	1	1	1		1	2		2	1		2	2	1	
Building 18	3 C	3 1						1	1		\perp	1	1		2			1		2	1	1	1				2		2	1		2	2	1	
	4 C	3 1			1			1	1		+		1		1		-	1	+	2	1	1	1	1			2		2	1		2	2	1	Add Seismic Strap to Water Heater
	5 C 6 C	3 1 3 1		1	1			1	1		\dashv		1		1	1		1	\dashv	2	1	1	1	1			2		2	1		2	2	1	Add Seismic Strap to Water Heater Replace Attic Access
Building 19	Office Community								Ė							-		-		_				_			_			-					
Total			2	28	33	0	0	120	120	0	8	9	44	0	110	40	4	120	0	240	120	40	120	120	15 1	120 1	181 1	120	175	120	0	175	17 5	120	0

PROJE

MADONNA ROAD APARTMENTS

A RENOVATION AND UPGRADE PROJECT

1550 MADONNA ROAD SAN LUIS OBISPO, CA

CLIENT JOB#

ARCHITECT JOB# 1207



971 OSOS STREET SAN LUIS OBISPO CALIFORNIA 93401

805-544-6161

www.fraserseiplearchitects.com

PROJECT MANAGER BDF

DRAWN BY DDL

08-08-2012 1st SUBMITTAL

09-19-2012 1st RE-SUBMITTAL
10-05-2012 FOR CONSTRUCTION

NED

ARCANIA

OUGLAS

PSER

C 9787

SER

SER

ARCANIA

OUGLAS

PSER

ARCANIA

OUGLAS

ARCANIA

The use of these plans and specifications shall be restricted to the original site for which they were prepared and publication thereof is expressly limited to such use. Reproduction or publication by any method, in whole or in part, is prohibited. Title to these plans and specifications remain with the architect without prejudice. Visual contact with these plans and specifications shall constitute prima facie evidence of the acceptance of these restrictions.

Written dimensions on these drawings shall have precedence over scaled dimensions. Contractors shall verify and be responsible for all dimensions and existing conditions on the job and shall report any discrepancies to the architect for resolution prior to commencing work.

SHEET TITLE

INTERIOR UNIT MATRIX

A8.01

	1										F**	Def: :								
	Location			l B					u	l .	Exterior		۶					>	<u>.</u>	
	Unit # Unit Type	3ed Rooms 3ath Rooms	Plaster Screed Separation / Spalling	Bent / Separating Roof Flashing	Crack in Plaster	Warping / Damaged T1-11	Disconnected Door Drip	Damaged Downspout	Bent Gutter Along Roof Edge	Moss on Utility Room Roof	<pre>lusted Door rame / Hinges Utility Closets)</pre>	Damaged Deck Plywood	Exposed Uncapped Beam	Jnprotected Jtility Pipes	Damaged / Separated Trim	eaking Gutter Seam	Jamaged Soffit Vent	Paint Mismatch /	Fire Extinguisher Cabinet (Broken Glass)	Jamaged Wall Vent
				, Ber			Dis	ğ Ö	Ber Alo	% ₹	Rus Fra (Ct	Dar Ply		5 5	Dar Sep	Lea	Dame	O ve	Cab (Br. Cab	Dama Vent
Building 1	111 / 116 C 112 / 117 B 113 / 118 B 114 / 119 B	3 1.5 2 1 2 1 2 1		S	S,E N N NW	S N		NE NE NW NE	N	NE NW			E,W							
Building 2	115 / 120 B 105 / 108 C 106 / 109 C	2 1 3 1.5 3 1.5				S W W		SW			W	N	E,W							
Building 3	107 / 110 C 97 / 101 B 98 / 102 B	3 1.5 2 1 2 1			S	S,W W S	S	SE SW	W		SE									
Building 4	99 / 103 B 100 / 104 B 93 / 95 A	2 1 2 1 1 1			N,W			SE SW	S		SW									
Building 5	94/96 A 89/91 B 90/92 B	1 1 2 1 2 1		S		S,W S S,E		SW NE,NW		N	N									
Building 6	81/85 C 82/86 C 83/87 D 84/88 D	3 1.5 3 1.5 4 1.5			W	S W W	S	SE SW SW NW	S		S			W	S					W
Building 7	73/77 B 74/78 B 75/79 B	4 1.5 2 1 2 1 2 1		E E	VV	S,W W W		NW,SW SW			SW				N W	W SW NW				3
Building 8	76 / 80 B Maintenance Sh	2 1 red	S,W			S,W														
Building 9	67 / 70 C 68 / 71 C 69 / 72 D	3 1.5 3 1.5 4 1.5		E	S			NE			N		E,W				E	S		
Building 10a	58/64 D 59/65 C 60/66 C	4 1.5 3 1.5 3 1.5	W N,S			S		NE SE					_,-		SW W	N SE	S			E
Building 10	55 / 61 C 56 / 62 C 57 / 63 D	3 1.5 3 1.5 4 1.5	N			W		NW,SW NW N, NW			W				W, SE	W	E SE	N	N	W
Building 11	49 / 52 B 50 / 53 C 51 / 54 C	2 1 3 1.5 3 1.5	E,SW S N,E,S	S	N	N,S S		N, NE NW		N	N				SW		W			
Building 12	41 /45 D 42 / 46 D 43 / 47 C	4 1.5 4 1.5 3 1.5		S E		S,E S N,S		NE SE SE						E			SW			
Building 13	44/48 C 37/39 D 38/40 B	3 1.5 4 1.5 2 1	S,E			S W W		SE,SW SE NE,SE			E				N,W	E	W			
Building 14	33 / 35 B 34 / 36 B	2 1 2 1				S,W S		,							N		S			
Building 15	29/31 A 30/32 A 21/25 B	1 1 1 1 2 1	S	S	S N	S,W W		NE,SE NE,SE SW			E				E,W W					s
Building 16	22/26 B 23/27 B 24/28 B	2 1 2 1 2 1 2 1	S,E		S	S N N,S	S	SW SE SW			S				S					3
– Building 17	07/14 A 08/15 A 09/16 A 10/17 A	1 1 1 1 1 1 1 1				\$ \$ \$ \$		NE,NW NW			NE				S					
	11 / 18 A 12 / 19 A 13 / 20 C	1 1 1 1 3 1.5				N,S S		NE NW			NW		E,W		S					N
Building 18	01/04 C 02/05 C 03/06 C	3 1.5 3 1.5 3 1.5		NW,E SW,W		W		NE	E		E		E,W		NE		W			E

Defects that occur at all buildings and are therefore not listed above include the following:

Warn deck finish at upper floor landings

Peeling / cracking paint on exposed face of building slabs

Peeling / cracking powder coat & rust at steel stair stringers

Rust on exposed bolt heads supporting vertical slats at upper floor landings
Building cleanouts do not extend beyond face of plaster, allowing water to enter the walls

Separation between plaster and wall penetrations (vents and utilities) allow water to enter walls

MADONNA ROAD APARTMENTS

A RENOVATION AND **UPGRADE PROJECT**

1550 MADONNA ROAD SAN LUIS OBISPO, CA

CLIENT JOB#

ARCHITECT JOB# 1207



971 OSOS STREET SAN LUIS OBISPO CALIFORNIA 93401

805-544-6161

www.fraserseiplearchitects.com

PROJECT MANAGER BDF

DRAWN BY DDL

08-08-2012 1st SUBMITTAL 09-19-2012 1st RE-SUBMITTAL 10-05-2012 FOR CONSTRUCTION




The use of these plans and specifications shall be restricted to the original site for which they were prepared and publication thereof is expressly limited to such use. Reproduction or publication by any method, in whole or in part, is prohibited. Title to these plans and specifications remain with the architect without prejudice. Visual contact with these plans and specifications shall constitute prima facie evidence of the acceptance of these restrictions.


Written dimensions on these drawings shall have precedence over scaled dimensions. Contractors shall verify and be responsible for all dimensions and existing conditions on the job and shall report any discrepancies to the architect for resolution prior to commencing work.

SHEET TITLE

EXTERIOR REPAIR MATRIX

A8.02

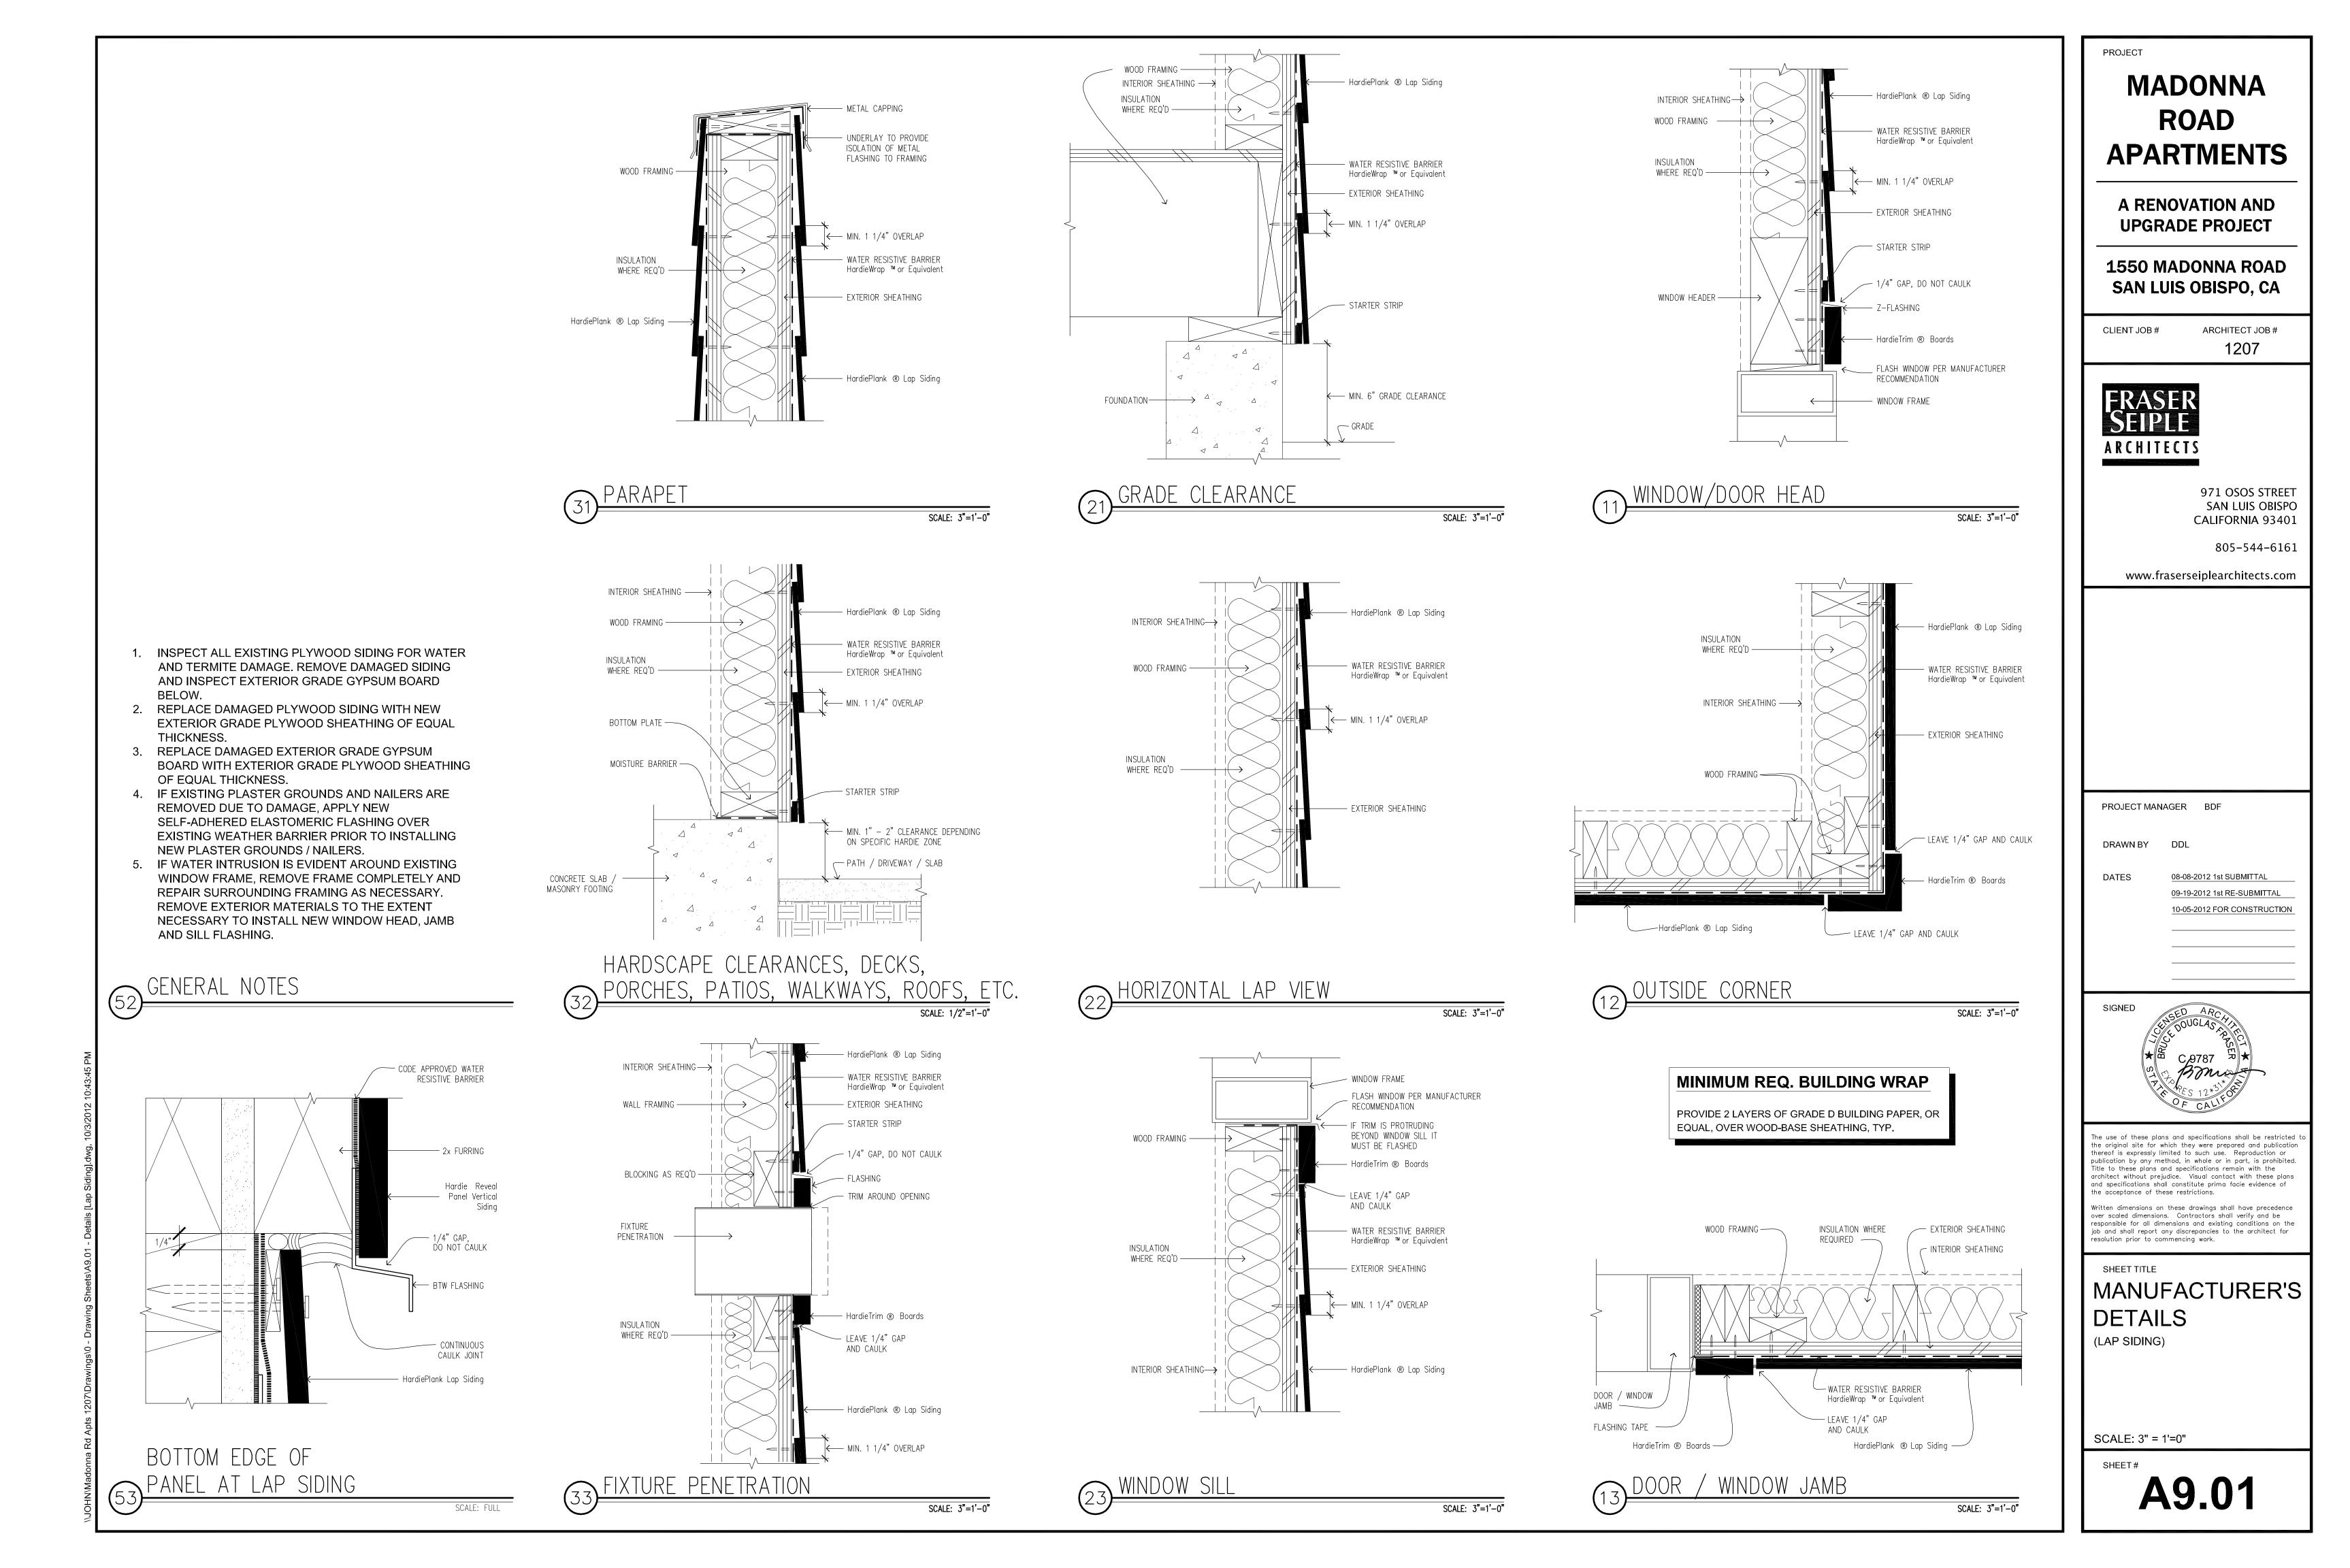

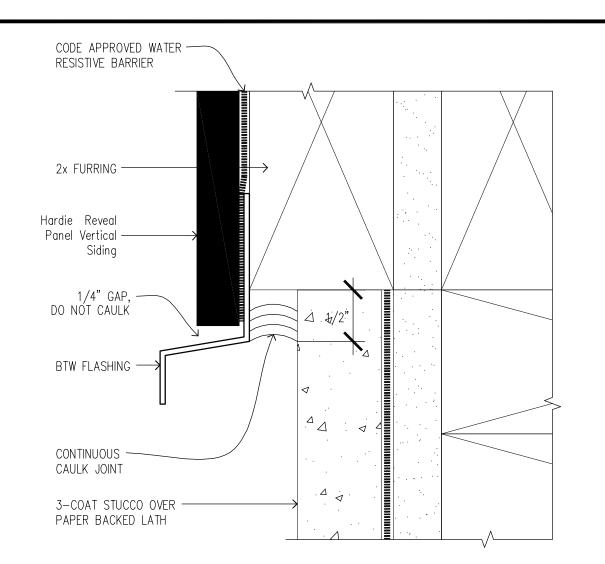


BOTTOM EDGE OF


DETAILS 41 & 53 ARE NOT A STANDARD MANUFACTURER'S DETAILS. VERIFY THAT MANUFACTURER WILL WARRANTY THIS INSTALLATION AS DETAILED.

MINIMUM REQ. BUILDING WRAP

PROVIDE 2 LAYERS OF GRADE D BUILDING PAPER, OR EQUAL, OVER WOOD-BASE SHEATHING, TYP.

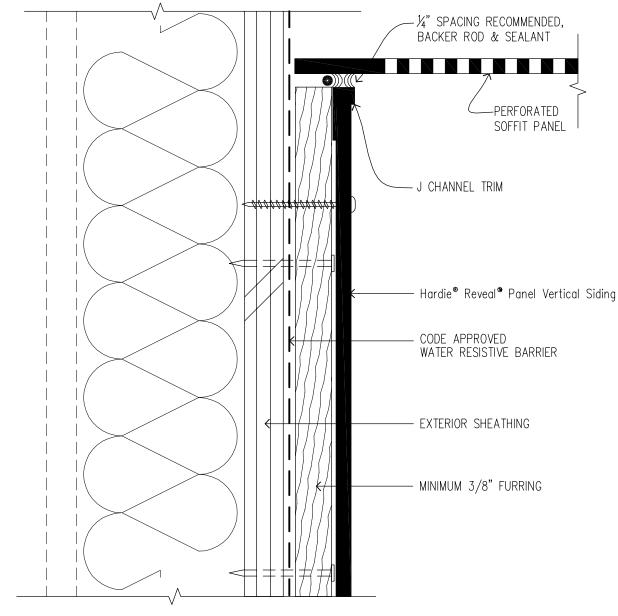

SCALE: 6"=1'-0"

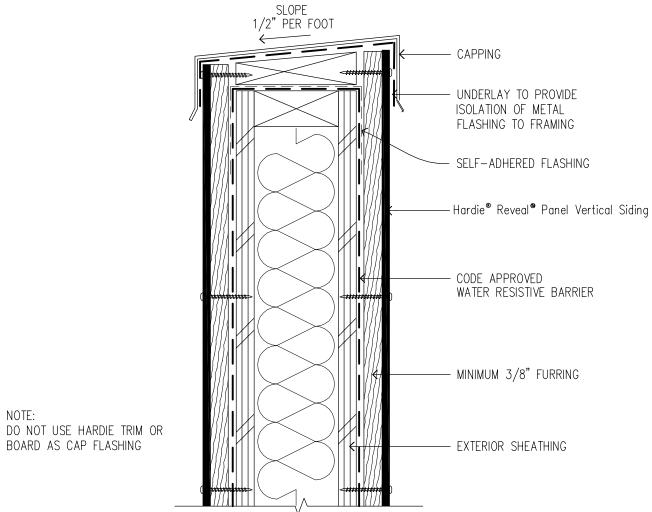

SCALE: 3"=1'-0" Timber Studs Water-resistive

Termination

Factory cut ends

end detail -

INSPECT ALL EXISTING PLYWOOD SIDING FOR WATER AND TERMITE DAMAGE. REMOVE DAMAGED SIDING Apply sealant AND INSPECT EXTERIOR GRADE GYPSUM BOARD BELOW. 2. REPLACE DAMAGED PLYWOOD SIDING WITH NEW EXTERIOR GRADE PLYWOOD SHEATHING OF EQUAL THICKNESS. 3. REPLACE DAMAGED EXTERIOR GRADE GYPSUM BOARD WITH EXTERIOR GRADE PLYWOOD SHEATHING

Utilize "Horizontal

Trim - Termination"

when intersecting Horizontal

Trim. Apply sealant as noted.

2. Exterior and interior Reveal

Corner. Trims should always


run bottom to top in a continuous


3. James Hardie recommends

Hardie Wrap water resistive barrier


Trim with outside Corner

- OF EQUAL THICKNESS.
- IF EXISTING PLASTER GROUNDS AND NAILERS ARE REMOVED DUE TO DAMAGE, APPLY NEW SELF-ADHERED ELASTOMERIC FLASHING OVER EXISTING WEATHER BARRIER PRIOR TO INSTALLING NEW PLASTER GROUNDS / NAILERS.
- IF WATER INTRUSION IS EVIDENT AROUND EXISTING WINDOW FRAME, REMOVE FRAME COMPLETELY AND REPAIR SURROUNDING FRAMING AS NECESSARY. REMOVE EXTERIOR MATERIALS TO THE EXTENT NECESSARY TO INSTALL NEW WINDOW HEAD, JAMB AND SILL FLASHING.

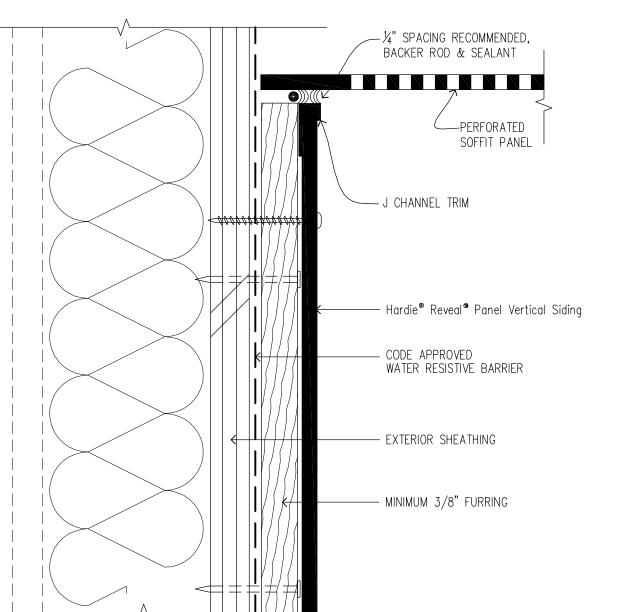


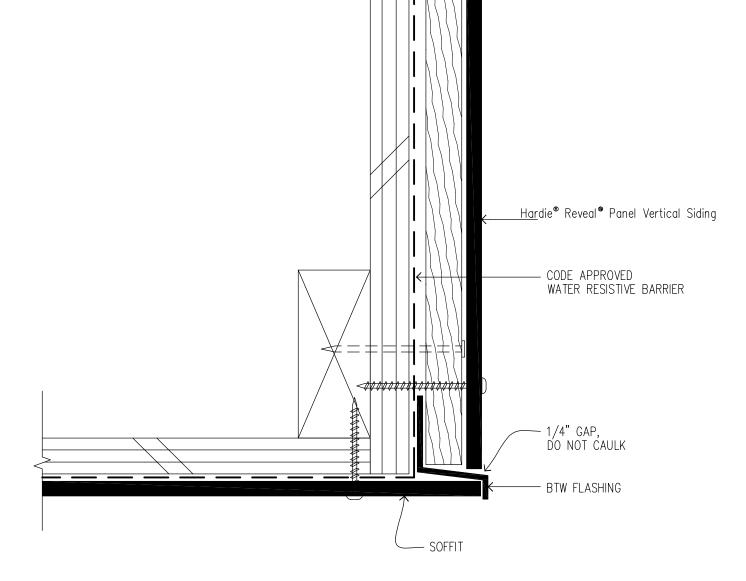


SCALE: 6"=1'-0"

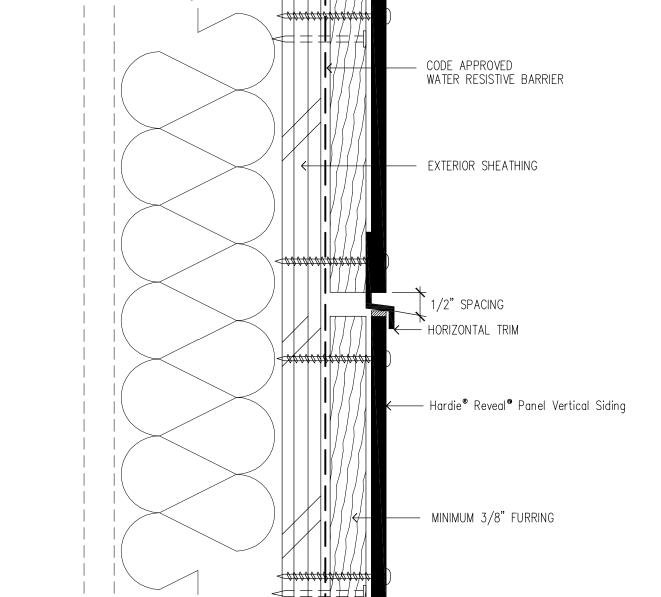


PANEL WITH HORIZONTAL TRIM SCALE: 6"=1'-0"

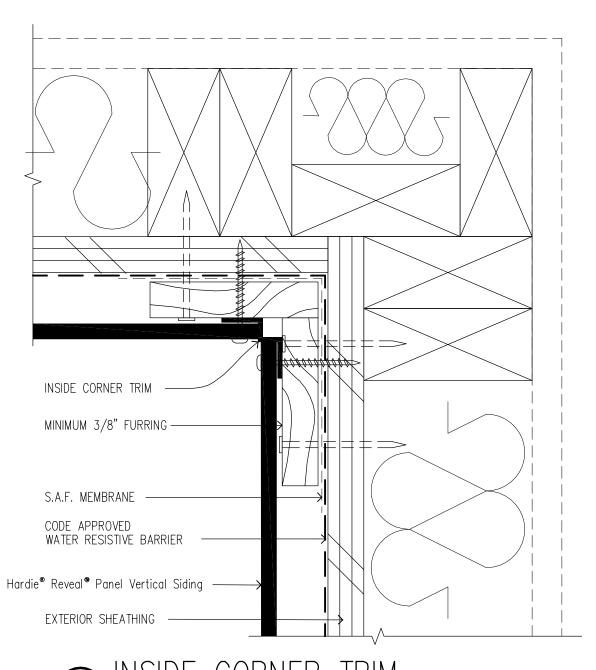

SCALE: 6"=1'-0" - Hardie® Reveal® Panel Vertical Siding CODE APPROVED WATER RESISTIVE BARRIER - MINIMUM 3/8" FURRING — EXTERIOR SHEATHING — BUG SCREEN — 1/4" SPACING MINIMUM SILL SEAL (AS REQ'D PER —HORIZONTAL TRIM — MIN. 6" GRADE CLEARANCE OR CODE REQ'D, WHICHEVER IS

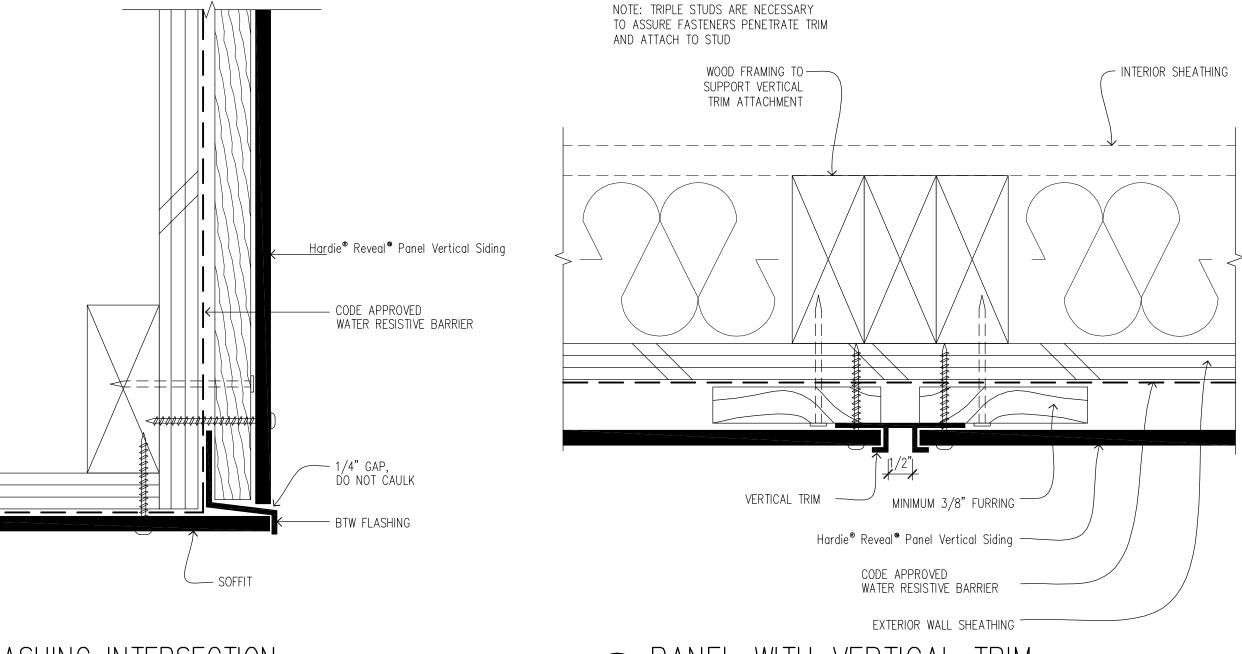

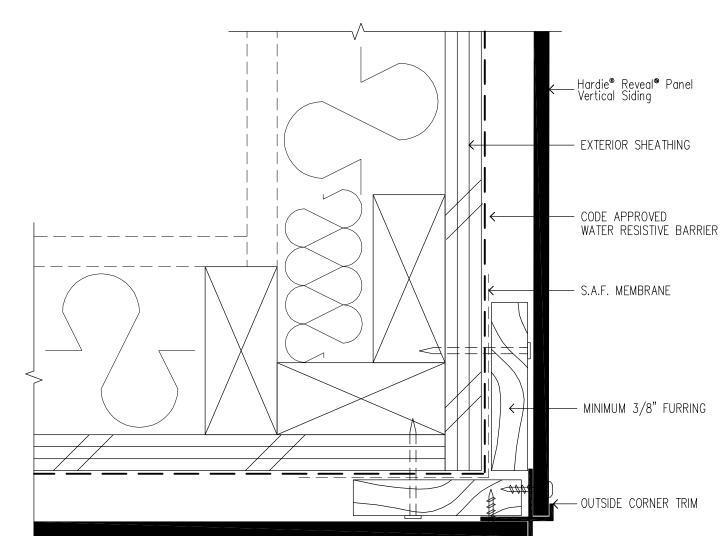

PROJECT MANAGER BDF

PROJECT

CLIENT JOB#

ARCHITECTS

SCALE: 6"=1'-0"

MADONNA

ROAD

APARTMENTS

A RENOVATION AND

UPGRADE PROJECT

1550 MADONNA ROAD

SAN LUIS OBISPO, CA

ARCHITECT JOB#

1207

971 OSOS STREET SAN LUIS OBISPO CALIFORNIA 93401

805-544-6161

www.fraserseiplearchitects.com

DRAWN BY DDL

08-08-2012 1st SUBMITTAL 09-19-2012 1st RE-SUBMITTAL 10-05-2012 FOR CONSTRUCTION

SIGNED

The use of these plans and specifications shall be restricted the original site for which they were prepared and publication thereof is expressly limited to such use. Reproduction or publication by any method, in whole or in part, is prohibited. Title to these plans and specifications remain with the architect without prejudice. Visual contact with these plans and specifications shall constitute prima facie evidence of ne acceptance of these restrictions.

Written dimensions on these drawings shall have precedence over scaled dimensions. Contractors shall verify and be responsible for all dimensions and existing conditions on the job and shall report any discrepancies to the architect for resolution prior to commencing work.

SHEET TITLE

MANUFACTURER'S **DETAILS**

(PANEL REVEAL)

SCALE: 3" = 1'=0"

A9.02

NOTE: DO NOT USE HARDIE TRIM OR BOARD AS CAP FLASHING

sheathing

Flashing

SCALE: 6"=1'-0"

DUNDATION @ GRADE

SCALE: 3"=1'-0"

NOTE: DO NOT USE J-CHANNEL TRIM

ON THE BOTTOM EDGE OF PANEL

GREATER

---- GRADE

----STAINLESS STEEL HOSE CLAMP

-RAIN COLLAR WITH HIGH TEMPERATURE SEALANT

-SARNAFIL FLASHING MEMBRANE

SARNADISC

-SARNAFASTENER AND

FLASHING,

—SARNAFIL BASE

HOT-AIR WELDED

MEMBRANE, ADHERED


STRUCTURAL DECK


1/4" ROOF BOARD, (12) 2 1/2"


WOOD SCREWS PER 4X8 BOARD

W/ 3" ROUND STEEL PLATES

---HOT STACK

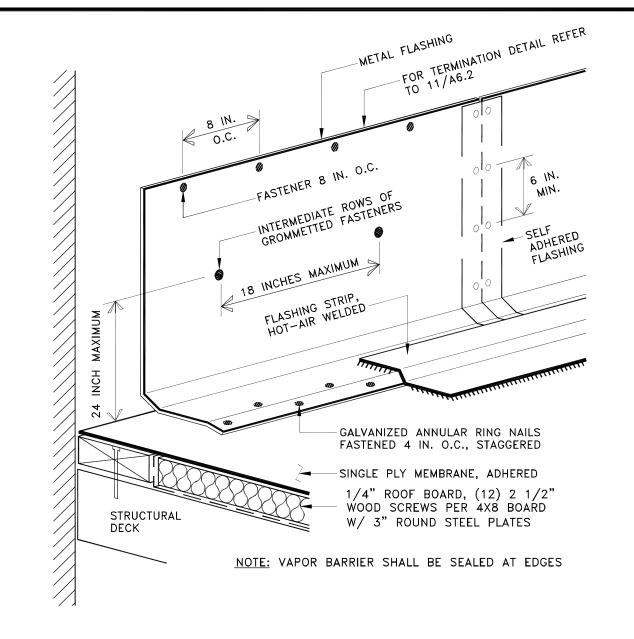

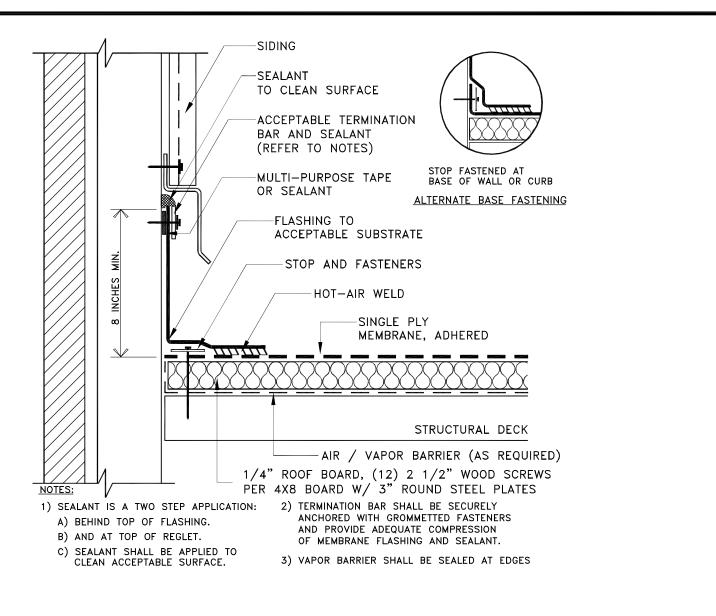

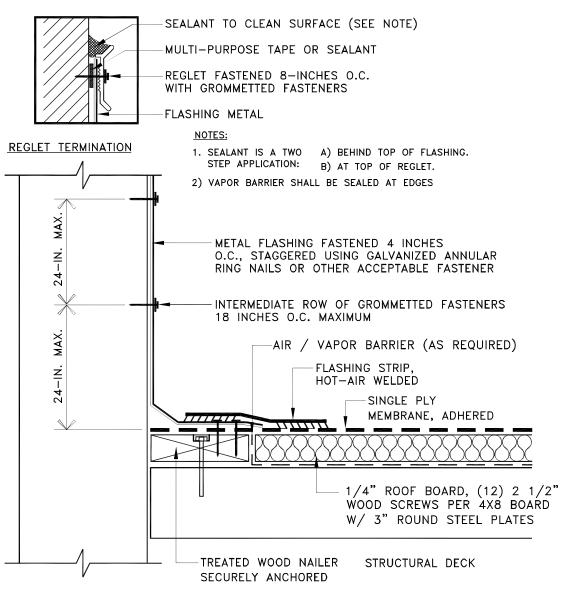

FASCIA PLATE AT SPLICE

METAL CURB

(OPTIONAL)

FIBERGLASS

NOTES:

BATTEN -

METAL FLASHING

—PIPE PENETRATION -SEALANT (SEE NOTE) -STAINLESS STEEL HOSE CLAMP -ALUMINUM TAPE (SEE NOTE) -FLASHING MEMBRANE -FASTENER AND DISC -BASE FLASHING, -SINGLE PLY MEMBRANE, ADHERED STRUCTURAL DECK 1/4" ROOF BOARD, (12) 2 1/2" WOOD SCREWS PER 4X8 BOARD W/ 3" ROUND STEEL PLATES -AIR / VAPOR BARRIER (AS REQUIRED)

1) ALUMINUM TAPE IS REQUIRED IF EXISTING PENETRATION IS CONTAMINATED. 2) VAPOR BARRIER SHALL BE SEALED AT EDGES

FLASHING AT SIDING

-METAL GUTTER --- METAL GUTTER SUPPORT SARNACLAD METAL FASTENED 4 IN. O.C., STAGGERED USING 1-INCH GALVANIZED ANNULAR RING NAILS OR OTHER ACCEPTABLE FASTENER — SARNAFIL FLASHING STRIP, HOT-AIR WELDED ---TREATED WOOD NAILERS TO MATCH HEIGHT OF INSULATION -SARNAFIL MEMBRANE 1/4" ROOF BOARD, (12) 2 1/2" WOOD SCREWS PER 4X8 BOARD W/ 3" ROUND STEEL PLATES STRUCTURAL DECK - AIR / VAPOR BARRIER (AS REQUIRED) 1) NAILERS SHALL BE SECURELY ANCHORED TO THE DECK TO RESIST A MINIMUM FORCE OF 300 POUNDS PER LINEAR FOOT. FOLLOW FACTORY MUTUAL LOSS PREVENTION DATA SHEET 1-49 RECOMMENDATIONS. 2) THE THICKNESS OF THE NAILER SHALL MATCH THE HEIGHT OF THE INSULATION OR SURFACE TO WHICH THE MEMBRANE IS TO BE APPLIED. 3) VAPOR BARRIER SHALL BE SEALED AT EDGES

METAL FLASHING AT WALL

—— CONTINUOUS METAL HOOK STRIP (MIN. 22 GAUGE) -SARNACLAD METAL FASTENED 4 IN. O.C., STAGGERED USING 1-INCH GALVANIZED ANNULAR RING NAILS OR OTHER ACCEPTABLE FASTENER — SARNACLAD WATER DAM (OPTIONAL) SARNAFIL FLASHING STRIP, HOT—AIR WELDED ---TREATED WOOD NAILERS TO MATCH HEIGHT OF INSULATION -SARNAFIL MEMBRANE 1/4" ROOF BOARD, (12) 2 1/2" WOOD SCREWS PER 4X8 BOARD W/ 3" ROUND STEEL PLATES STRUCTURAL DECK AIR / VAPOR BARRIER (AS REQUIRED) MULTI- -PURPOSE TAPE 1) NAILERS SHALL BE SECURELY ANCHORED TO THE DECK TO RESIST A MINIMUM FORCE OF 300 POUNDS PER LINEAR FOOT. FOLLOW FACTORY MUTUAL LOSS PREVENTION DATA SHEET 1-49 RECOMMENDATIONS. 2) THE THICKNESS OF THE NAILER SHALL MATCH THE HEIGHT OF THE INSULATION OR SURFACE TO WHICH

ROOF EDGE FLASHING

THE MEMBRANE IS TO BE APPLIED.

3) VAPOR BARRIER SHALL BE SEALED AT EDGES

DEMOLITION OF (E) ROOFING

DOWN TO EXISTING 5/8" PLYWOOD SHEATHING

DEMOLISH EXISTING 4-PLY CAP SHEET ROOF SYSTEM

HEATED STACK FLASHING


1) SARNAFIL MEMBRANE SHALL NOT BE IN CONTACT WITH SURFACES

HAVING SUSTAINED TEMPERATURES ABOVE 160 F.

2) VAPOR BARRIER SHALL BE SEALED AT EDGES

PIPE PENETRATION FLASHING

GUTTER FLASHING

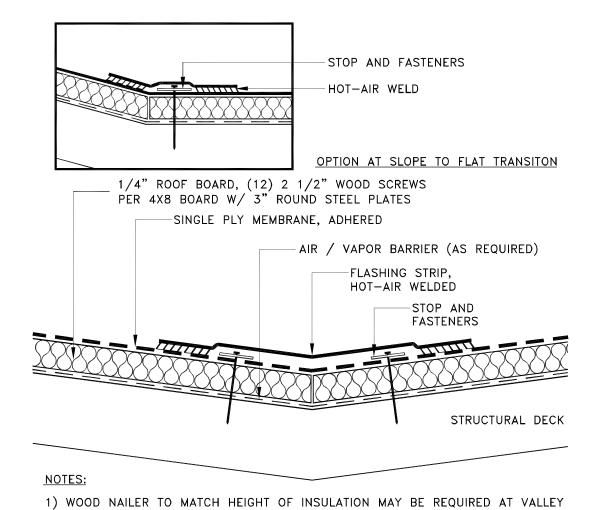

IF INSULATION THICKNESS EXCEEDS 2 INCHES. 2) VAPOR BARRIER SHALL BE SEALED AT EDGES

PIPE PENETRATION -SARNAFIL SEALANT (SEE NOTE) -STAINLESS STEEL HOSE CLAMP 1 IN. MIN. -SARNAFIL FLASHING MEMBRANE -SARNAFASTENER AND —SARNAFIL BASE FLASHING, HOT-AIR WELDED —SARNAFIL G410 MEMBRANE, ADHERED STRUCTURAL DECK 1/4" ROOF BOARD, (12) 2 1/2" - WOOD SCREWS PER 4X8 BOARD W/ 3" ROUND STEEL PLATES —AIR / VAPOR BARRIER (AS REQUIRED)

1) SEALANT IS A MAINTENANCE ITEM. MAINTENANCE IS NOT COVERED UNDER SARNAFIL WARRANTY. 2) VAPOR BARRIER SHALL BE SEALED AT EDGES

PIPE PENETRATION -MEMBRANE CAP -ALUMINUM TAPE (SEE NOTE) -FLASHING MEMBRANE -FASTENER AND DISC BASE FLASHING, HOT-AIR WELDED -SINGLE PLY MEMBRANE, ADHERED STRUCTURAL DECK 1/4" ROOF BOARD, (12) 2 1/2" WOOD SCREWS PER 4X8 BOARD W/ 3" ROUND STEEL PLATES —AIR / VAPOR BARRIER (AS REQUIRED)

1) ALUMINUM TAPE IS REQUIRED IF EXISTING PENETRATION IS CONTAMINATED. 2) VAPOR BARRIER SHALL BE SEALED AT EDGES

SLOPE TRANSITION

-SINGLE PLY MEMBRANE, ADHERED -FLASHING STRIP, HOT-AIR WELDED -AIR / VAPOR BARRIER (AS REQUIRED) -STOP AND FASTENERS STRUCTURAL DECK 1/4" ROOF BOARD, (12) 2 1/2" WOOD SCREWS PER 4X8 BOARD W/ 3" ROUND STEEL PLATES

1) WOOD NAILER TO MATCH HEIGHT OF INSULATION MAY BE REQUIRED AT PEAK IF INSULATION THICKNESS EXCEEDS 2 INCHES. 2) VAPOR BARRIER SHALL BE SEALED AT EDGES

PEAK / RIDGE

MADONNA ROAD **APARTMENTS**

PROJECT

A RENOVATION AND **UPGRADE PROJECT**

1550 MADONNA ROAD SAN LUIS OBISPO, CA

CLIENT JOB# ARCHITECT JOB# 1207



ARCHITECTS

971 OSOS STREET SAN LUIS OBISPO CALIFORNIA 93401

805-544-6161

www.fraserseiplearchitects.com


PROJECT MANAGER BDF

DRAWN BY DDL

08-08-2012 1st SUBMITTAL 09-19-2012 1st RE-SUBMITTAL

10-05-2012 FOR CONSTRUCTION

SIGNED

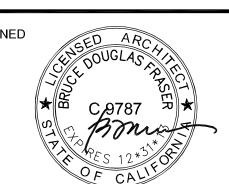

The use of these plans and specifications shall be restricted the original site for which they were prepared and publication thereof is expressly limited to such use. Reproduction or publication by any method, in whole or in part, is prohibited Title to these plans and specifications remain with the architect without prejudice. Visual contact with these plans and specifications shall constitute prima facie evidence of e acceptance of these restrictions.

Written dimensions on these drawings shall have precedence over scaled dimensions. Contractors shall verify and be esponsible for all dimensions and existing conditions on the

job and shall report any discrepancies to the architect for resolution prior to commencing work.


MANUFACTURER'S **DETAILS**


(SINGLE-PLY ROOFING)

SCALE: N.T.S.

CONE FLASHING

VENT STACK FLASHING

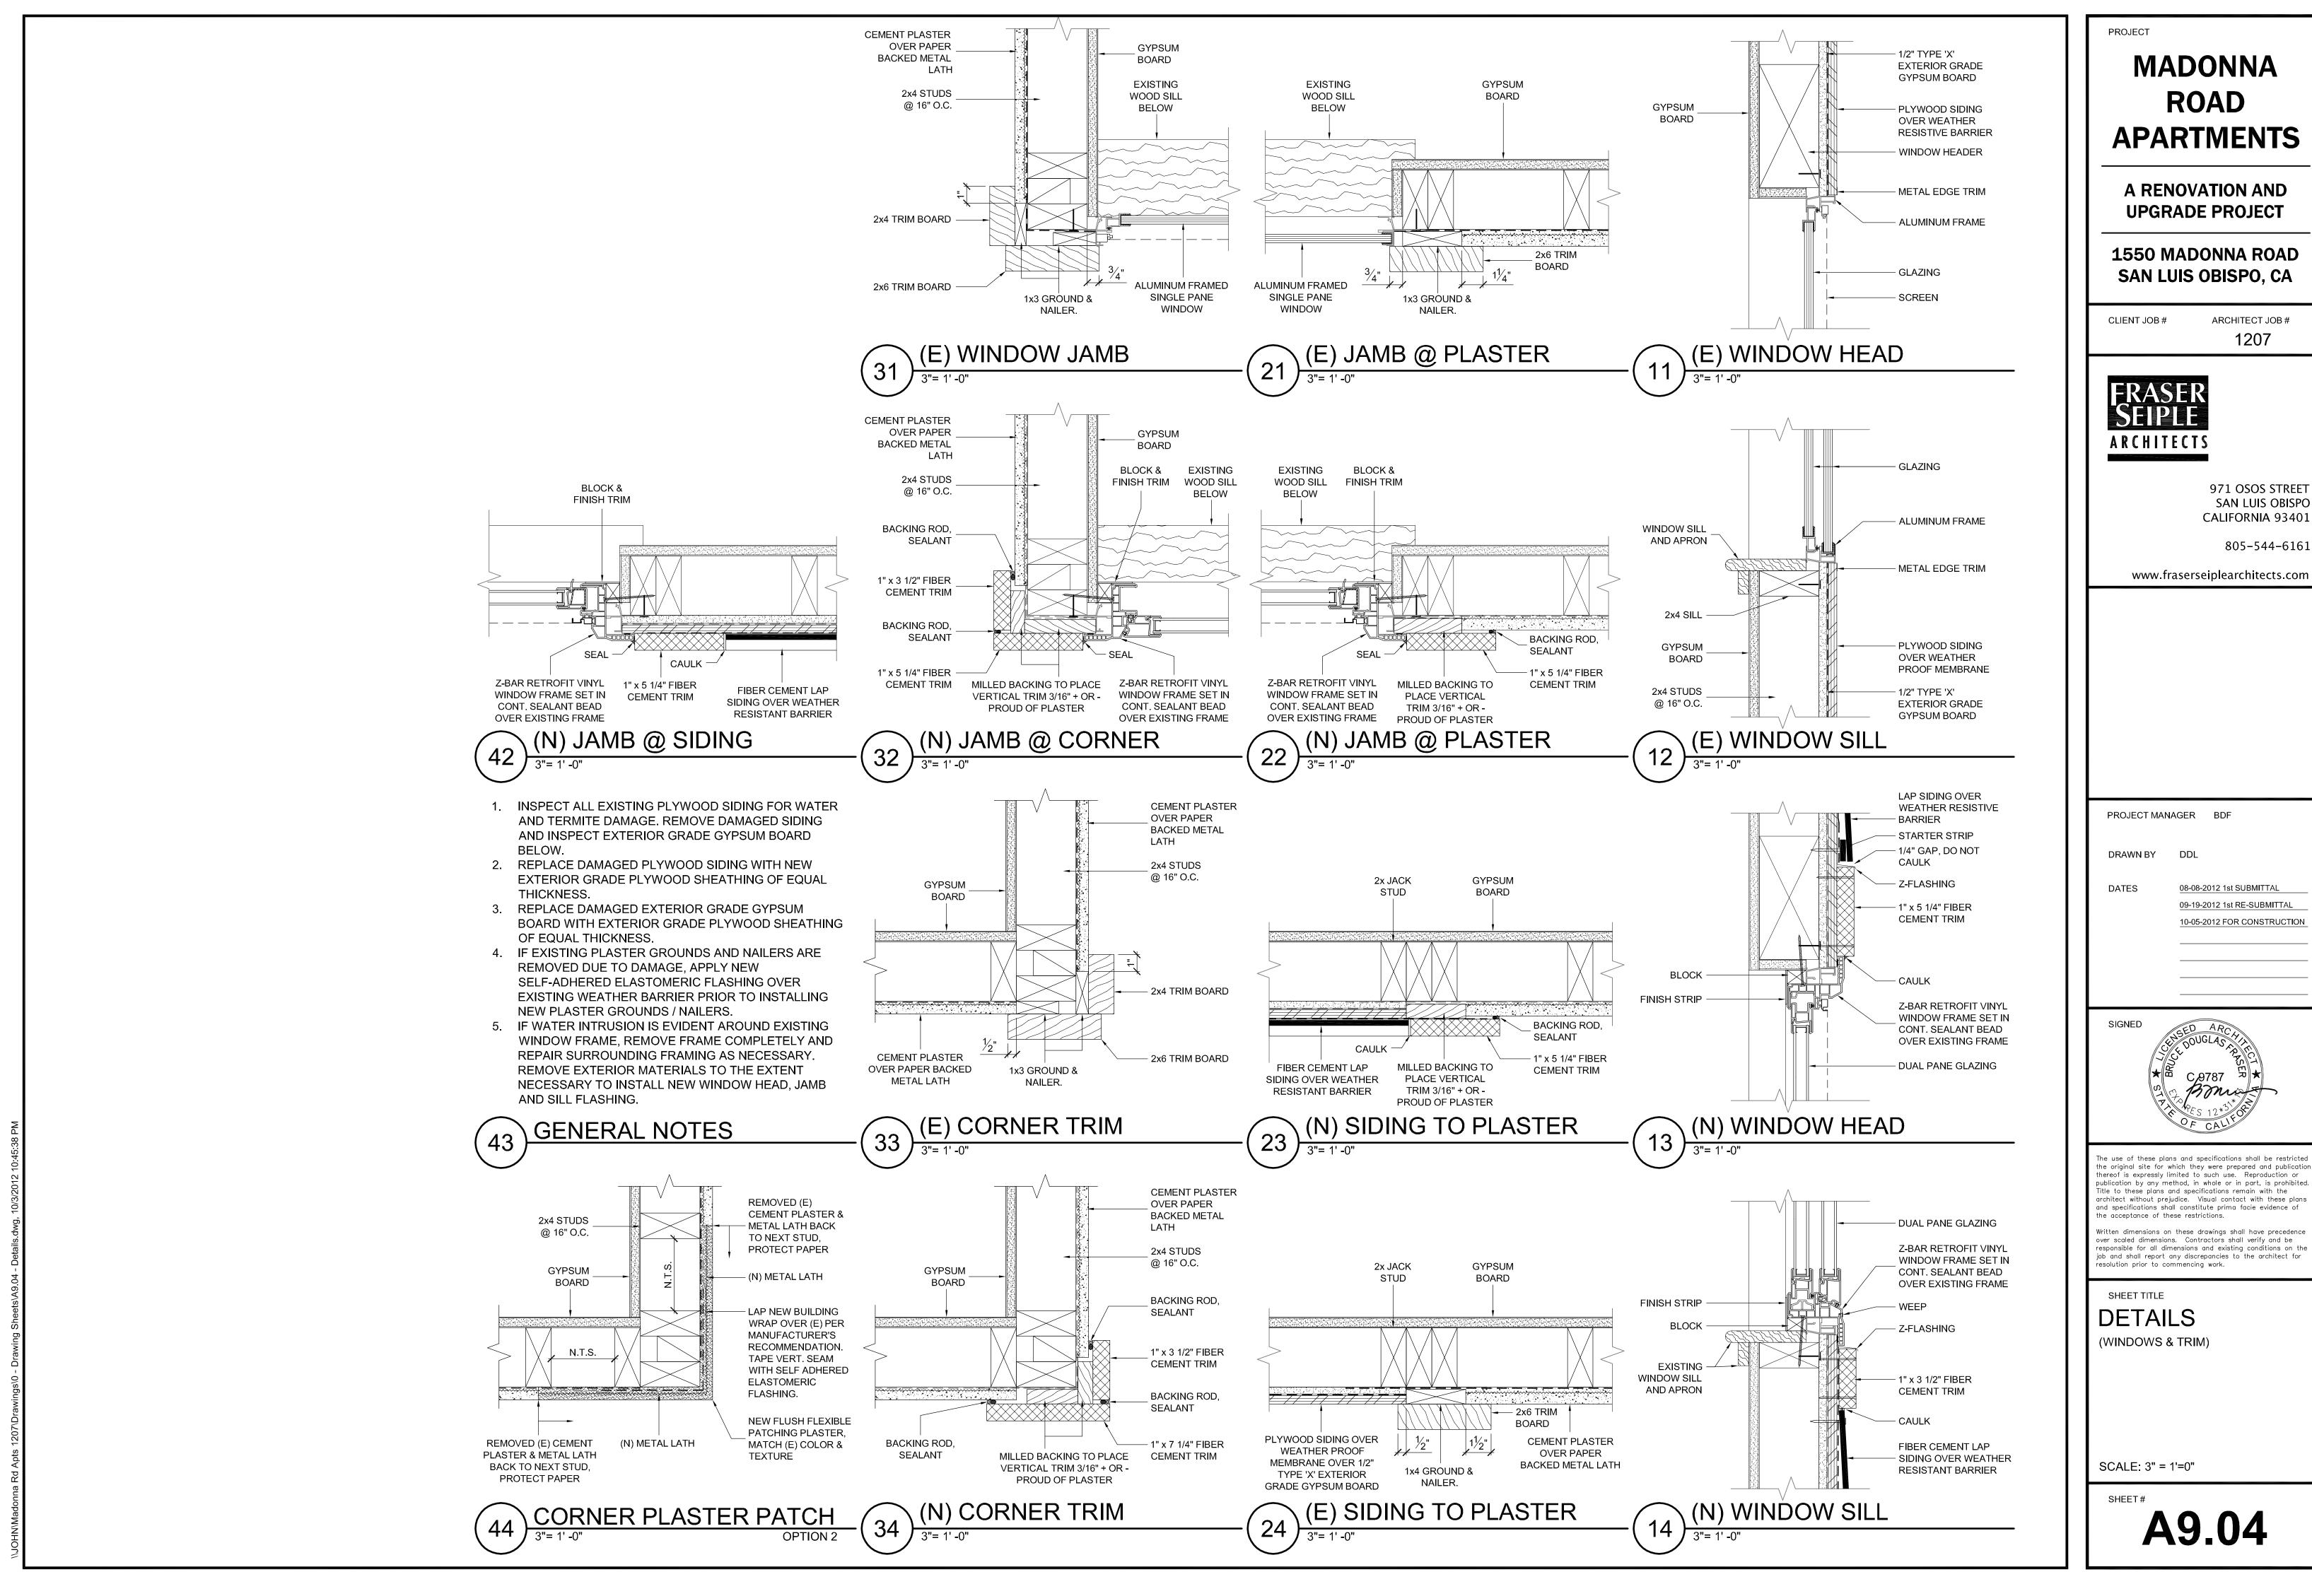

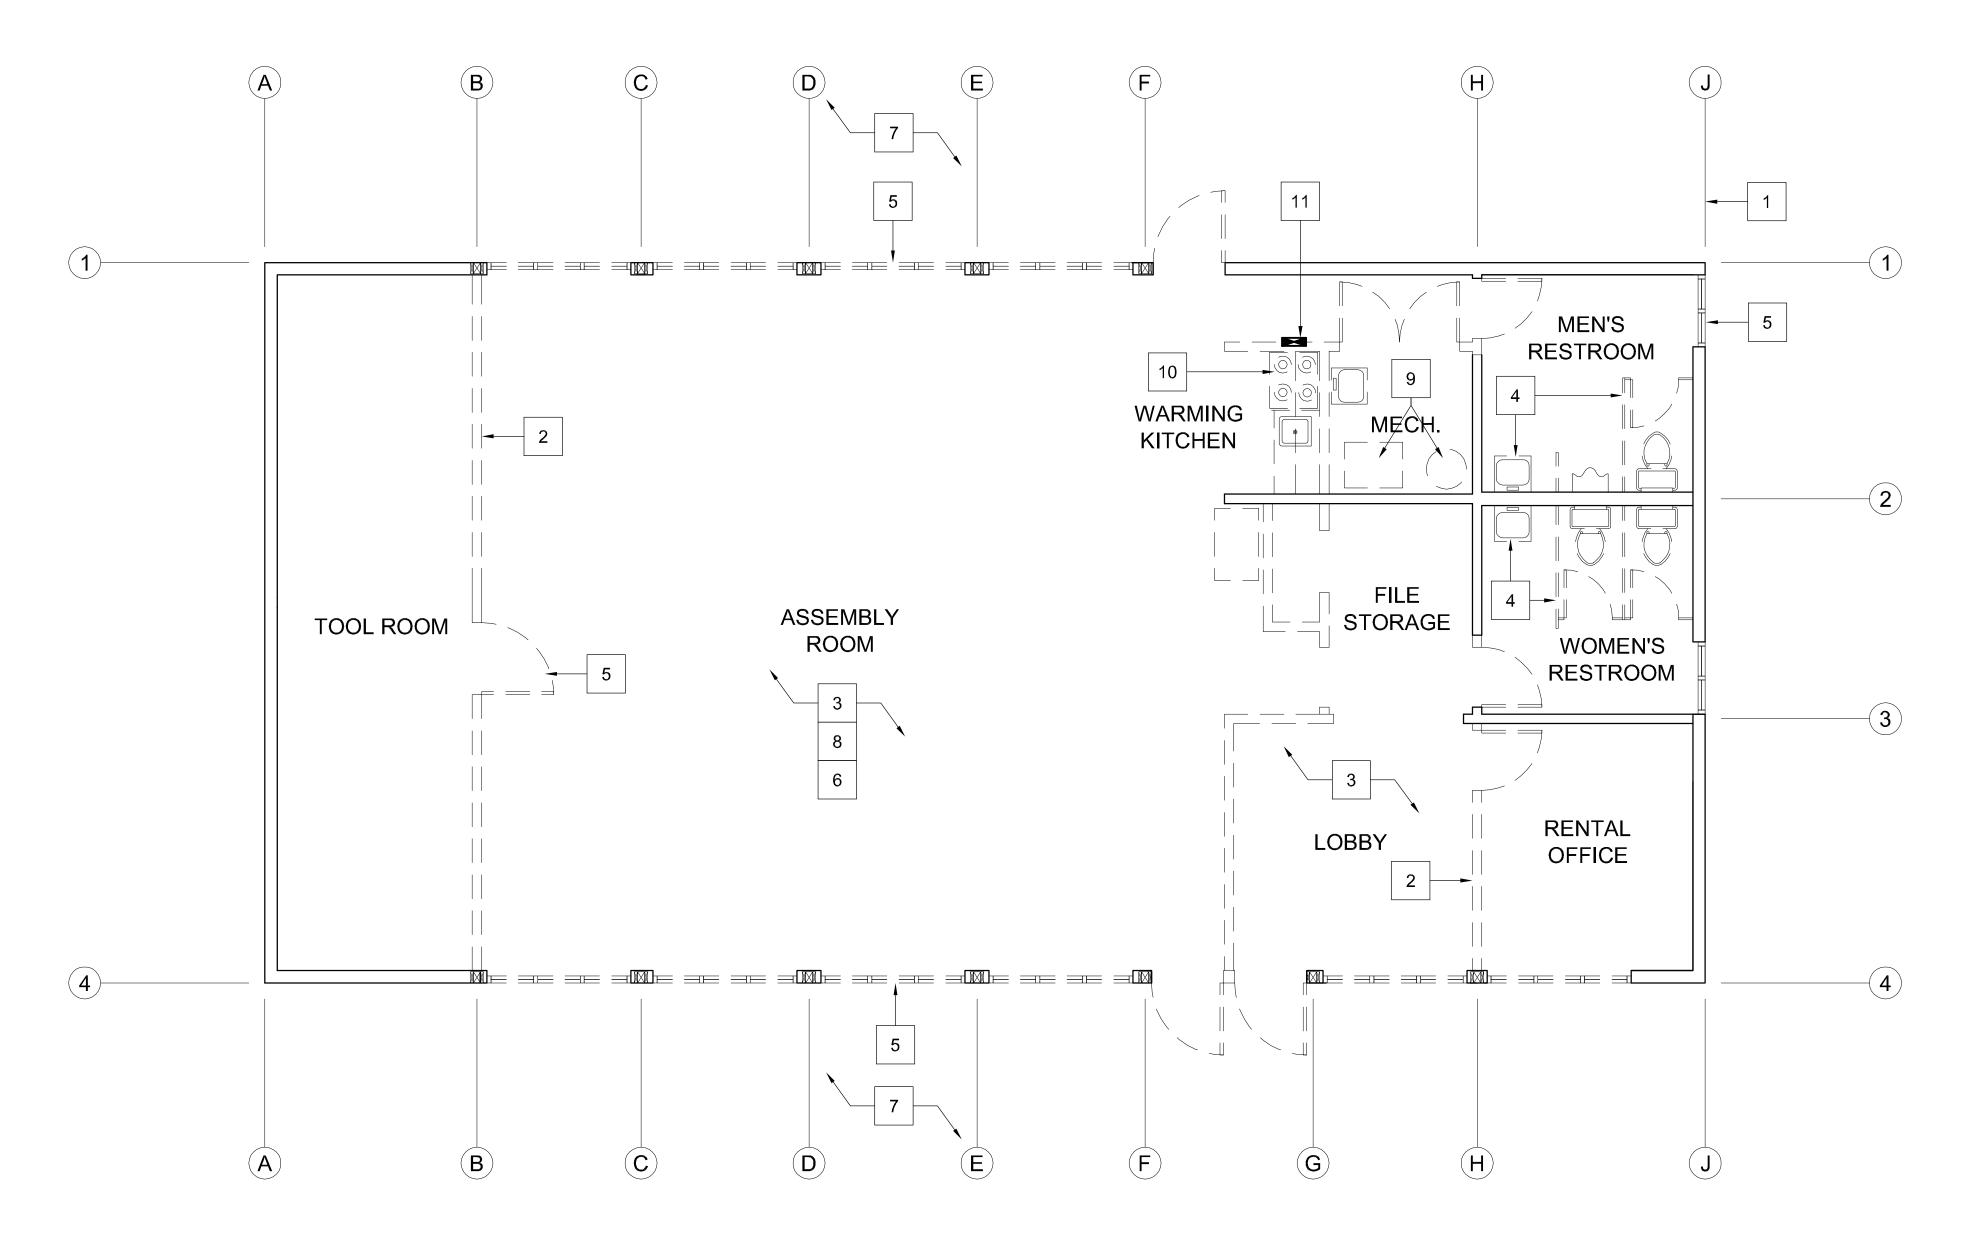


DEMOLITION FLOOR PLAN (COMMON BUILDING)

DEMOLITION KEYNOTES

- 1. ALL GRID LINES ARE TO EXTERIOR FACE OF PERIMETER WALL STUD / CENTER OF INTERIOR WALL STUD U.O.N.
- 2. DASHED LINES INDICATE EXTENT OF DEMOLITION.
- 3. REMOVE ALL FLOORING DOWN TO CONCRETE.
- 4. REMOVE ALL PLUMBING FIXTURES, PARTITIONS AND ACCESSORIES. REMOVE FRP / TILE WALL COVERINGS DOWN TO GYPSUM BOARD AND REPAIR AS REQUIRED.
- 5. REMOVE ALL INTERIOR AND EXTERIOR WINDOWS AND DOORS / DOOR FRAMES.
- 6. REMOVE ALL EXISTING LIGHT FIXTURES AND AIR GRILLES.
- 7. DEMOLISH ALL EXISTING PLYWOOD SIDING, SOFFITS AND FASCIAS.
- 8. SCRAPE TEXTURE OFF GYPSUM BOARD CEILING.
- 9. REMOVE EXISTING FURNACE AND WATER HEATER AND DEMOLISH NON-COMPLIANT PLATFORM. DEMOLISH ALL EXISTING DUCTWORK.
- 10. DEMOLISH EXISTING KITCHENETTE.
- 11. DISCONNECT AND REMOVE EXISTING ELECTRICAL PANEL.

BUILDING KEY PLAN

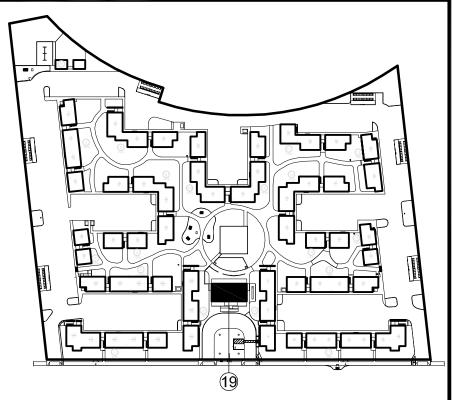

MADONNA ROAD APARTMENTS

A RENOVATION AND **UPGRADE PROJECT**

1550 MADONNA ROAD SAN LUIS OBISPO, CA

CLIENT JOB#

1207

ARCHITECT JOB#



971 OSOS STREET SAN LUIS OBISPO CALIFORNIA 93401

805-544-6161

www.fraserseiplearchitects.com

PROJECT MANAGER BDF

DRAWN BY DDL

08-08-2012 1st SUBMITTAL 09-19-2012 1st RE-SUBMITTAL 10-05-2012 FOR CONSTRUCTION




The use of these plans and specifications shall be restricted the original site for which they were prepared and publication thereof is expressly limited to such use. Reproduction or publication by any method, in whole or in part, is prohibited. Title to these plans and specifications remain with the architect without prejudice. Visual contact with these plans and specifications shall constitute prima facie evidence of ne acceptance of these restrictions.

Written dimensions on these drawings shall have precedence over scaled dimensions. Contractors shall verify and be responsible for all dimensions and existing conditions on the job and shall report any discrepancies to the architect for resolution prior to commencing work.

DEMOLITION FLOOR PLAN

(COMMON BUILDING)

SCALE: 1/4" = 1'=0"

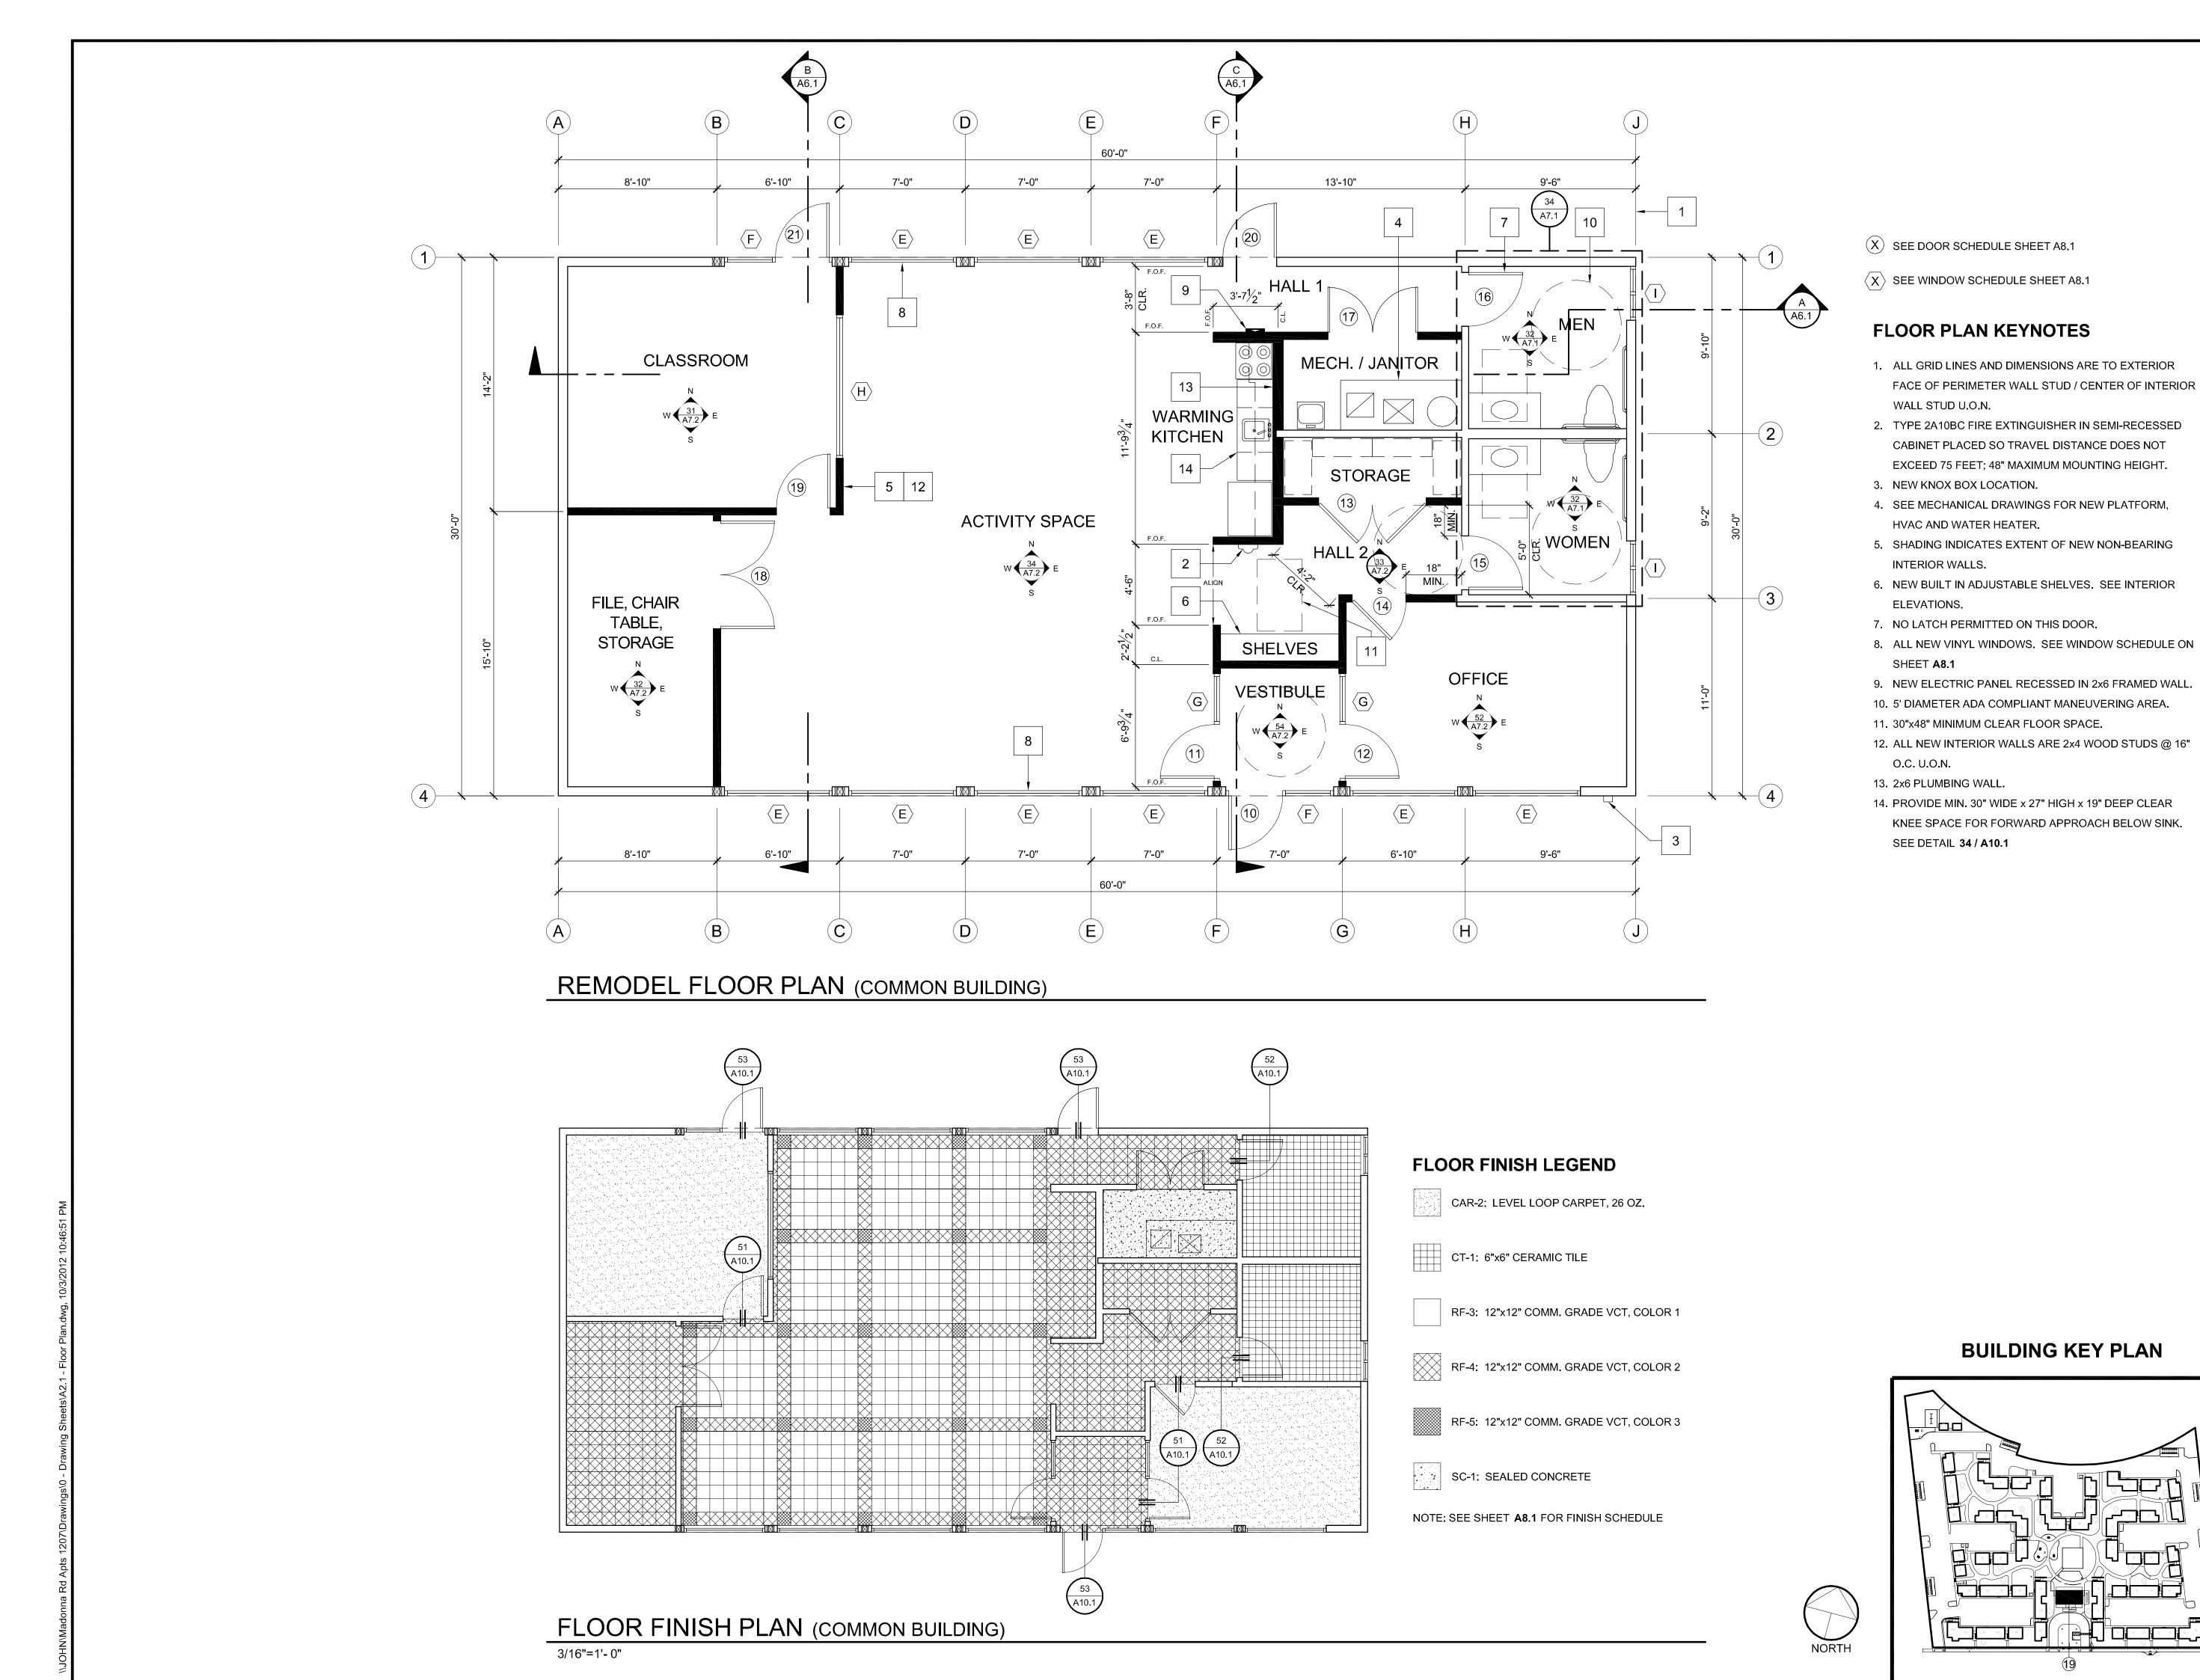

MADONNA ROAD APARTMENTS

A RENOVATION AND UPGRADE PROJECT

1550 MADONNA ROAD SAN LUIS OBISPO, CA

CLIENT JOB#

ARCHITECT JOB# 1207



971 OSOS STREET SAN LUIS OBISPO CALIFORNIA 93401

805-544-6161

www.fraserseiplearchitects.com

PROJECT MANAGER BDF

DRAWN BY DDL

08-08-2012 1st SUBMITTAL
09-19-2012 1st RE-SUBMITTAL
10-05-2012 FOR CONSTRUCTION

ED GED ARCA



The use of these plans and specifications shall be restricted the original site for which they were prepared and publication thereof is expressly limited to such use. Reproduction or publication by any method, in whole or in part, is prohibited. Title to these plans and specifications remain with the architect without prejudice. Visual contact with these plans and specifications shall constitute prima facie evidence of the acceptance of these restrictions.

Written dimensions on these drawings shall have precedence over scaled dimensions. Contractors shall verify and be responsible for all dimensions and existing conditions on the job and shall report any discrepancies to the architect for resolution prior to commencing work.


SHEET TITLE

REMODEL FLOOR PLAN

(COMMON BUILDING)

SCALE: 1/4" = 1'=0"


SHEET#

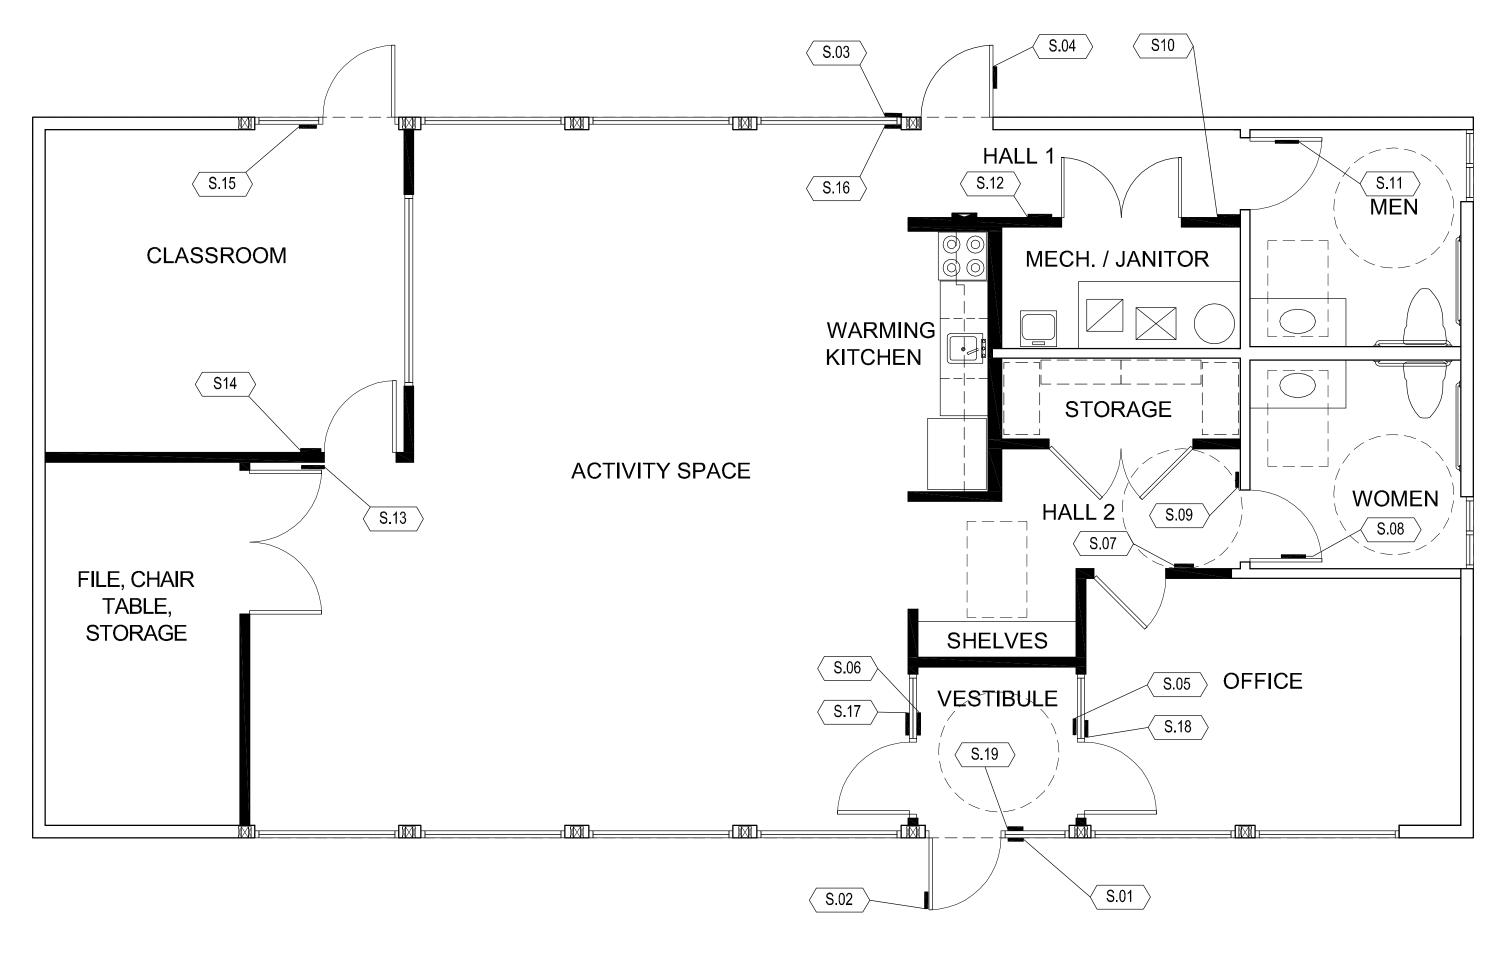

SIGNAGE PLAN SCALE: 1/4" = 1'-0"

SIGN SCHEDULE

SIGN	LOCATION (PUSH / PULL SIDE	OF DOOR)	COPY	NOTES
S.01	Glass right of door	Pull	MADONNA ROAD APARTMENTS RENTALOFFICE ACTIVITY CENTER 1550 Madonna Road	2"white vinyl lettering
S.02	Glass on entry/exit door	Pull	(international symbol of accessibility)	6 x 6" white on blue"
S.03	Glass right of door	Pull	ACTIVITY CENTER	2"white vinyl lettering
S.04	Glass on entry/exit door	Pull	(international symbol of accessibility)	6 x 6" white on blue"
S.05	Glass left of door	Push	OFFICE in case of emergency call 805 XXX-XXXX	6 x 9 white on grey, Braille for "OFFICE" only
S.06	Glass right of door	Push	ACTIVITY CENTER	6 x 9 white on grey, Braille
S.07	Wall left of door	Push	STAFF ONLY	6 x 9 white on grey, Braille
S.08	Surface of door	Push	(male symbol)	12" triangle, white on grey
S.09	Wall left of door	Push	MEN + (male symbol, ISA, Braille)	6 x 9 white on grey, Braille
S.10	Wall right of door	Push	WOMEN + (female symbol, ISA, Braille)	6 x 9 white on grey, Braille
S.11	Surface of door	Push	(female symbol)	12" circle, white on grey
S.12	Wall right of doors	Pull	MECHANICAL EQUIPMENT	6 x 9 white on grey, Braille
S.13	Wall left of door	Push	CLASSROOM	6 x 9 white on grey, Braille
S.14	Wall right of door	Push	TO EXIT	6 x 6 white on grey, Braille, CBC tactile exit sign
S.15	Glass left of door	Push	EXIT	6 x 6 white on grey, Braille, CBC tactile exit sign
S.16	Glass left of door	Push	EXIT	6 x 6 white on grey, Braille, CBC tactile exit sign, mount 60" A.F.F.
S.17	Wall left of door	Pull	TO EXIT	6 x 6 white on grey, Braille, CBC tactile exit sign
S.18	Wall right of door	Pull	TO EXIT	6 x 9 white on grey, Braille, CBC tactile exit sign
S.19	Glass left of door	Push	EXIT	6 x 9 white on grey, Braille, CBC tactile exit sign

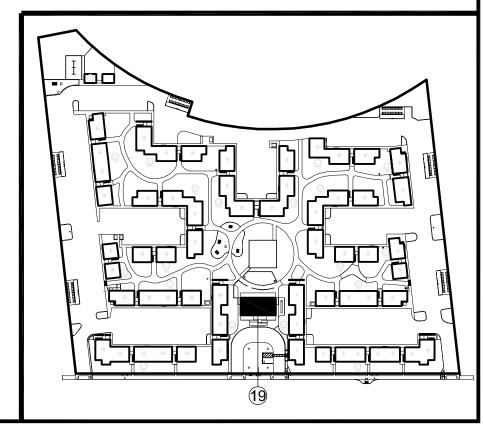

BUILDING KEY PLAN

PROJECT

MADONNA ROAD APARTMENTS

A RENOVATION AND UPGRADE PROJECT

1550 MADONNA ROAD SAN LUIS OBISPO, CA

CLIENT JOB#

1207



971 OSOS STREET SAN LUIS OBISPO CALIFORNIA 93401

805-544-6161

www.fraserseiplearchitects.com


PROJECT MANAGER BDF

DRAWN BY DDL

08-08-2012 1st SUBMITTAL

09-19-2012 1st RE-SUBMITTAL

10-05-2012 FOR CONSTRUCTION

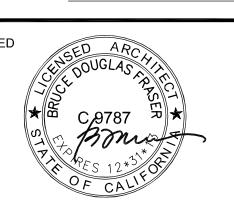

The use of these plans and specifications shall be restricted to the original site for which they were prepared and publication thereof is expressly limited to such use. Reproduction or publication by any method, in whole or in part, is prohibited. Title to these plans and specifications remain with the architect without prejudice. Visual contact with these plans and specifications shall constitute prima facie evidence of the acceptance of these restrictions.

Written dimensions on these drawings shall have precedence over scaled dimensions. Contractors shall verify and be responsible for all dimensions and existing conditions on the job and shall report any discrepancies to the architect for resolution prior to commencing work.

SHEET TITLE


SIGNAGE PLAN (COMMON BUILDING)

SCALE: 1/4" = 1'=0"

SHEET#

A2.2

onna Kd Apts 1207/Drawings/U - Drawing Sneets/AZ.Z -Signage Plan.dwg, 10/3/Z

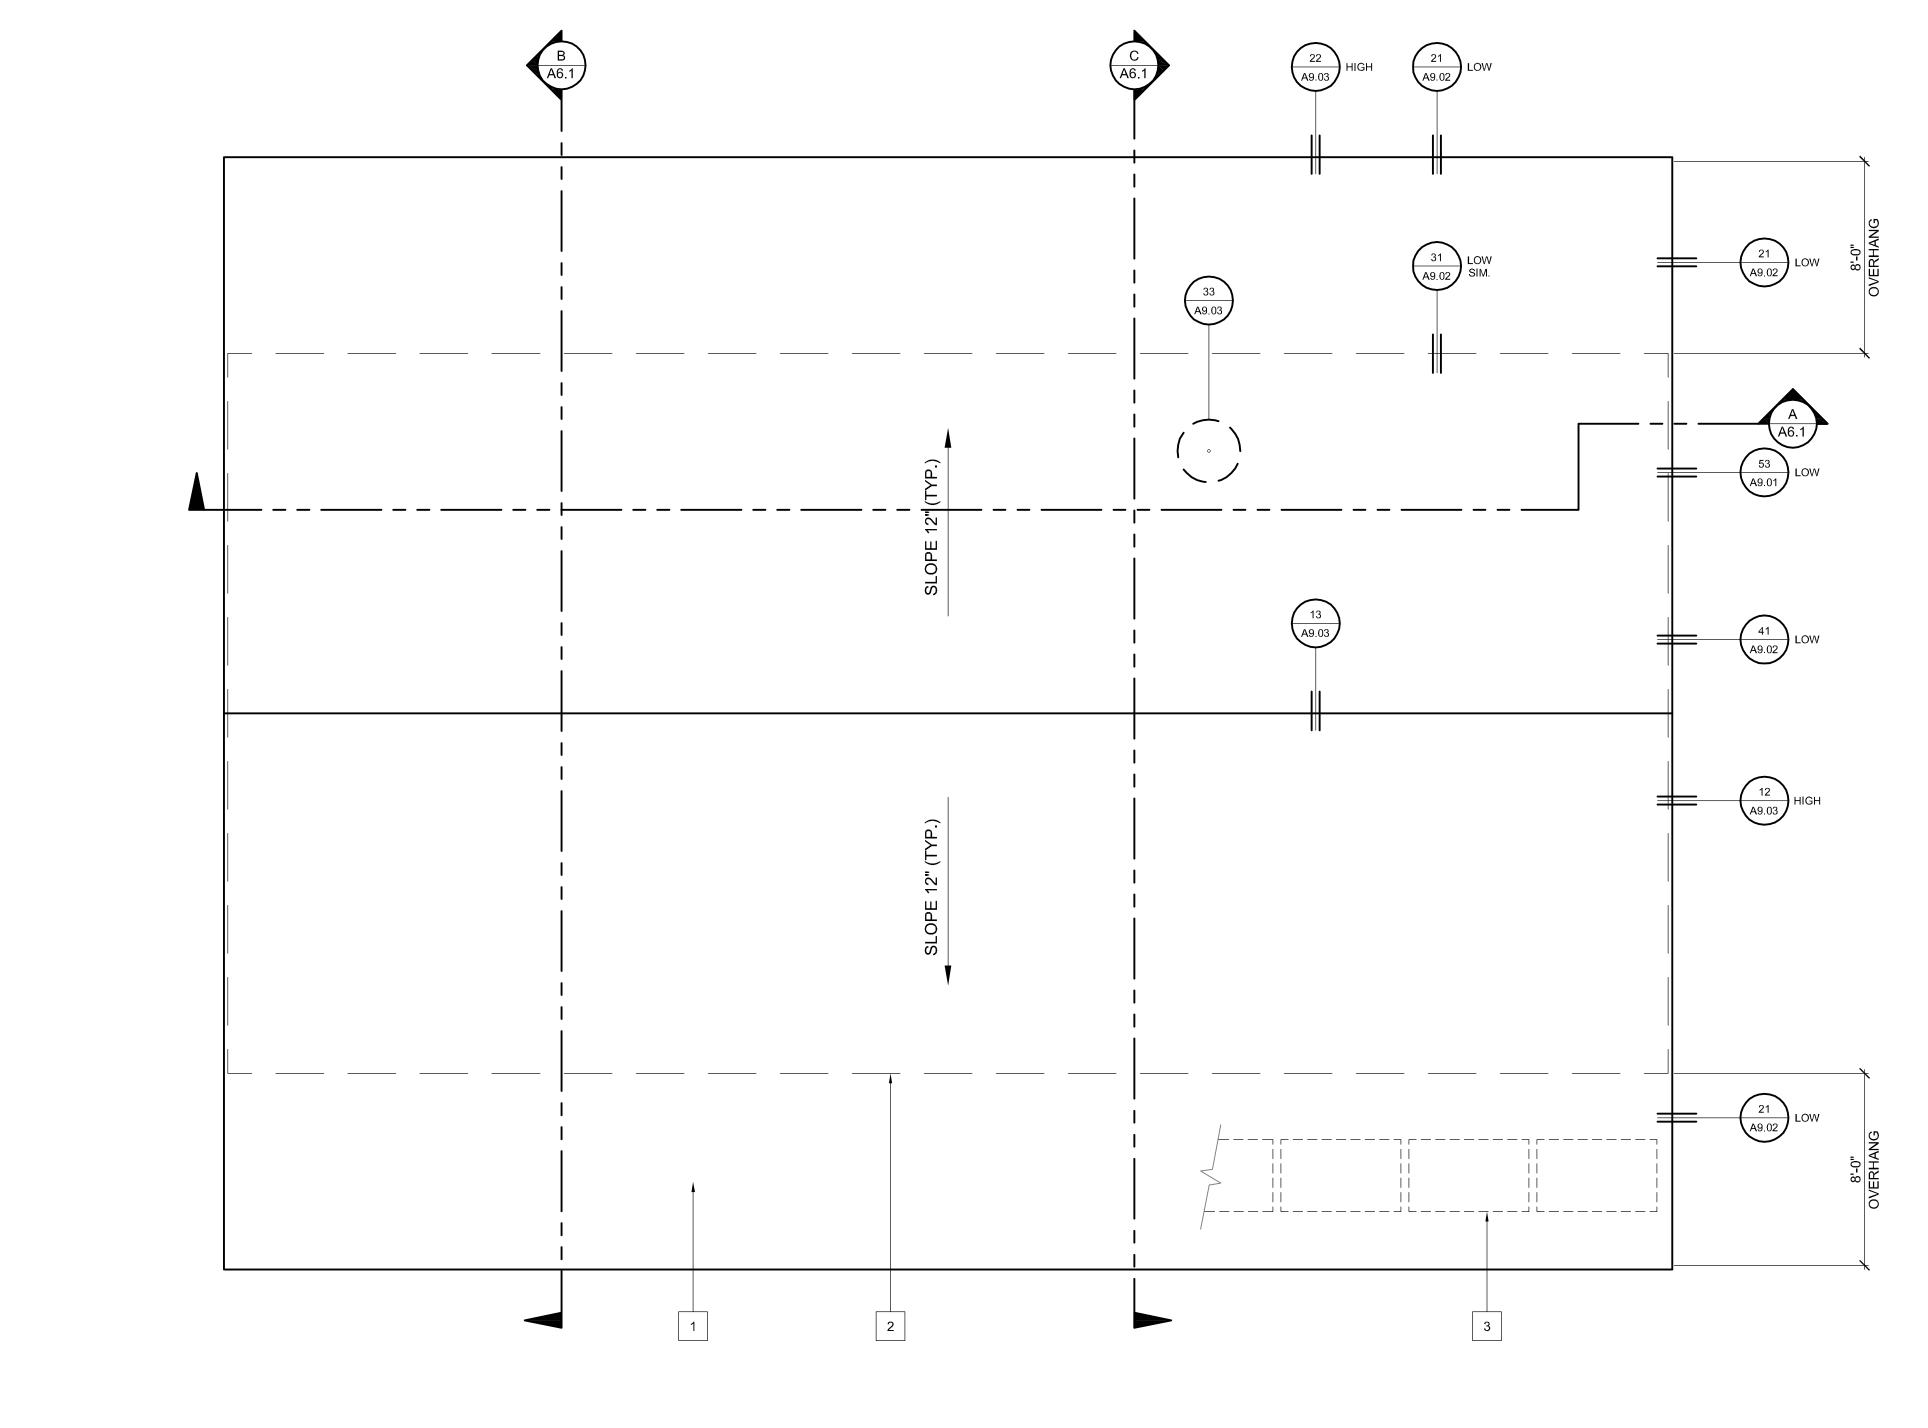


ROOF PLAN (COMMON BUILDING)

ROOF PLAN KEYNOTES

- 1. NEW SINGLE-PLY ROOF SYSTEM. SEE SHEET A9.03 FOR MANUFACTURER'S DETAILS. DEMOLISH (E) 4-PLY CAP SHEET ROOF SYSTEM DOWN TO PLYWOOD SHEATHING.
- 2. EXTERIOR WALL BELOW.
- 3. COORDINATE LOCATION OF ROOF WALKWAY PADS IN FIELD IN CONJUNCTION WITH PHOTOVOLTAIC SYSTEM INSTALLATION.

BUILDING KEY PLAN

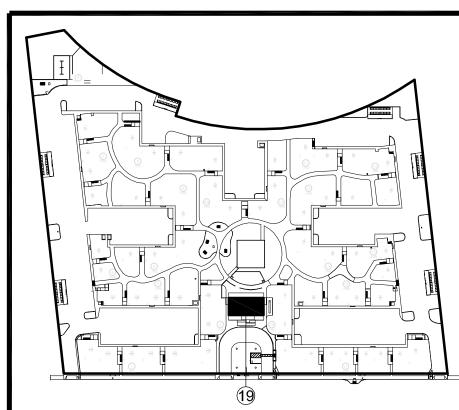

MADONNA ROAD APARTMENTS

A RENOVATION AND **UPGRADE PROJECT**

1550 MADONNA ROAD SAN LUIS OBISPO, CA

ARCHITECT JOB# 1207



971 OSOS STREET SAN LUIS OBISPO CALIFORNIA 93401

805-544-6161

www.fraserseiplearchitects.com

PROJECT MANAGER BDF

DRAWN BY DDL

08-08-2012 1st SUBMITTAL 09-19-2012 1st RE-SUBMITTAL 10-05-2012 FOR CONSTRUCTION

The use of these plans and specifications shall be restricted t the original site for which they were prepared and publication thereof is expressly limited to such use. Reproduction or publication by any method, in whole or in part, is prohibited. Title to these plans and specifications remain with the architect without prejudice. Visual contact with these plans and specifications shall constitute prima facie evidence of


Written dimensions on these drawings shall have precedence over scaled dimensions. Contractors shall verify and be responsible for all dimensions and existing conditions on the job and shall report any discrepancies to the architect for resolution prior to commencing work.


SHEET TITLE

ROOF PLAN (COMMON BUILDING)

the acceptance of these restrictions.

SCALE: 1/4" = 1'=0"

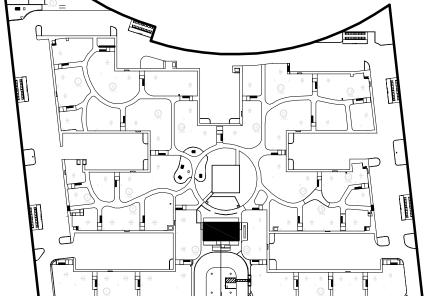

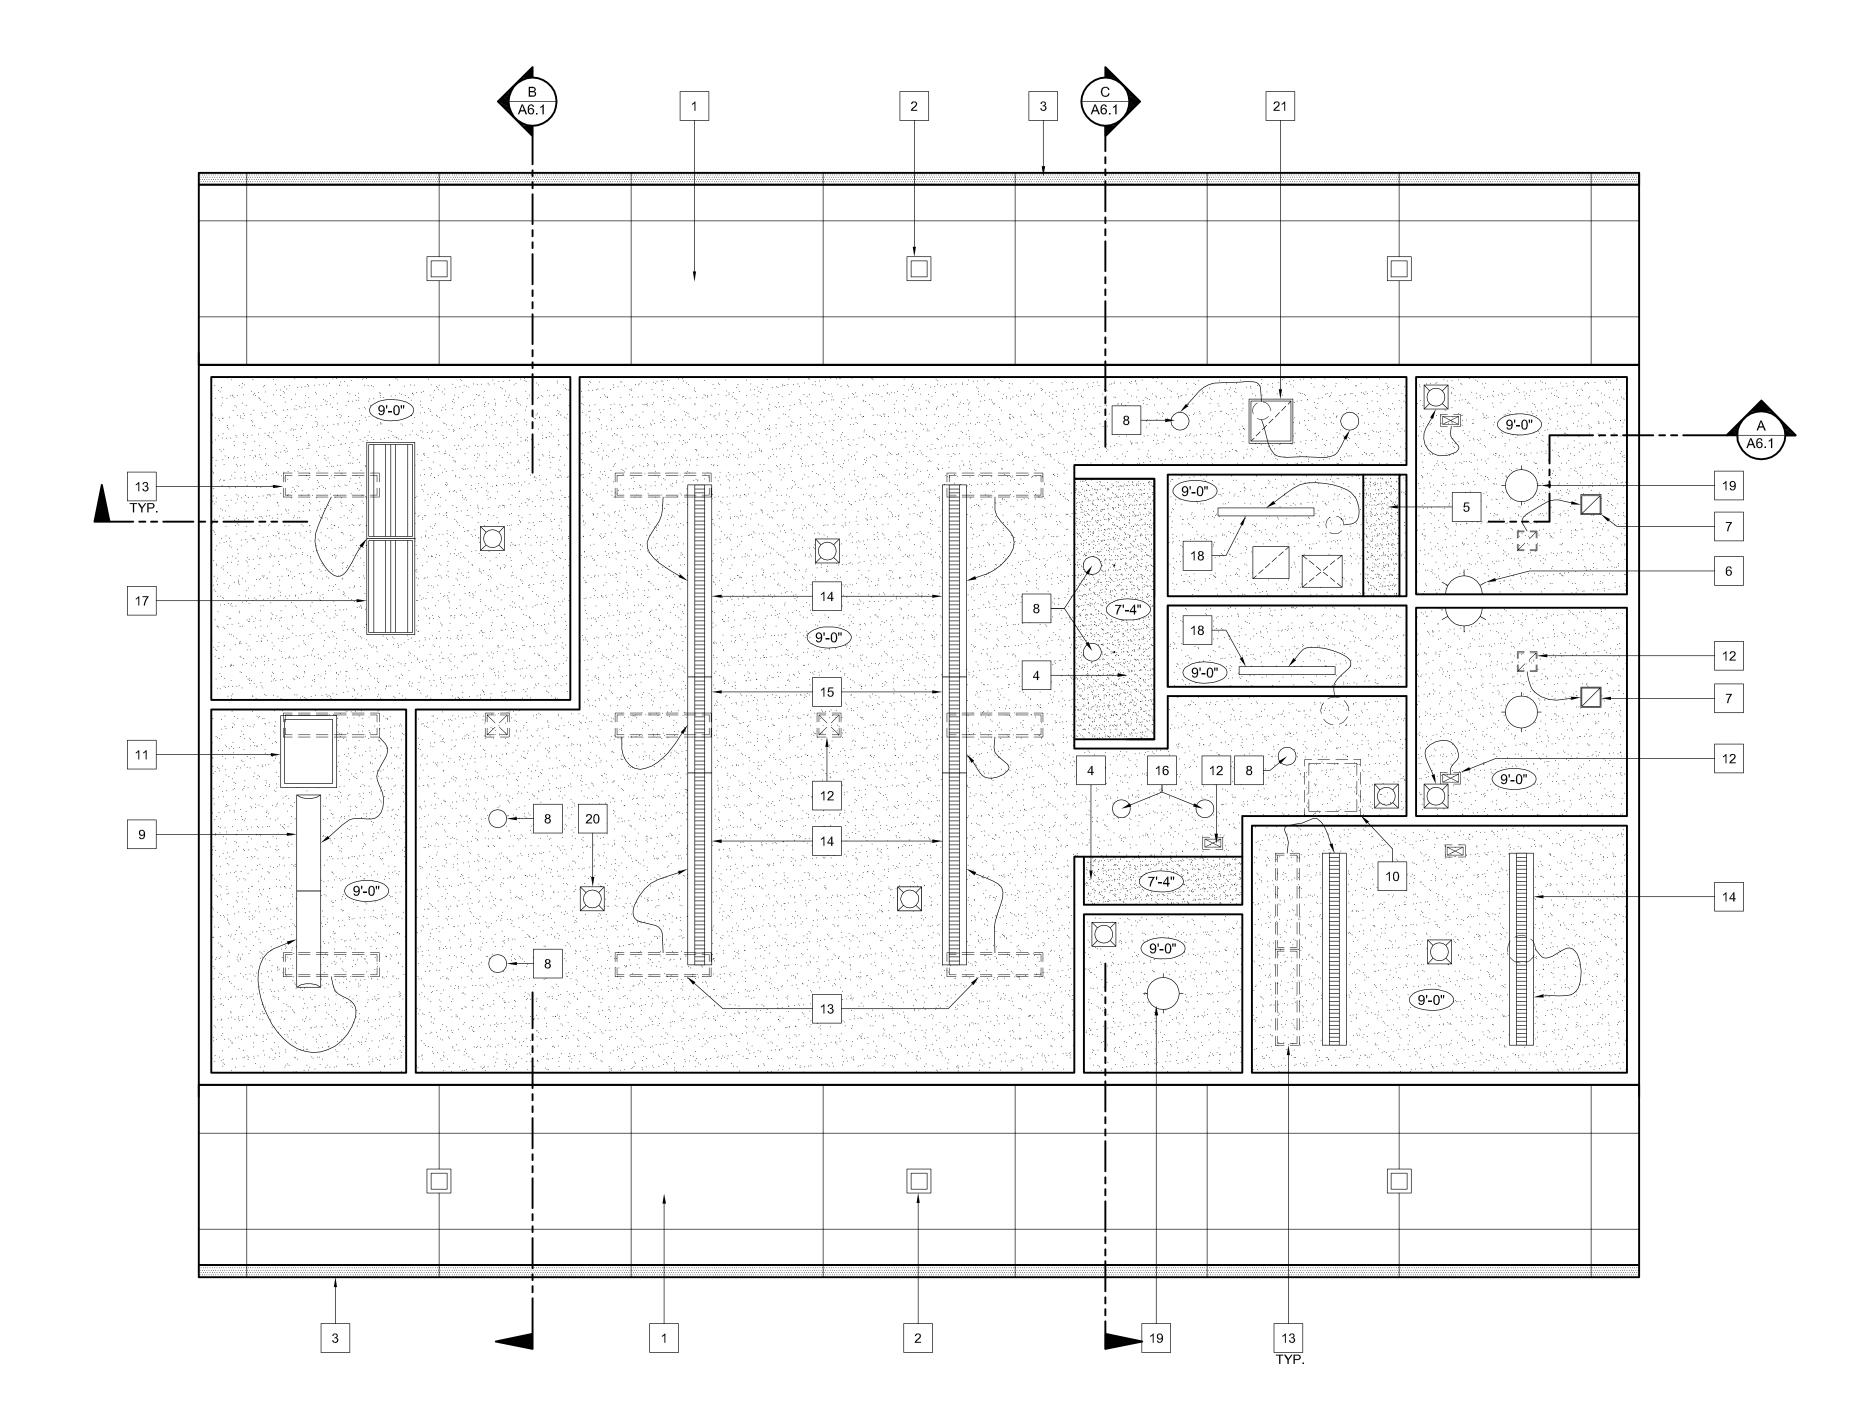


REFLECTED CEILING PLAN (COMMON BUILDING)

REFLECTED CEILING KEYNOTES:

- 1. NEW 48"x96" PANELIZED SOFFIT.
- 2. REPLACE EXISTING SOFFIT FIXTURES WITH NEW RECESSED VANDAL RESISTANT DOWNLIGHTS.
- 3. 24"x96" PERFORATED PANEL SOFFIT VENT.
- 4. NEW GYPSUM BOARD SOFFIT AT 7'-4".
- 5. EXISTING GYPSUM BOARD FLUE TO UNDERSIDE OF ROOF.
- 6. WALL MOUNT DIRECT / INDIRECT FLUORESCENT VANITY SCONCE WITH ACRYLIC 1/4 DOME.
- 7. NEW EXHAUST AIR GRILLE.
- 8. NEW 6" RECESSED FLUORESCENT DOWNLIGHT.
- 9. 1'x4' LINEAR SURFACE MOUNT FLUORESCENT WITH ACRYLIC DIFFUSER.
- FRAME IN EXISTING ATTIC ACCESS HATCH AND PATCH CEILING. SEE NOTE 11 FOR LOCATION OF NEW ATTIC ACCESS.
- 11. NEW 22"x30" ATTIC ACCESS HATCH.
- 12. REMOVE ALL EXISTING SUPPLY / EXHAUST GRILLS AND DUCTWORK. PATCH CEILING AS REQUIRED.
- 13. REMOVE EXISTING LIGHT FIXTURE AND PATCH
 CEILING. SEE ELECTRICAL LIGHTING PLAN FOR NEW
 FIXTURE SCHEDULE. ARROW INDICATES NEW FIXTURE
 IS RELOCATED FROM EXISTING JUNCTION BOX.
- 14. 1'x8' LINEAR SURFACE MOUNT DIRECT / INDIRECT FLUORESCENT FIXTURE.
- 15. 1'x4' LINEAR SURFACE MOUNT DIRECT / INDIRECT FLUORESCENT FIXTURE.
- 16. 6" RECESSED ADJUSTABLE FLUORESCENT DOWNLIGHT / SPOTLIGHT.
- 17. 2'x4' VOLUMETRIC SURFACE MOUNT INDIRECT FLUORESCENT.
- 18. 4"x48" SURFACE MOUNT CORRIDOR FLUORESCENT WITH ACRYLIC WRAPAROUND.
- 19. 18" DIAMETER SURFACE MOUNT FLUORESCENT
 DIRECT / INDIRECT WITH SPOT DOWNLIGHT AND
 ACRYLIC BOWL.
- 20. NEW SUPPLY AIR GRILLE.
- 21. NEW RETURN AIR GRILLE.

BUILDING KEY PLAN

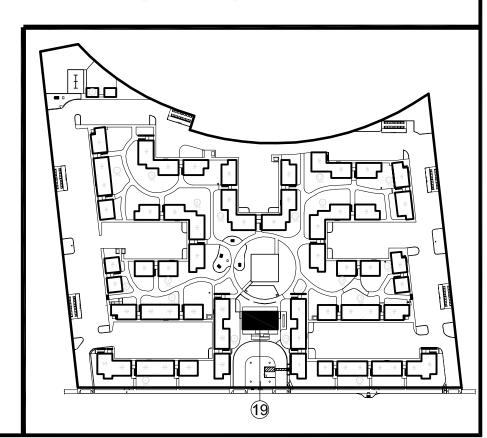

A RENOVATION AND UPGRADE PROJECT

1550 MADONNA ROAD SAN LUIS OBISPO, CA

MADONNA

ROAD

APARTMENTS

CLIENT JOB#

ARCHITECTS

PROJECT



971 OSOS STREET SAN LUIS OBISPO CALIFORNIA 93401

ARCHITECT JOB#

1207

805-544-6161

www.fraserseiplearchitects.com

PROJECT MANAGER BDF

DRAWN BY DDL

08-08-2012 1st

08-08-2012 1st SUBMITTAL

09-19-2012 1st RE-SUBMITTAL

10-05-2012 FOR CONSTRUCTION

C 9787

The use of these plans and specifications shall be restricted the original site for which they were prepared and publication thereof is expressly limited to such use. Reproduction or publication by any method, in whole or in part, is prohibited. Title to these plans and specifications remain with the architect without prejudice. Visual contact with these plans and specifications shall constitute prima facie evidence of

Written dimensions on these drawings shall have precedence over scaled dimensions. Contractors shall verify and be responsible for all dimensions and existing conditions on the job and shall report any discrepancies to the architect for resolution prior to commencing work.

SHEET TITLE

REFLECTED CEILING PLAN


e acceptance of these restrictions.

(COMMON BUILDING)

SCALE: 1/4" = 1'=0"

A4.1

NORTH

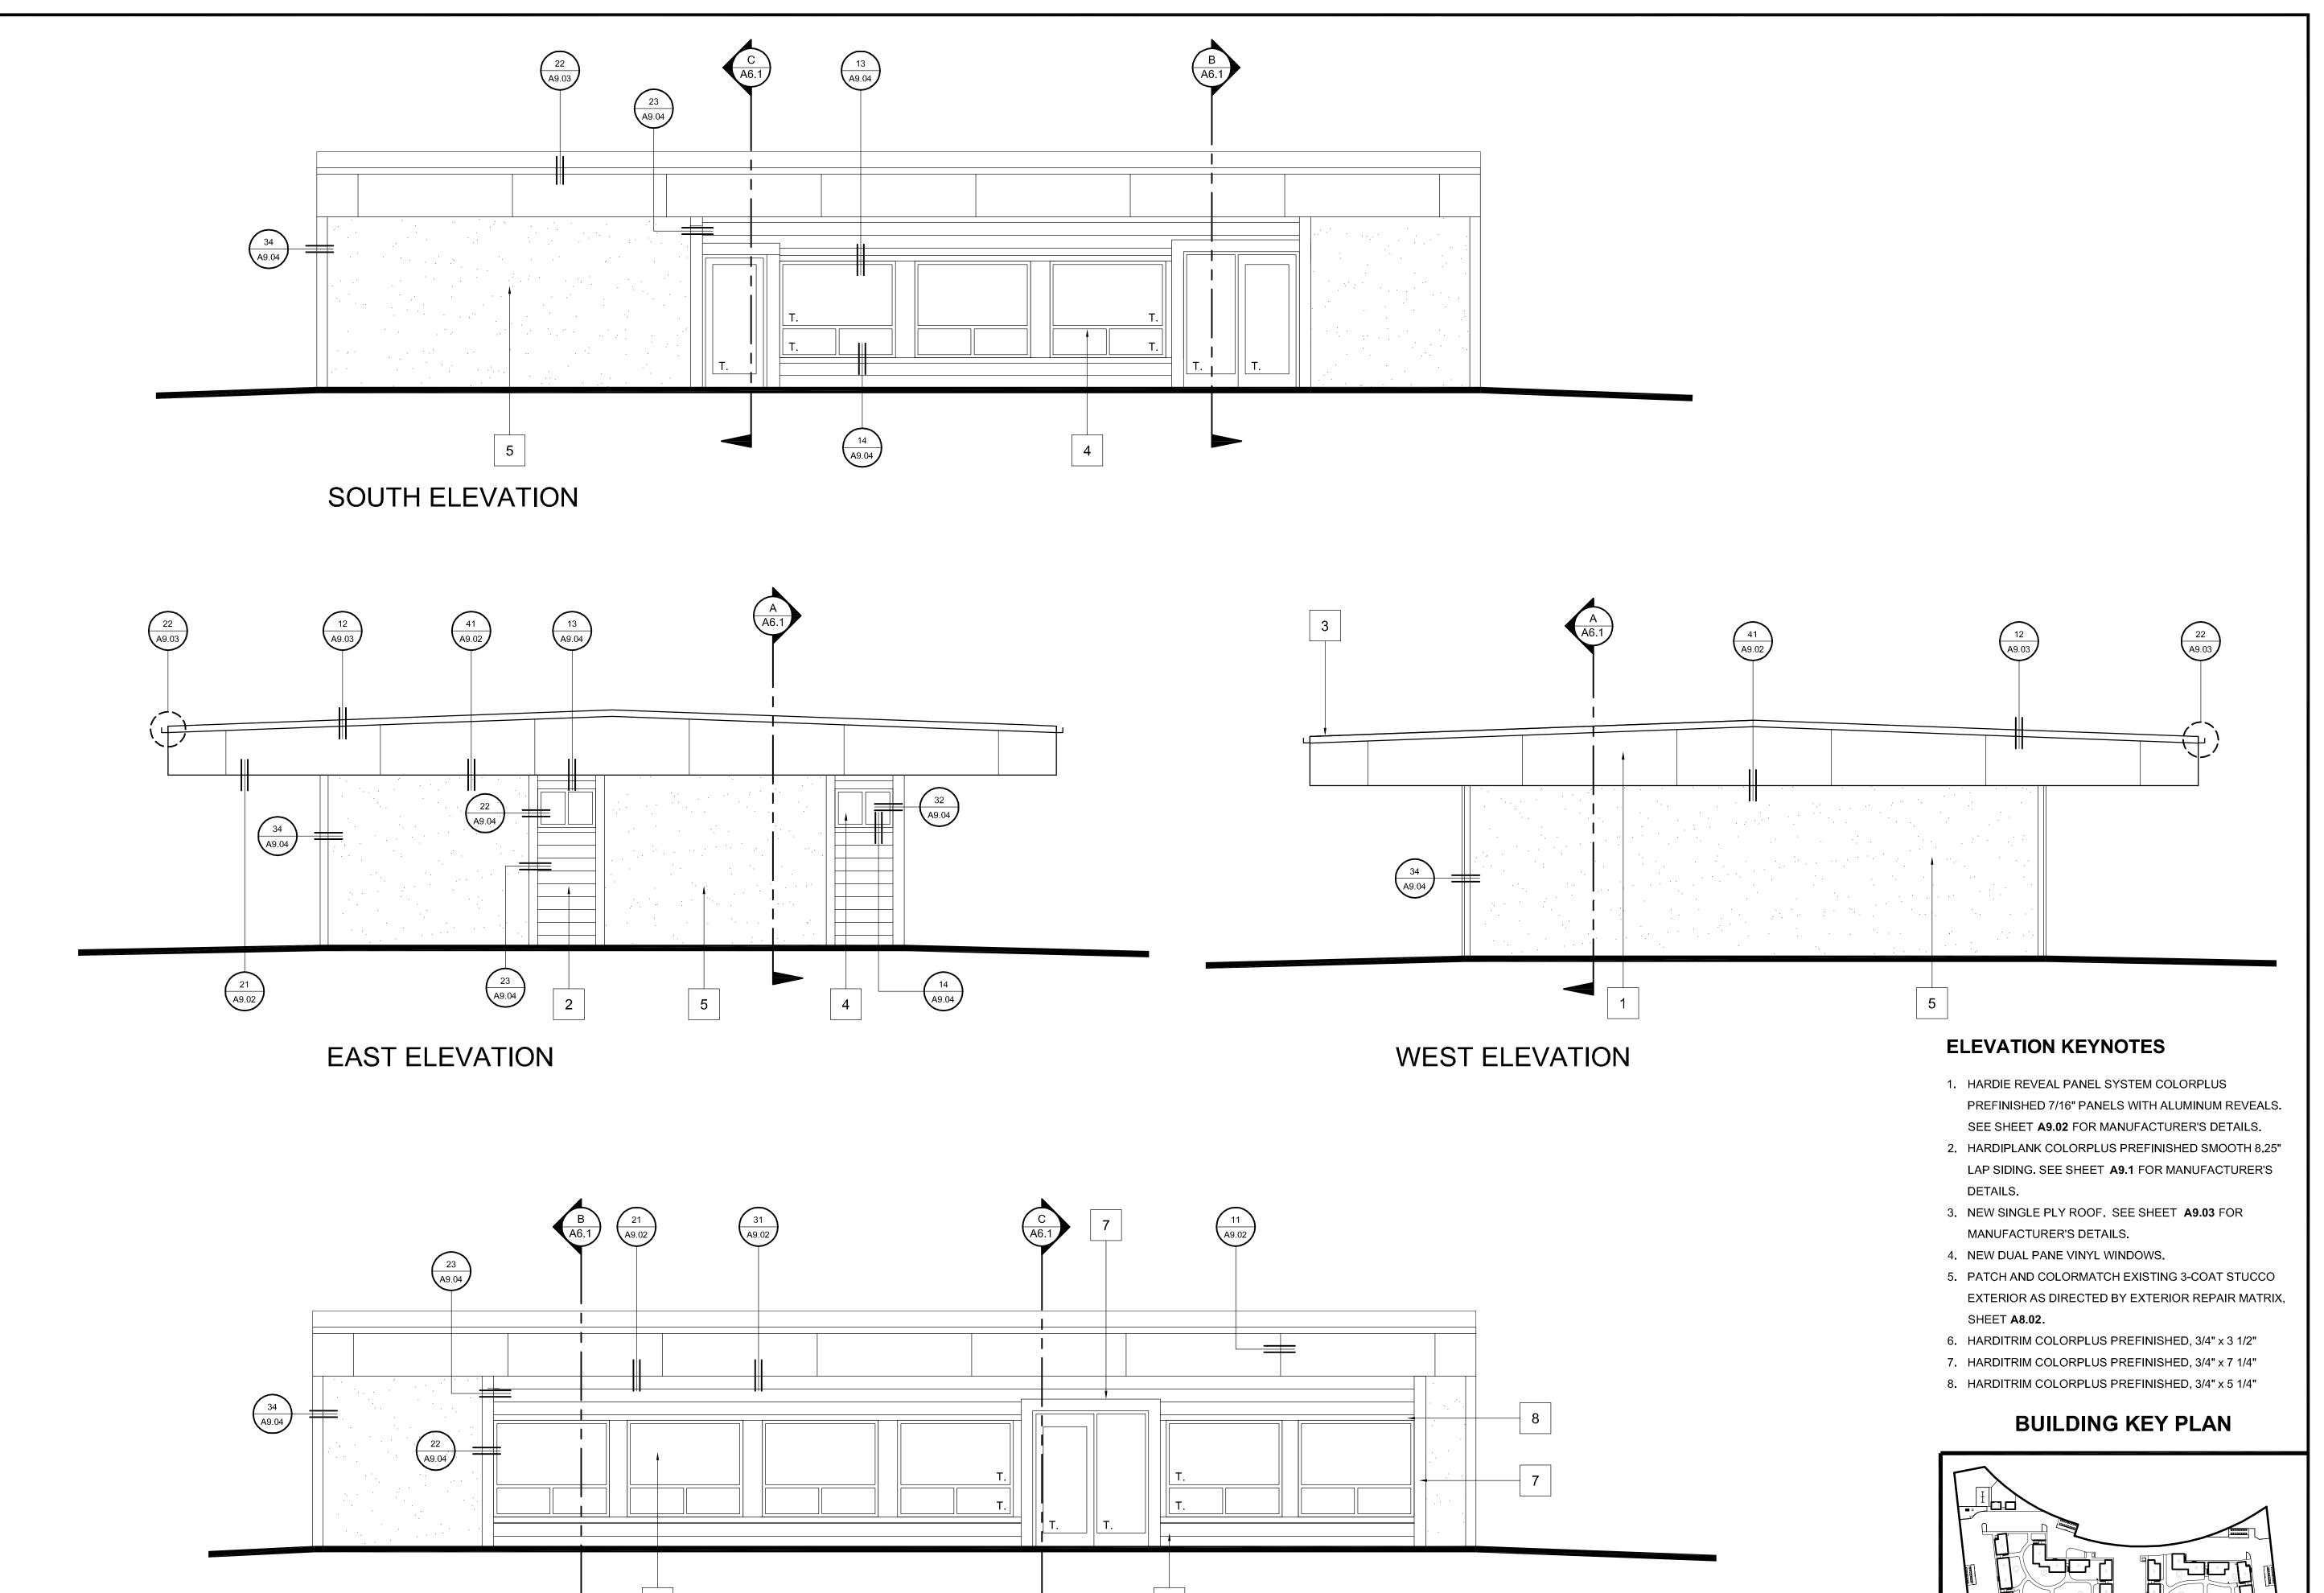

NORTH ELEVATION

PRO

MADONNA ROAD APARTMENTS

A RENOVATION AND UPGRADE PROJECT

1550 MADONNA ROAD SAN LUIS OBISPO, CA

CLIENT JOB

ARCHITECT JOB# 1207



971 OSOS STREET SAN LUIS OBISPO CALIFORNIA 93401


805-544-6161

www.fraserseiplearchitects.com

PROJECT MANAGER BDF

DRAWN BY DDL

08-08-2012 1st SUBMITTAL
09-19-2012 1st RE-SUBMITTAL
10-05-2012 FOR CONSTRUCTION

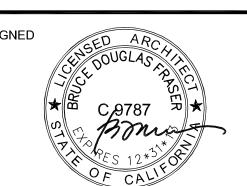

The use of these plans and specifications shall be restricted to the original site for which they were prepared and publication thereof is expressly limited to such use. Reproduction or publication by any method, in whole or in part, is prohibited. Title to these plans and specifications remain with the architect without prejudice. Visual contact with these plans and specifications shall constitute prima facie evidence of

Written dimensions on these drawings shall have precedence over scaled dimensions. Contractors shall verify and be responsible for all dimensions and existing conditions on the job and shall report any discrepancies to the architect for resolution prior to commencing work.

SHEET TITLE


EXTERIOR ELEVATIONS

ne acceptance of these restrictions.

(COMMON BUILDING)


SCALE: 1/4" = 1'=0"

A5.1

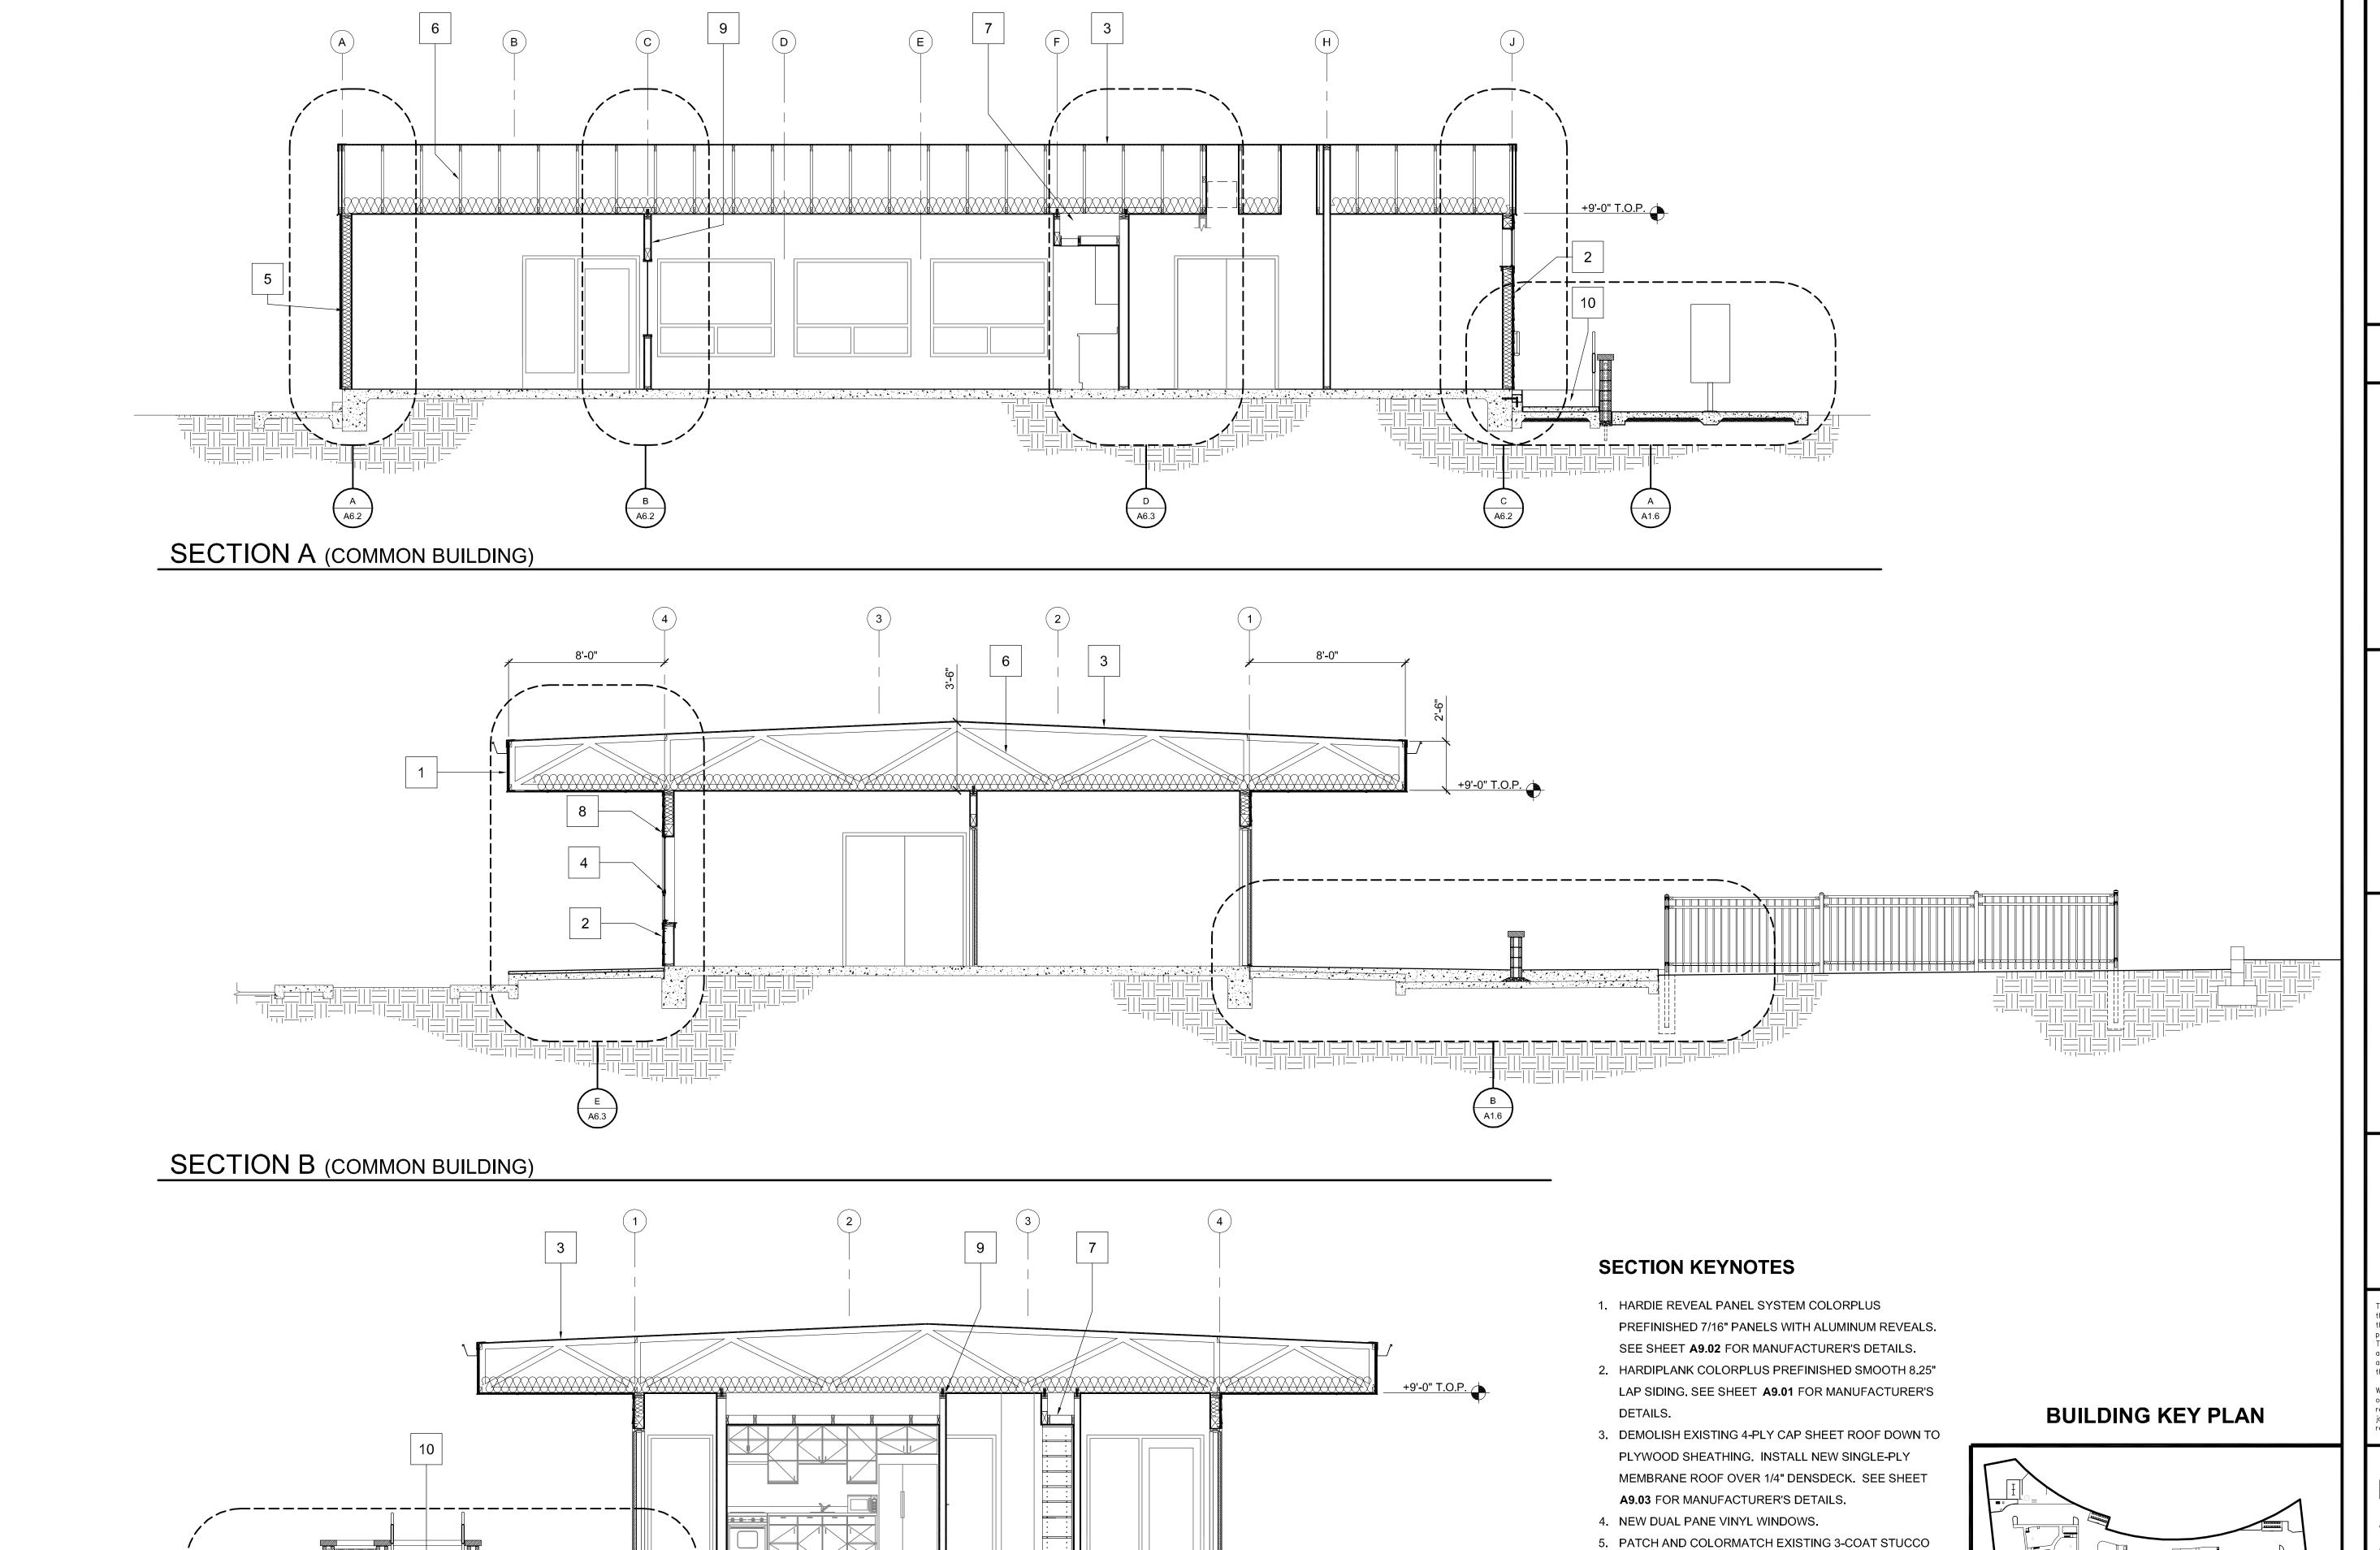

SECTION C (COMMON BUILDING)

- 5. PATCH AND COLORMATCH EXISTING 3-COAT STUCCO EXTERIOR AS DIRECTED BY EXTERIOR REPAIR MATRIX, SHEET **A8.02**.
- 6. EXISTING ROOF TRUSSES.
- 7. NEW SOFFIT FRAMING.
- 8. HARDITRIM COLORPLUS PREFINISHED, $3/4" \times 5 1/4"$
- 9. NEW NON-BEARING PARTITION WALL
- 10. NEW ACCESS RAMP

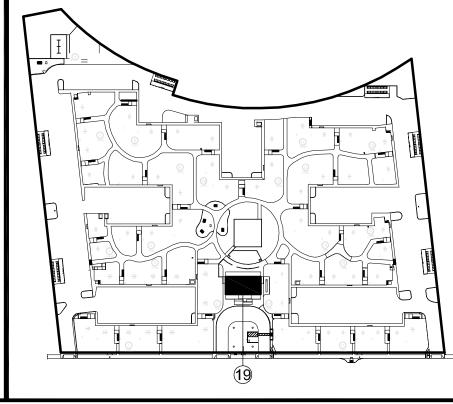

PRO

MADONNA ROAD APARTMENTS

A RENOVATION AND UPGRADE PROJECT

1550 MADONNA ROAD SAN LUIS OBISPO, CA

CLIENT JOB#

ARCHITECT JOB # **1207**



971 OSOS STREET SAN LUIS OBISPO CALIFORNIA 93401

805-544-6161

www.fraserseiplearchitects.com

PROJECT MANAGER BDF

DRAWN BY DDL

08-08-2012 1st SUBMITTAL
09-19-2012 1st RE-SUBMITTAL
10-05-2012 FOR CONSTRUCTION

D ARCH DOUGLAS A LA



The use of these plans and specifications shall be restricted to the original site for which they were prepared and publication thereof is expressly limited to such use. Reproduction or publication by any method, in whole or in part, is prohibited. Title to these plans and specifications remain with the architect without prejudice. Visual contact with these plans and specifications shall constitute prima facie evidence of the acceptance of these restrictions.

over scaled dimensions. Contractors shall verify and be responsible for all dimensions and existing conditions on the job and shall report any discrepancies to the architect for resolution prior to commencing work.

SHEET TITLE


BUILDING SECTIONS

(COMMON BUILDING)

SCALE: 1/4" = 1'=0"

SHEET#


A6.1

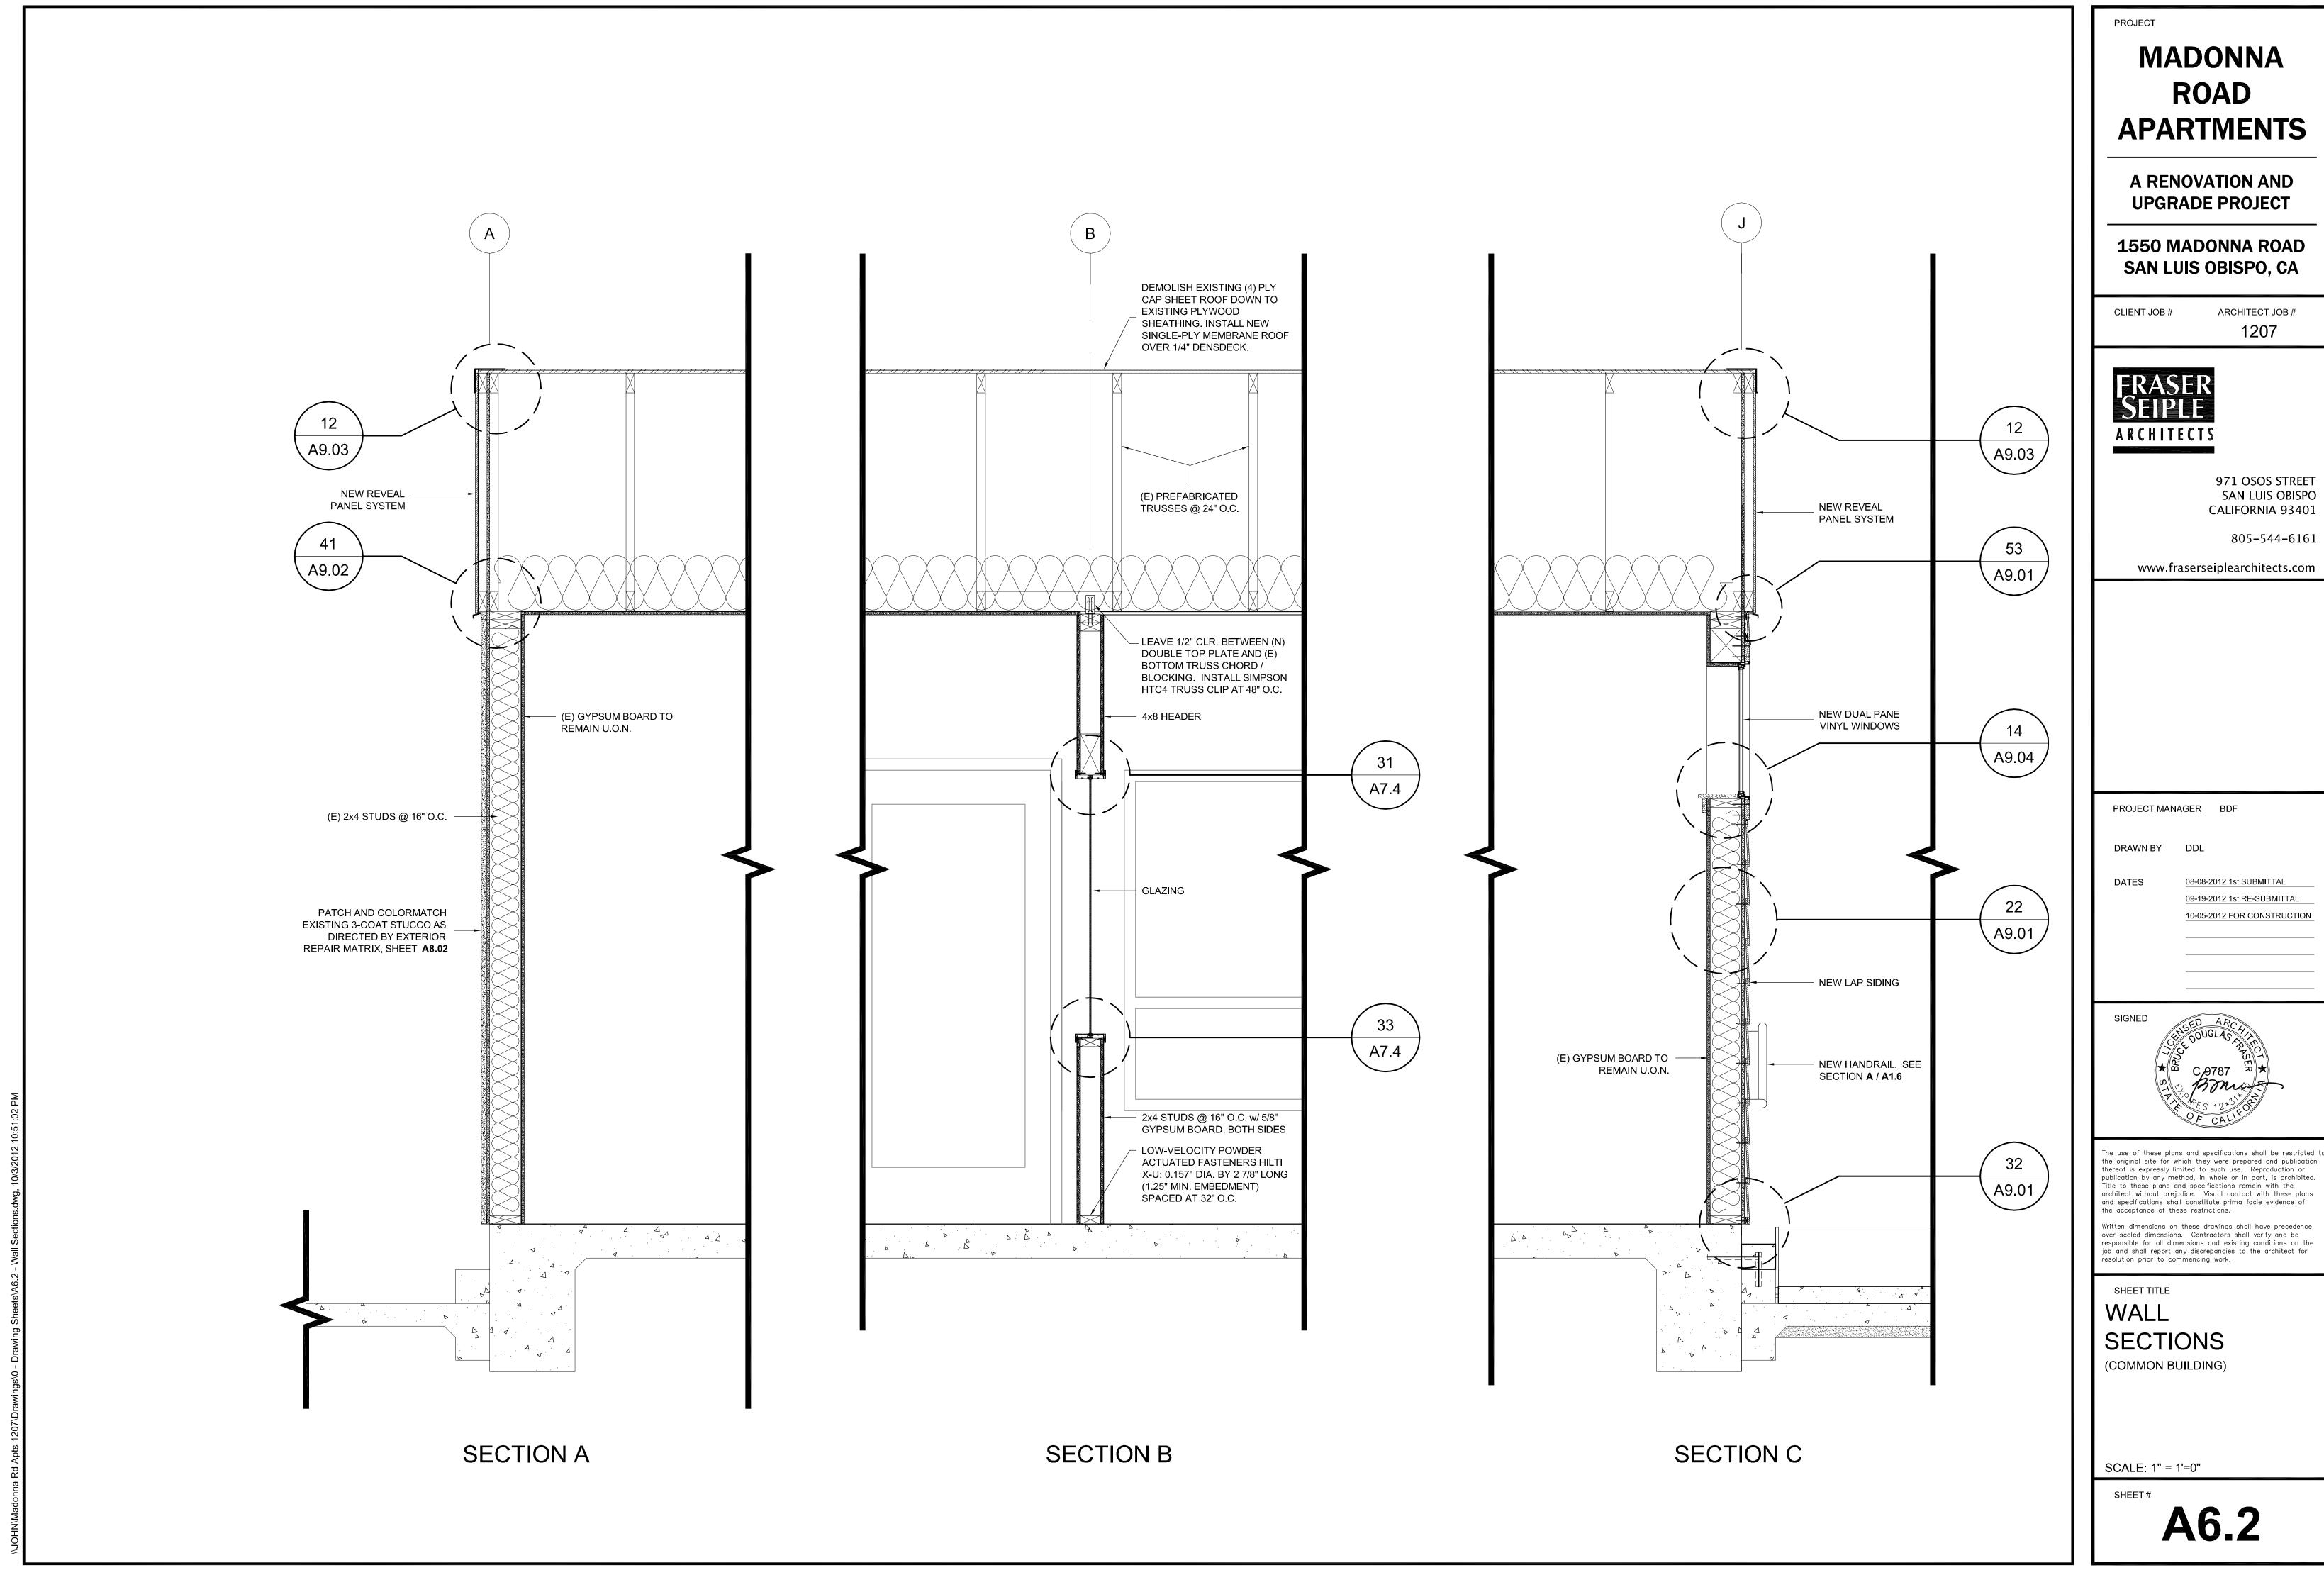

971 OSOS STREET SAN LUIS OBISPO CALIFORNIA 93401

08-08-2012 1st SUBMITTAL 09-19-2012 1st RE-SUBMITTAL



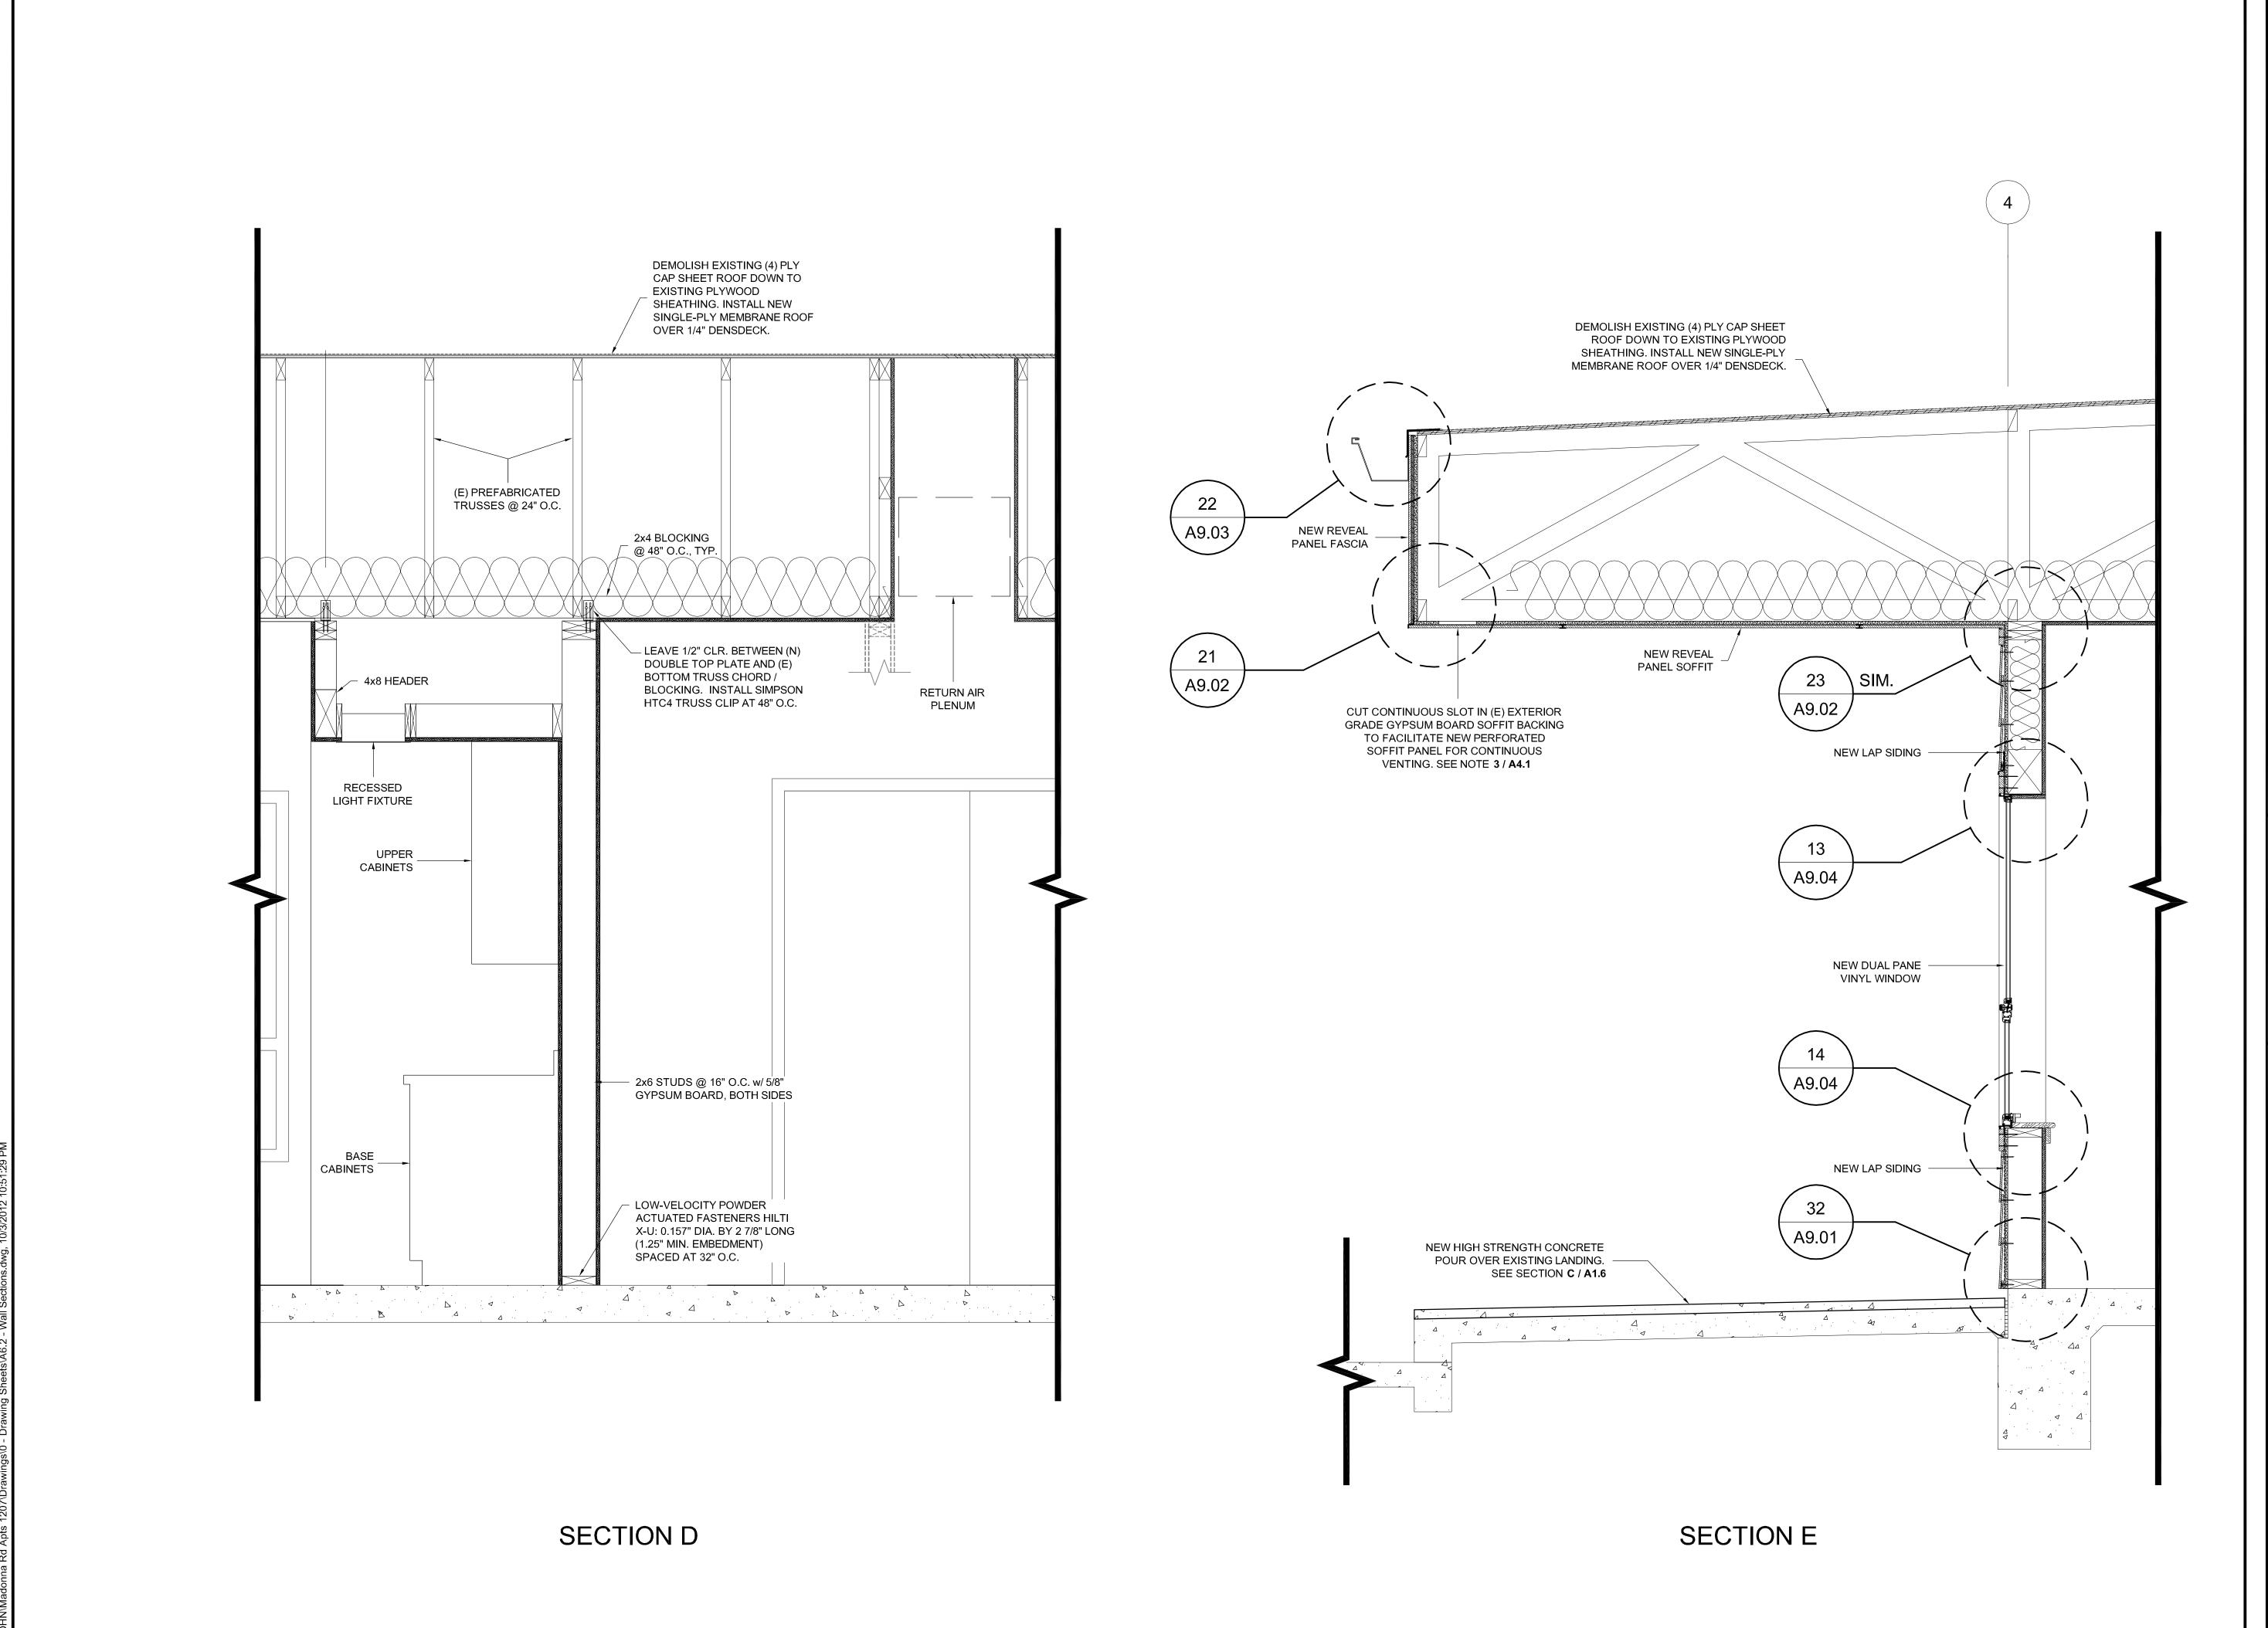

MADONNA ROAD APARTMENTS

A RENOVATION AND UPGRADE PROJECT

1550 MADONNA ROAD SAN LUIS OBISPO, CA

CLIENT JOB#

1207

ARCHITECT JOB#



971 OSOS STREET SAN LUIS OBISPO CALIFORNIA 93401

805-544-6161

www.fraserseiplearchitects.com

PROJECT MANAGER BDF

DRAWN BY DDL

08-08-2012 1st SUBMITTAL

09-19-2012 1st RE-SUBMITTAL

10-05-2012 FOR CONSTRUCTION

C 9787 ARCHIA

The use of these plans and specifications shall be restricted to the original site for which they were prepared and publication thereof is expressly limited to such use. Reproduction or publication by any method, in whole or in part, is prohibited. Title to these plans and specifications remain with the architect without prejudice. Visual contact with these plans and specifications shall constitute prima facie evidence of the acceptance of these restrictions.

Written dimensions on these drawings shall have precedence over scaled dimensions. Contractors shall verify and be responsible for all dimensions and existing conditions on the job and shall report any discrepancies to the architect for resolution prior to commencing work.

SHEET TITLE


WALL SECTIONS


(COMMON BUILDING)

SCALE: 1" = 1'=0"

SHEET#

A6.3

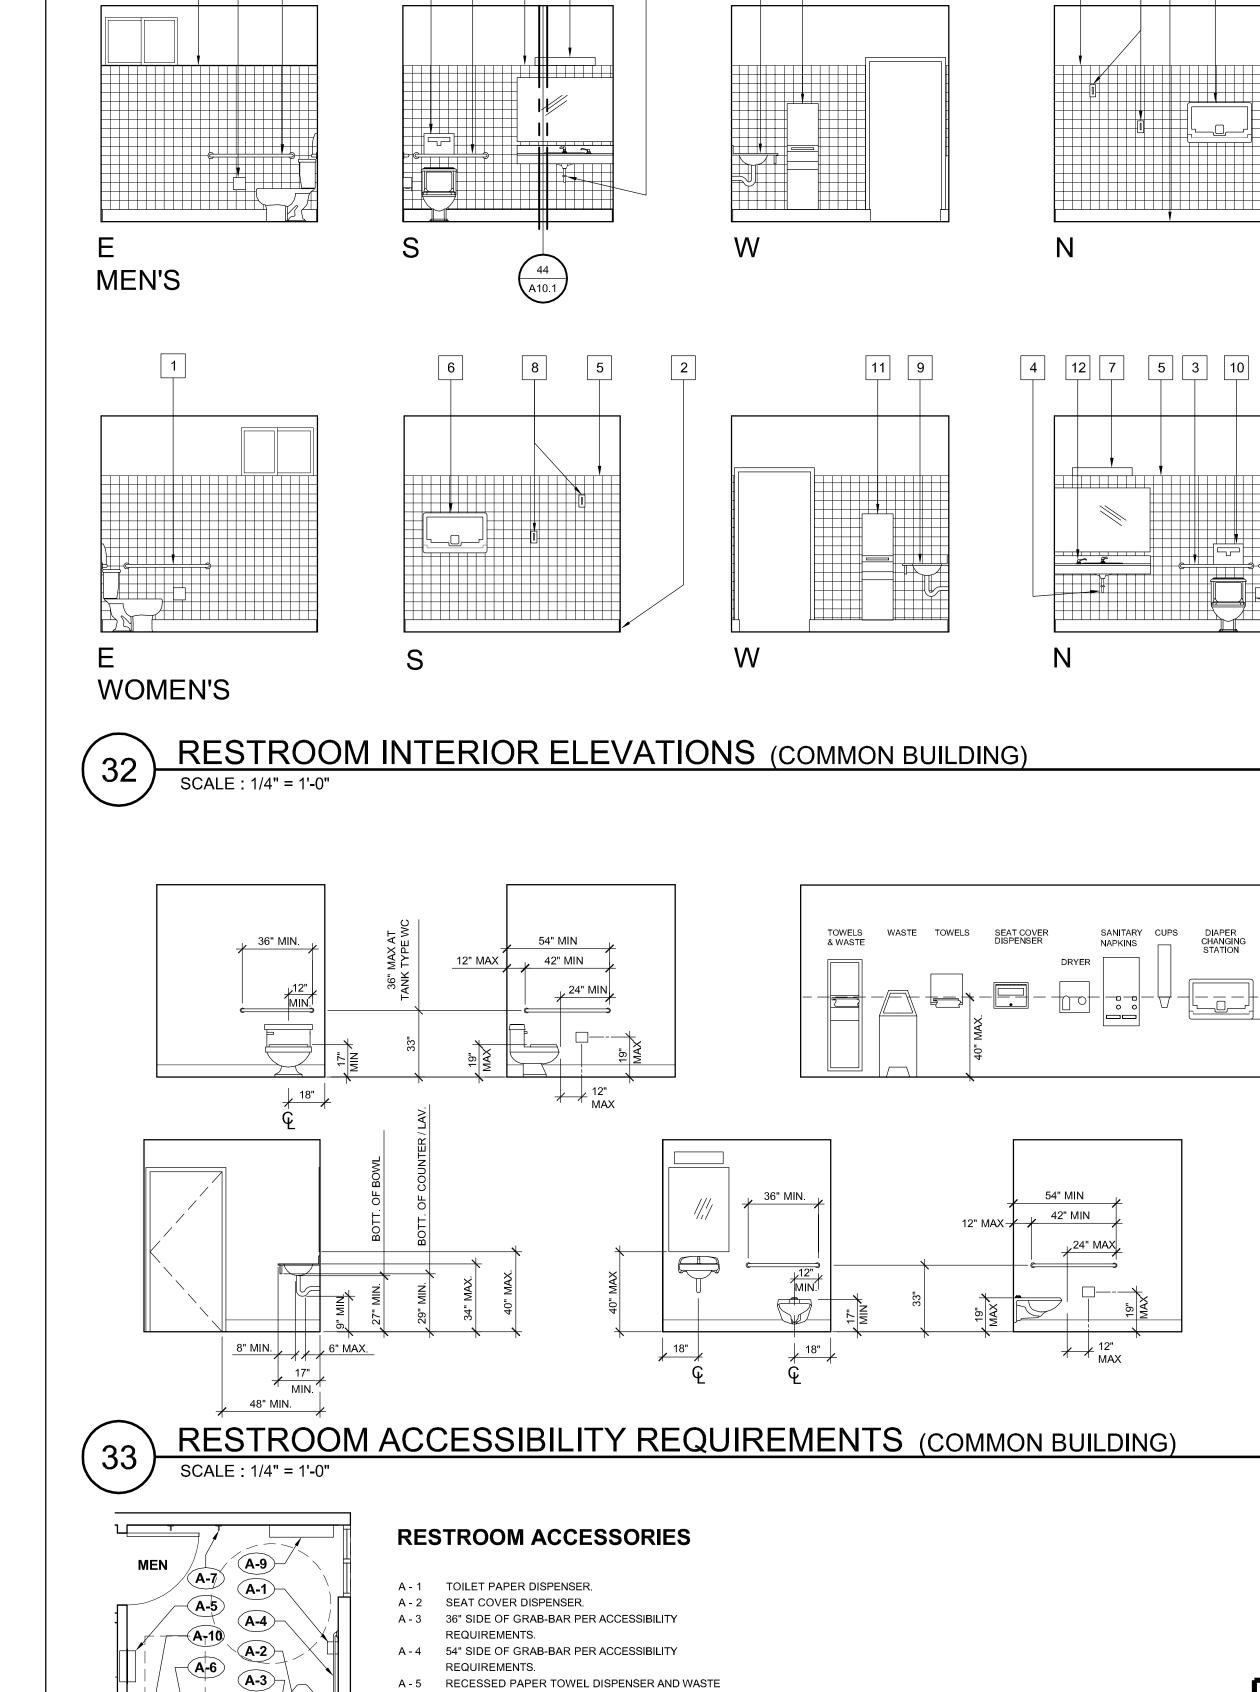

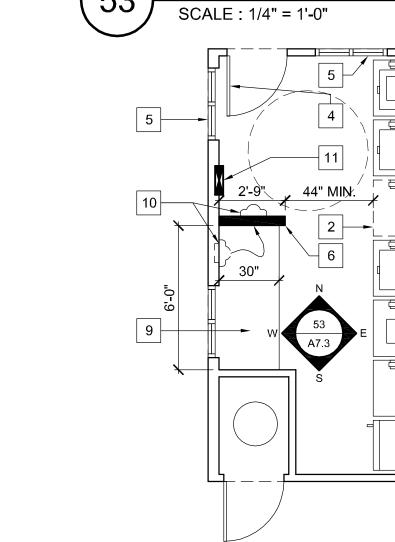

LAUNDRY ROOM KEYNOTES

- CLOTHES WASHER.
- 2. REPLACE (1) EXISTING WASHER WITH AN ACCESSIBLE FRONT

00000

- LOAD WASHER.
- FRONT LOAD CLOTHES DRYER. 4. NEW DOOR WITH LEVER ACTION HARDWARE. SEE NOTES ON
- SHEET A8.1
- 5. EXISTING OPERABLE WINDOW; TEMPERED GLAZING REQUIRED
- WHEN WINDOW IS ADJACENT TO DOOR.
- 6. 48" HIGH 2x6 HALF-WALL WITH HARDWOOD CAP. 7. EXISTING 2nd LAYER OF HARDENED GYPSUM BOARD UP TO 48"
- A.F.F. ALL AROUND.
- 8. ACCESSIBLE SPACE BENEATH SINK
- 10. RELOCATE EXISTING TYPE 2-A10-B:C RECESSED FIRE EXTINGUISHER CABINET TO NEW HALF-WALL. MOUNT

- RECEPTACLE. SANITARY NAPKIN DISPOSAL
- CONTAINER. A - 6 COUNTER MOUNTED SOAP DISPENSER.
- A 7 (2) COAT HOOKS. ONE ACCESSIBLE HOOK MOUNTED
- AT 46" A F F A - 8 NOT USED.
- A 9 WALL MOUNTED CHANGING TABLE.

A - 10 4' W x 2'-8" H MIRROR WITH BOTTOM EDGE MOUNTED AT 40" A F F

8 2 6

BUILDING KEY PLAN

SHEET#

RESTROOM FLOOR PLANS (COMMON BUILDING)

THE FORCE REQUIRED TO ACTIVATE CONTROLS FOR ALL ITEMS SHALL BE 5 LBF. MAX. 5. LOCATE COAT HOOKS AND SHELVING WITHIN APPROPRIATE REACH RANGES 48" MAX. ABOVE 6. IF MEDICINE CABINETS ARE PROVIDED, AT LEAST ONE SHALL HAVE A USABLE SHELF NO HIGHER THAN 44" ABOVE FLOOR. SIGNED

08-08-2012 1st SUBMITTAL

09-19-2012 1st RE-SUBMITTAL

10-05-2012 FOR CONSTRUCTION

PROJECT MANAGER BDF

DRAWN BY DDL

The use of these plans and specifications shall be restricted the original site for which they were prepared and publication thereof is expressly limited to such use. Reproduction or publication by any method, in whole or in part, is prohibited. Title to these plans and specifications remain with the architect without prejudice. Visual contact with these plans and specifications shall constitute prima facie evidence of e acceptance of these restrictions.

over scaled dimensions. Contractors shall verify and be responsible for all dimensions and existing conditions on the job and shall report any discrepancies to the architect for resolution prior to commencing work.

PROJECT

CLIENT JOB#

ARCHITECTS

INTERIOR ELEVATION

1. 42" MIN GRAB BAR PER ACCESSIBILITY

3. 36" MIN GRAB BAR PER ACCESSIBILITY

6. WALL MOUNTED CHANGING TABLE. WALL MOUNT LIGHT FIXTURE.

6" COVED TILE WALL BASE.

A.F.F., FIELD VERIFY.

46" AFF

CORIAN COUNTER TOP.

SEAT COVER DISPENSER.

WASTE RECEPTACLE.

13. TOILET PAPER DISPENSER.

ACCESSIBILITY NOTES

HIGHER THAN 40" ABOVE FLOOR.

WASTE RECEPTACLES.

MOUNT MIRROR(S) WITH THE BOTTOM EDGE NO

LOCATE OPERABLE PARTS (INCLUDING COIN SLOTS) OF ALL FIXTURES OR ACCESSORIES A

DISPENSERS, TOWELS, TOILET SEAT COVERS, AUTO DRYERS, SANITARY NAPKIN DISPENSERS,

CONTROLS AND OPERATING MECHANISMS FOR ALL ITEMS SHALL BE OPERABLE WITH ONE

HAND AND NOT REQUIRE TIGHT GRASPING

PINCHING, OR TWISTING OF THE WRIST.

MAXIMUM OF 40" ABOVE FLOOR: SOAP

REQUIREMENTS.

REQUIREMENTS. SEE DETAIL 42 / A10.1.

4. INSULATE DRAIN PIPES AND HOT WATER LINES.

5. EDGE OF TILE AT BOTTOM OF WINDOW, ±6'-6"

8. COAT HOOK. PROVIDE ACCESSIBLE HOOK AT

11. RECESSED PAPER TOWEL DISPENSER AND

12. COUNTER MOUNTED SOAP DISPENSER.

KEYNOTES

MADONNA

ROAD

APARTMENTS

A RENOVATION AND

UPGRADE PROJECT

1550 MADONNA ROAD

SAN LUIS OBISPO, CA

ARCHITECT JOB#

1207

971 OSOS STREET

CALIFORNIA 93401

www.fraserseiplearchitects.com

SAN LUIS OBISPO

805-544-6161

INTERIOR ELEVATIONS

(PUBLIC RESTROOM AND LAUNDRY)

SCALE: 1/4" = 1'=0"


SCALE: 1/4" = 1'-0"

LAUNDRY ROOM 1 ELEVATIONS (ACCESSIBILITY UPGRADES) 53

PLASTIC LAMINATE COUNTERTOP.

EXTINGUISHER HANDLE @ +48" A.F.F. MAX. 11. EXISTING ELECTRICAL PANEL TO REMAIN.

LAUNDRY ROOM 1 FLOOR PLAN (ACCESSIBILITY UPGRADES)

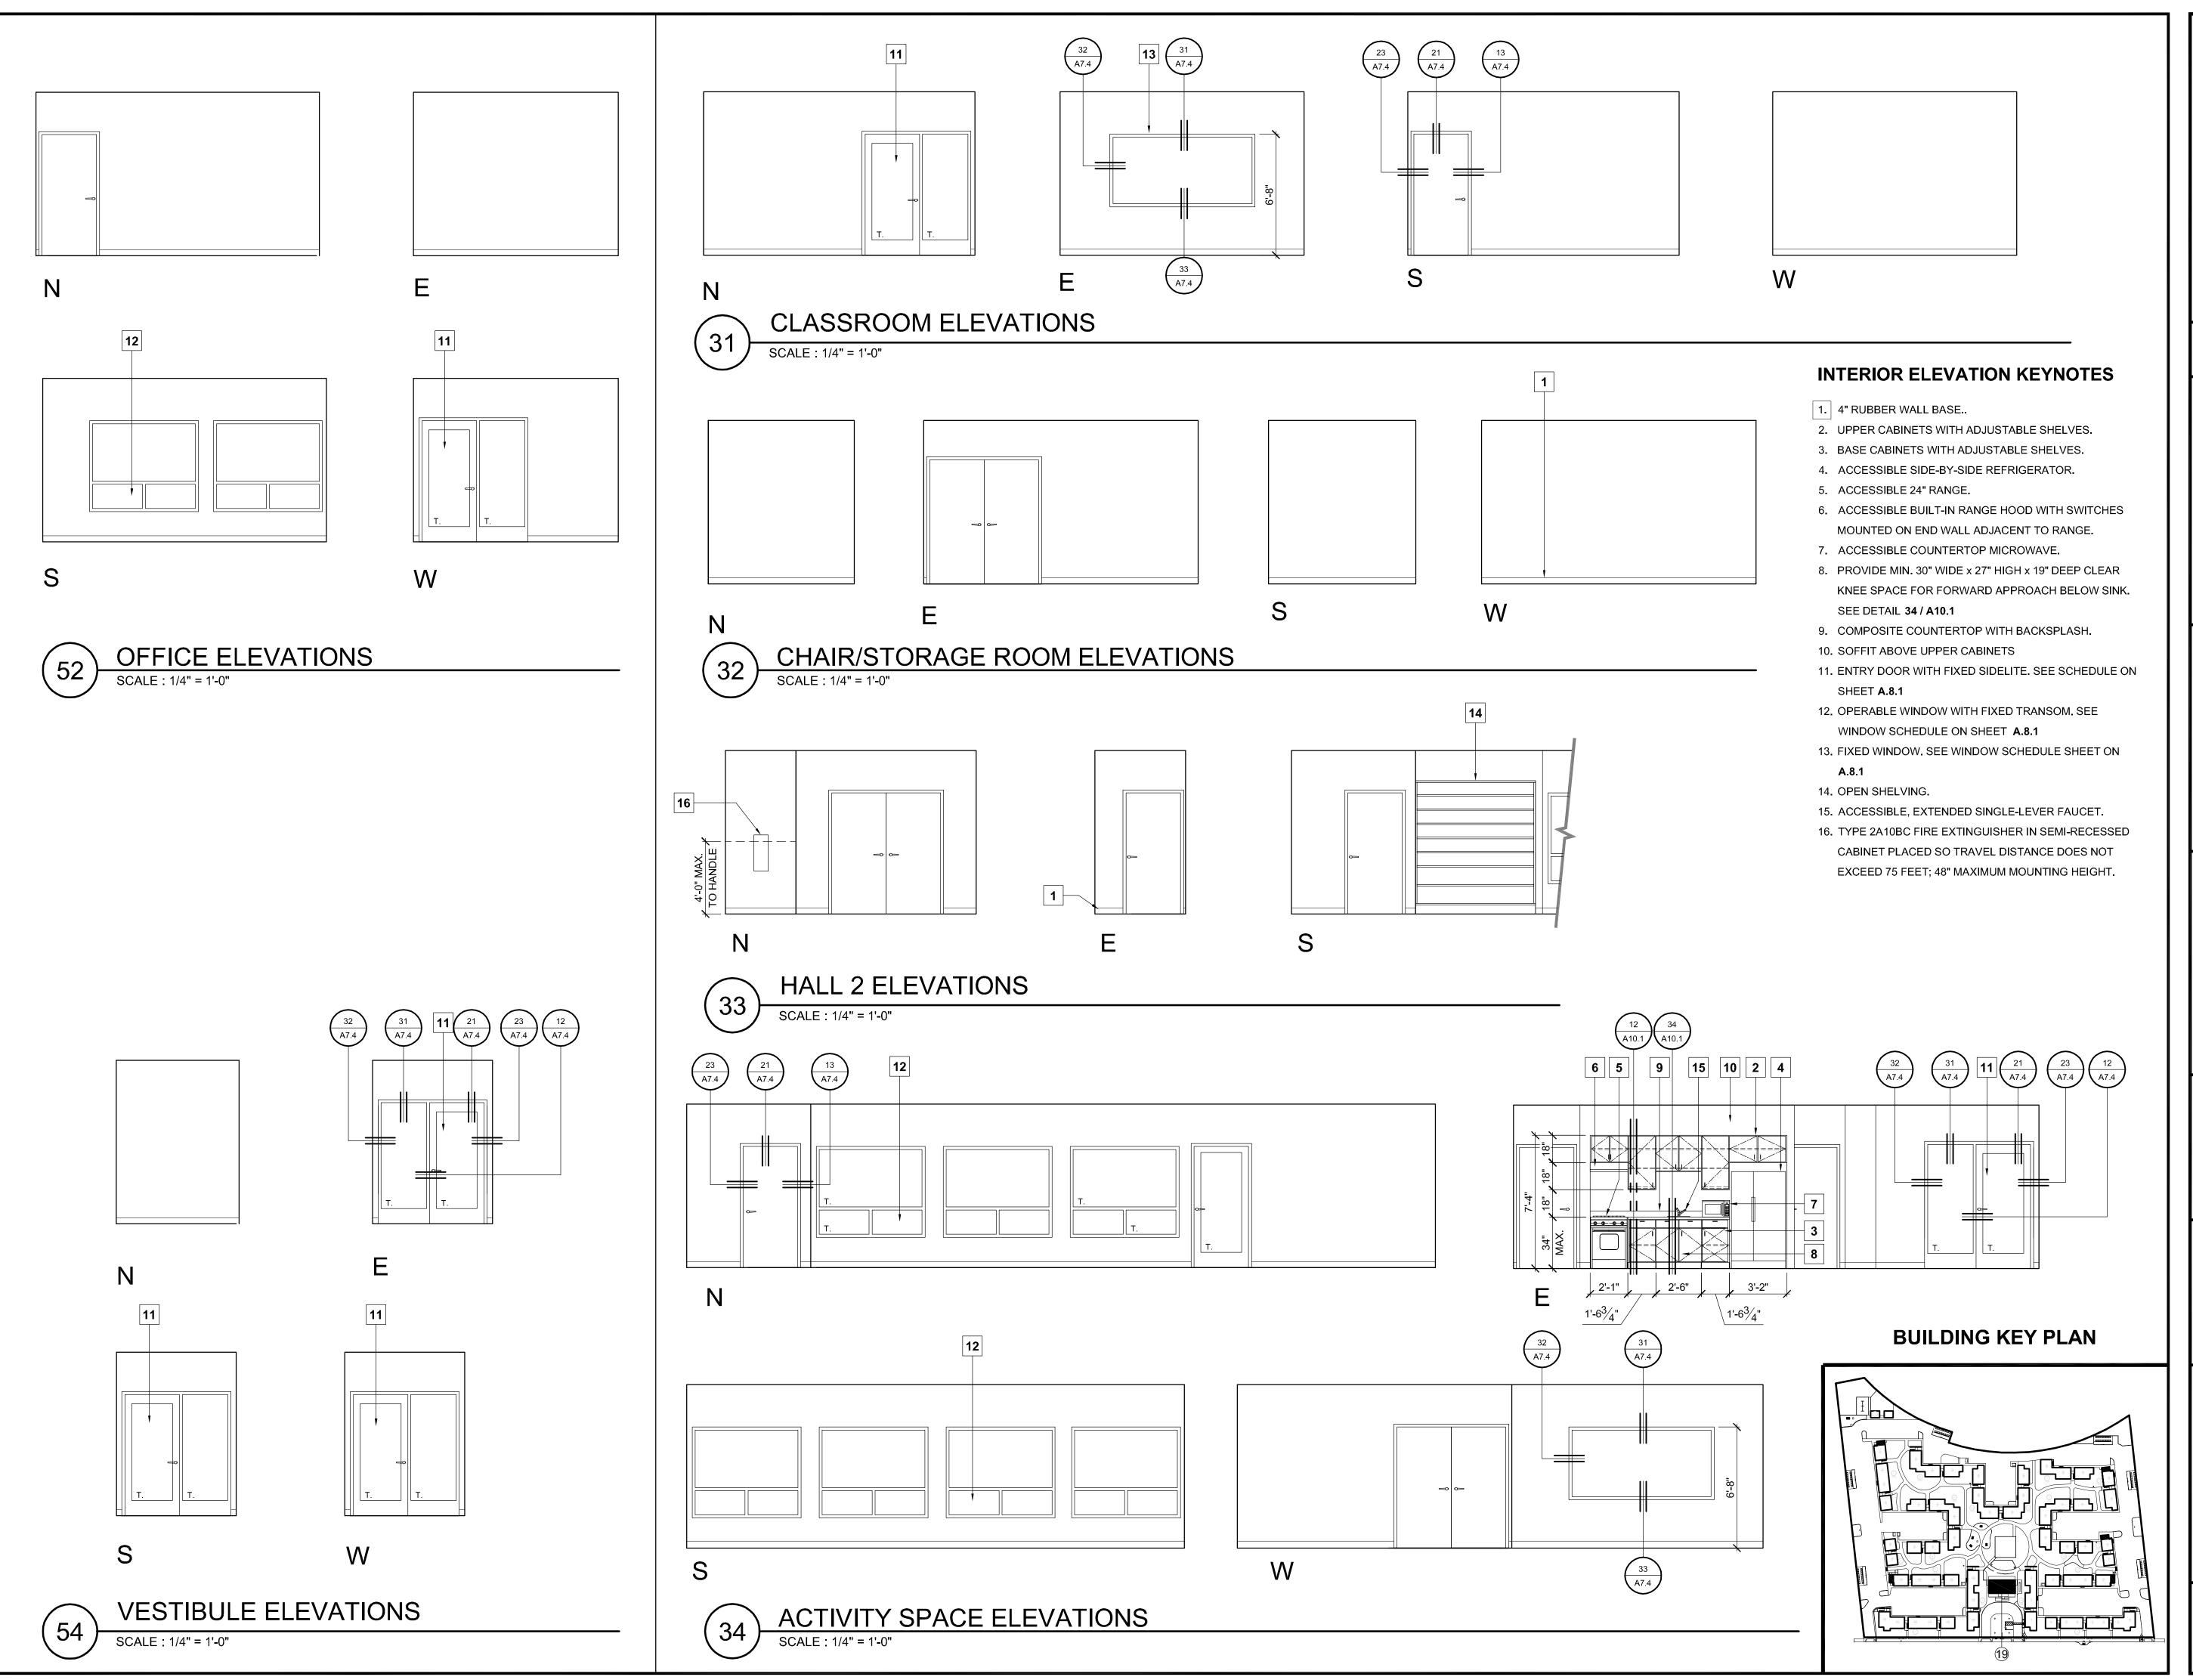

MADONNA ROAD APARTMENTS

A RENOVATION AND UPGRADE PROJECT

1550 MADONNA ROAD SAN LUIS OBISPO, CA

CLIENT JOB#

1207

ARCHITECT JOB#



971 OSOS STREET SAN LUIS OBISPO CALIFORNIA 93401

805-544-6161


www.fraserseiplearchitects.com

PROJECT MANAGER BDF

DRAWN BY DDL

M BY DDF

08-08-2012 1st SUBMITTAL
09-19-2012 1st RE-SUBMITTAL
10-05-2012 FOR CONSTRUCTION

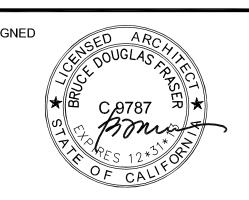

The use of these plans and specifications shall be restricted the original site for which they were prepared and publication thereof is expressly limited to such use. Reproduction or publication by any method, in whole or in part, is prohibited. Title to these plans and specifications remain with the architect without prejudice. Visual contact with these plans and specifications shall constitute prima facie evidence of the acceptance of these restrictions.

over scaled dimensions. Contractors shall verify and be responsible for all dimensions and existing conditions on the job and shall report any discrepancies to the architect for resolution prior to commencing work.


SHEET TITLE

INTERIOR ELEVATIONS


(COMMON BUILDING)

SCALE: 1/4" = 1'=0"

A7.2

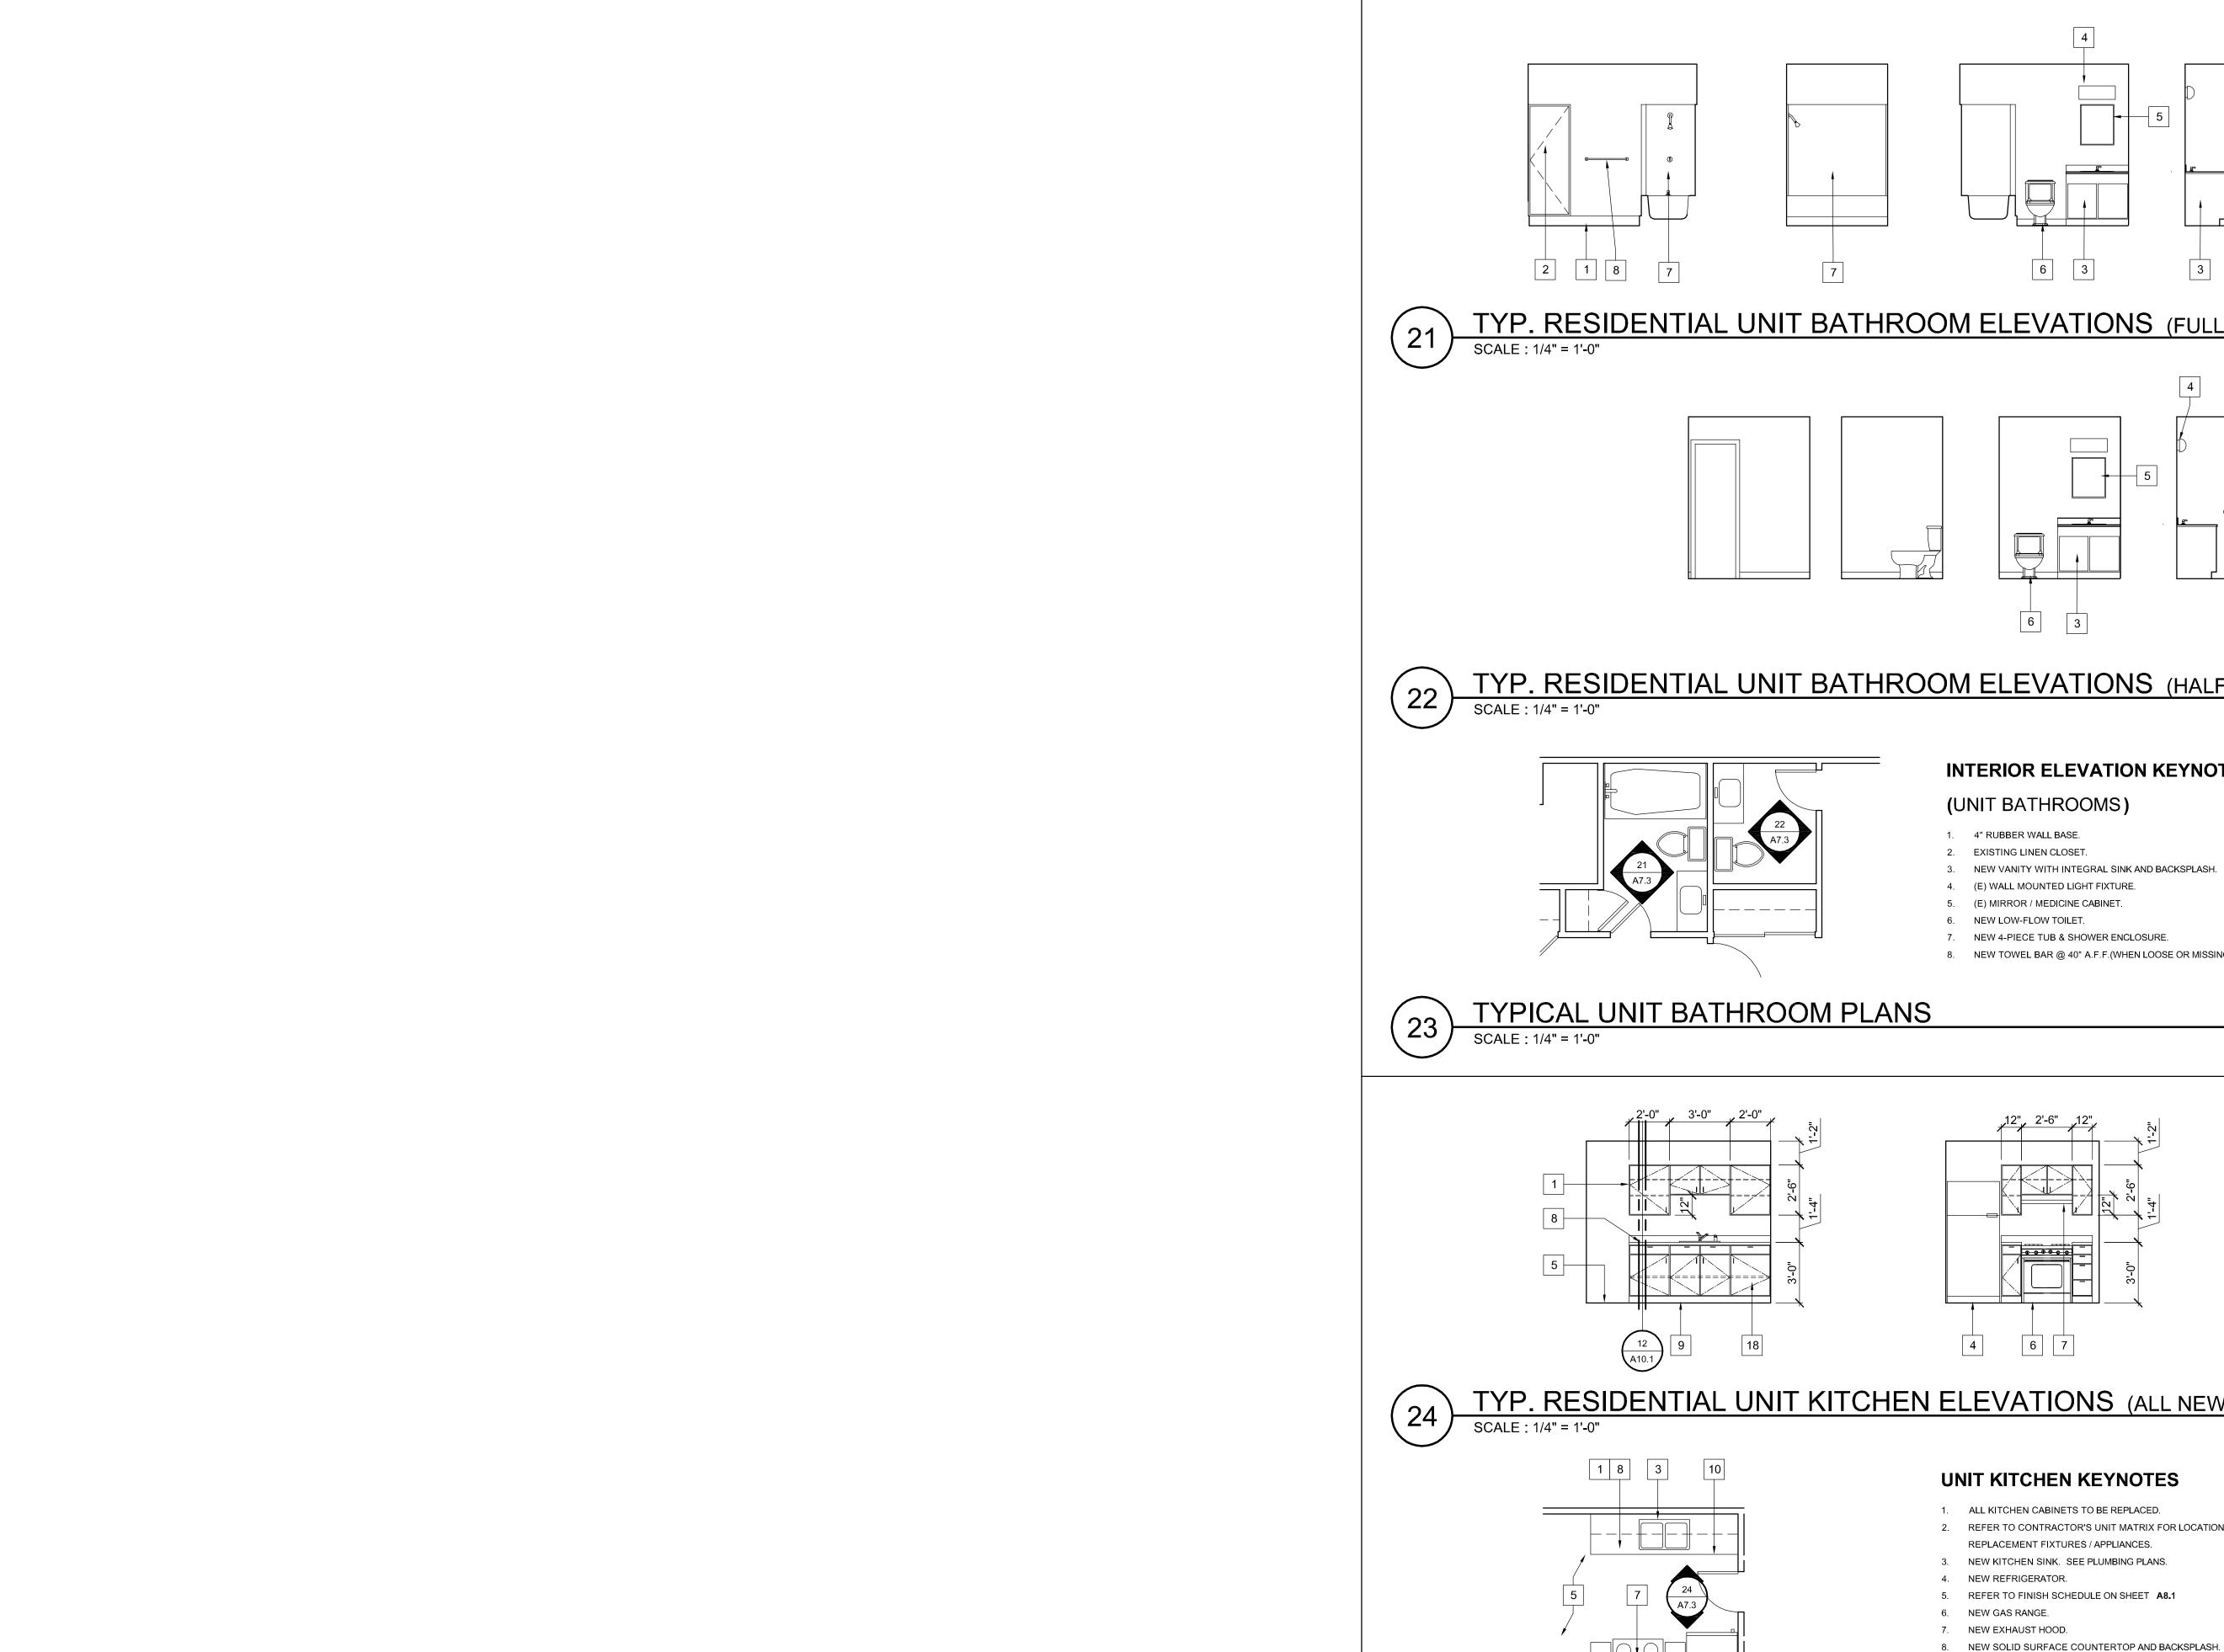

TYP. RESIDENTIAL UNIT BATHROOM ELEVATIONS (FULL BATH)

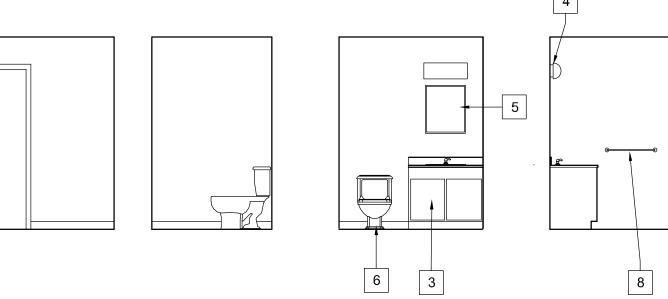


TYP. RESIDENTIAL UNIT BATHROOM ELEVATIONS (HALF BATH)


INTERIOR ELEVATION KEYNOTES

3

- NEW VANITY WITH INTEGRAL SINK AND BACKSPLASH.
- 7. NEW 4-PIECE TUB & SHOWER ENCLOSURE.
- 8. NEW TOWEL BAR @ 40" A.F.F.(WHEN LOOSE OR MISSING)

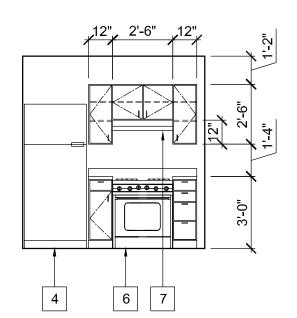

TYP. RESIDENTIAL UNIT KITCHEN ELEVATIONS (ALL NEW CABINETS)

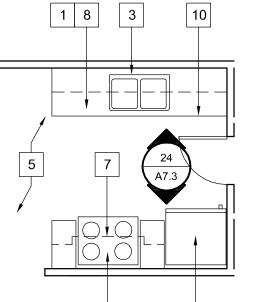

UNIT KITCHEN KEYNOTES

- 2. REFER TO CONTRACTOR'S UNIT MATRIX FOR LOCATION AND QUANTITY OF

- 9. NEW BASE, SEE SCHEDULE ON SHEET A8.1
- 10. FOOTPRINT OF NEW BASE CABINETS TO MATCH EXISTING IN ORDER TO PROTECT EXISTING FLOORING. FIELD VERIFY DIMENSIONS.

TYP. RESIDENTIAL UNIT KITCHEN FLOOR PLAN (ALL NEW CABINETS)

MADONNA ROAD APARTMENTS

A RENOVATION AND **UPGRADE PROJECT**

1550 MADONNA ROAD SAN LUIS OBISPO, CA

CLIENT JOB#

ARCHITECT JOB# 1207



971 OSOS STREET SAN LUIS OBISPO CALIFORNIA 93401

805-544-6161

www.fraserseiplearchitects.com

PROJECT MANAGER BDF

DRAWN BY DDL

08-08-2012 1st SUBMITTAL 09-19-2012 1st RE-SUBMITTAL

10-05-2012 FOR CONSTRUCTION

The use of these plans and specifications shall be restricted the original site for which they were prepared and publication thereof is expressly limited to such use. Reproduction or publication by any method, in whole or in part, is prohibited. Title to these plans and specifications remain with the architect without prejudice. Visual contact with these plans and specifications shall constitute prima facie evidence of the acceptance of these restrictions.

Written dimensions on these drawings shall have precedence over scaled dimensions. Contractors shall verify and be responsible for all dimensions and existing conditions on the job and shall report any discrepancies to the architect for resolution prior to commencing work.


SHEET TITLE

INTERIOR ELEVATIONS

(DWELLING UNITS)

SCALE: 1/4" = 1'=0"

A7.3

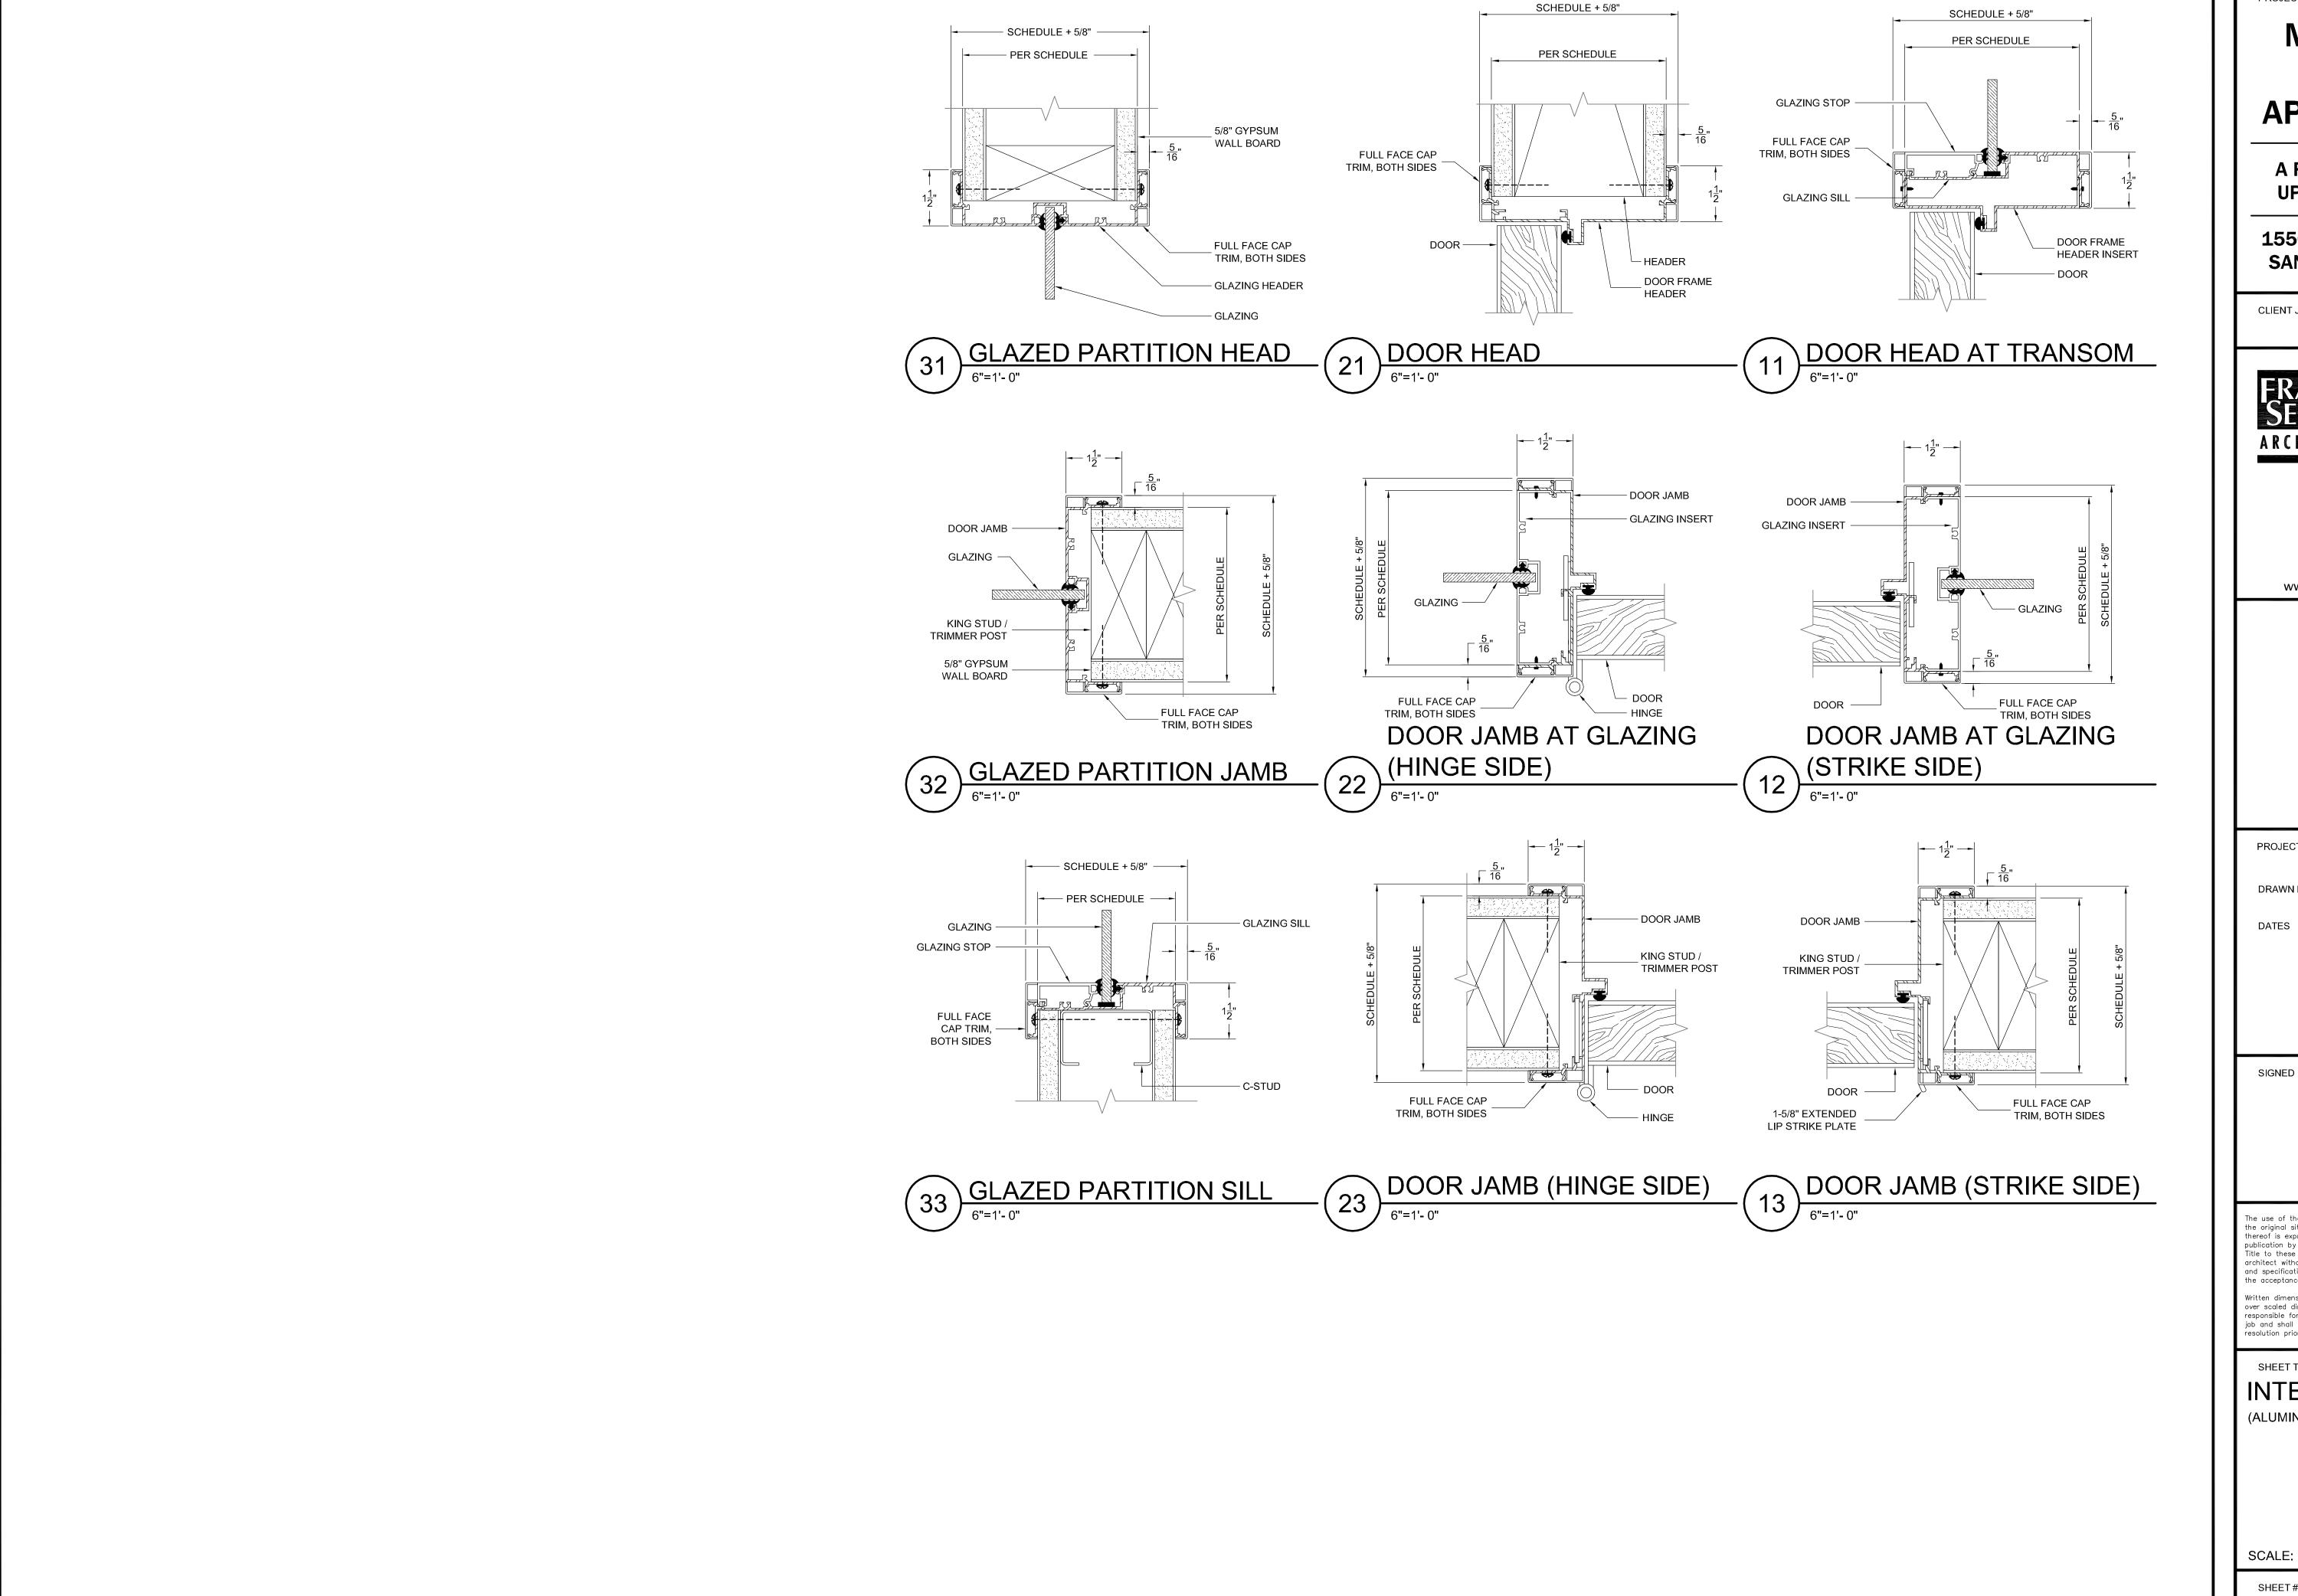

MADONNA ROAD APARTMENTS

A RENOVATION AND **UPGRADE PROJECT**

1550 MADONNA ROAD SAN LUIS OBISPO, CA

CLIENT JOB#

ARCHITECT JOB# 1207



971 OSOS STREET SAN LUIS OBISPO CALIFORNIA 93401


805-544-6161

www.fraserseiplearchitects.com

PROJECT MANAGER BDF

DRAWN BY DDL

08-08-2012 1st SUBMITTAL 09-19-2012 1st RE-SUBMITTAL 10-05-2012 FOR CONSTRUCTION

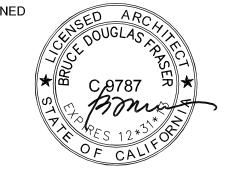

The use of these plans and specifications shall be restricted the original site for which they were prepared and publication thereof is expressly limited to such use. Reproduction or publication by any method, in whole or in part, is prohibited. Title to these plans and specifications remain with the architect without prejudice. Visual contact with these plans and specifications shall constitute prima facie evidence of the acceptance of these restrictions.

Written dimensions on these drawings shall have precedence over scaled dimensions. Contractors shall verify and be responsible for all dimensions and existing conditions on the job and shall report any discrepancies to the architect for resolution prior to commencing work.

SHEET TITLE

INTERIOR DETAILS (ALUMINUM FRAMES)


SCALE: 6" = 1'=0"

WINDOW SCHEDULE

SYM.	TYPE	FRAME	WIDTH	HT.	GLAZING	REMARKS
Α	1	VW	8'-0"	4'-0"	G.1	ASYMMETRICAL SLIDING VINYL WINDOW
В	2	VW	5'-0"	4'-0"	G.1	SLIDING VINYL WINDOW
С	2	VW	4'-0"	4'-0"	G.1	SLIDING VINYL WINDOW
D	3	VW	3'-0"	4'-0"	G.1	SINGLE HUNG VINYL WINDOW
Е	4	VW	6'-0"	5'-0"	G.1 / G.2	FIXED/ SLIDING VINYL WINDOW, TEMPERED PER A5.1
F	5	HM	2'-6"	5'-10"	G.2	FIXED SIDELITE, TEMPERED, HOLLOW METAL FRAME
G	5	AL	2'-6"	5'-10"	G.2	FIXED SIDELITE, TEMPERED, ALUMINUM FRAME
Η	6	AL	8'-0"	3'-0"	G.1	FIXED TRANSOM, ALUMINUM FRAME
I	2	VW	3'-0"	2'-0"	G.4	SLIDING VINYL WINDOW
,						

GLAZING LEGEND:

- G.1 DUAL PANE INSULATING GLASS, LOW E, REGULAR STRENGTH
- G.2 DUAL PANE INSULATING GLASS, LOW E, TEMPERED
- G.3 1/4" SINGLE PANE GLASS, TEMPERED
- G.4 DUAL PANE INSULATING GLASS, LOW E, REGULAR STRENGTH, OBSCURE

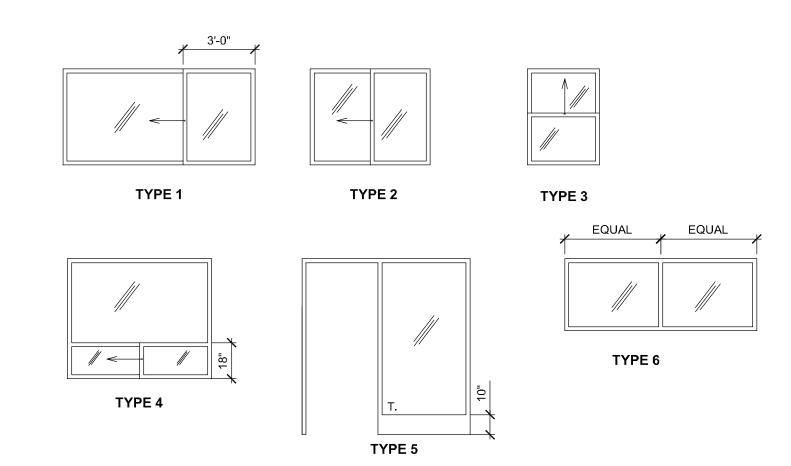

DOOR SCHEDULE

NO. TYPE FRAME WIDTH HT. THICK. HDWRE.

	''' -	LIVAME	**10 111	''''	THION.	TIDVVIXE.	
RESID	ENTIAL UN	IT DOORS					
(1)	FG.1	WF.1	3'-0"	6'-8"	1-3/4"	1	EXTERIOR ENTRY, INSULATED FIBERGLASS
2	WD.1	WF.1	2'-6"	6'-8"	1-3/8"	2	BEDROOM PRIVACY, HOLLOW CORE WOOD
3	WD.1	WF.1	2'-0"	6'-8"	1-3/8"	3	STORAGE/UTILITY, HOLLOW CORE WOOD
4	WD.1	WF.1	2'-0"	6'-8"	1-3/8"	4	BATHROOM PRIVACY, HOLLOW CORE WOOD
5	WD.2	WF.1	3'-0"	6'-8"	1-3/8"	5	CLOSET BI-FOLD, HOLLOW CORE WOOD
6	WD.3	WF.1	5'-6"	8'-0"	1-3/8"	6	CLOSET BI-PASS, HOLLOW CORE WOOD
7	WD.3	WF.1	5'-0"	8'-0"	1-3/8"	6	CLOSET BI-PASS, HOLLOW CORE WOOD
8	WD.3	WF.1	4'-0"	8'-0"	1-3/8"	6	CLOSET BI-PASS, HOLLOW CORE WOOD
		WF.1	3'-6"	6'-8"	1-3/8"	5	CLOSET BI-FOLD, HOLLOW CORE WOOD
9 COMM	WD.2 ON AREA						
СОММ	ON AREA D	DOORS	3' 0"	6, 6,	1 2/4"	7	ACCESSIBLE ENTRY/EVIT INISH ATER FIREDCHASS SINCLE LITE TEMPEDER
COMM 10	ON AREA [OOORS HM.1	3'-0"	6'-8"	1-3/4"	7 8	ACCESSIBLE ENTRY/EXIT, INSULATED FIBERGLASS, SINGLE LITE, TEMPERED ACCESSIBLE LOCKING PASSAGE, SOLID CORE WOOD, SINGLE LITE, TEMPERED
COMM 10 11	ON AREA D	DOORS HM.1 AL.2	3'-0"	6'-8"	1-3/4"	8	ACCESSIBLE LOCKING PASSAGE, SOLID CORE WOOD, SINGLE LITE, TEMPERED
10 11 12	ON AREA DE FG.2 WD.4 WD.4	HM.1 AL.2 AL.3	3'-0" 3'-0"	6'-8" 6'-8"	1-3/4" 1-3/4"	8	ACCESSIBLE LOCKING PASSAGE, SOLID CORE WOOD, SINGLE LITE, TEMPERED ACCESSIBLE LOCKING PASSAGE, SOLID CORE WOOD, SINGLE LITE, TEMPERED
10 11 12 13	ON AREA DE FG.2 WD.4 WD.4 WD.5	HM.1 AL.2 AL.3 AL.4	3'-0" 3'-0" 6'-0"	6'-8" 6'-8" 6'-8"	1-3/4" 1-3/4" 1-3/4"	8 8 11	ACCESSIBLE LOCKING PASSAGE, SOLID CORE WOOD, SINGLE LITE, TEMPERED ACCESSIBLE LOCKING PASSAGE, SOLID CORE WOOD, SINGLE LITE, TEMPERED ACCESSIBLE STOREROOM, SOLID CORE WOOD
10 11 12 13 14	FG.2 WD.4 WD.4 WD.5 WD.1	DOORS HM.1 AL.2 AL.3 AL.4 AL.4	3'-0" 3'-0" 6'-0" 3'-0"	6'-8" 6'-8" 6'-8" 6'-8"	1-3/4" 1-3/4" 1-3/4" 1-3/4"	8 8 11 8	ACCESSIBLE LOCKING PASSAGE, SOLID CORE WOOD, SINGLE LITE, TEMPERED ACCESSIBLE LOCKING PASSAGE, SOLID CORE WOOD, SINGLE LITE, TEMPERED ACCESSIBLE STOREROOM, SOLID CORE WOOD ACCESSIBLE LOCKING PASSAGE, SOLID CORE WOOD
10 11 12 13 14 15	FG.2 WD.4 WD.4 WD.5 WD.1	HM.1 AL.2 AL.3 AL.4 AL.4 AL.4	3'-0" 3'-0" 6'-0"	6'-8" 6'-8" 6'-8"	1-3/4" 1-3/4" 1-3/4" 1-3/4" 1-3/4"	8 8 11 8 10	ACCESSIBLE LOCKING PASSAGE, SOLID CORE WOOD, SINGLE LITE, TEMPERED ACCESSIBLE LOCKING PASSAGE, SOLID CORE WOOD, SINGLE LITE, TEMPERED ACCESSIBLE STOREROOM, SOLID CORE WOOD ACCESSIBLE LOCKING PASSAGE, SOLID CORE WOOD ACCESSIBLE RESTROOM, SOLID CORE WOOD
10 11 12 13 14	FG.2 WD.4 WD.4 WD.5 WD.1	DOORS HM.1 AL.2 AL.3 AL.4 AL.4	3'-0" 3'-0" 6'-0" 3'-0"	6'-8" 6'-8" 6'-8" 6'-8"	1-3/4" 1-3/4" 1-3/4" 1-3/4"	8 8 11 8	ACCESSIBLE LOCKING PASSAGE, SOLID CORE WOOD, SINGLE LITE, TEMPERED ACCESSIBLE LOCKING PASSAGE, SOLID CORE WOOD, SINGLE LITE, TEMPERED ACCESSIBLE STOREROOM, SOLID CORE WOOD ACCESSIBLE LOCKING PASSAGE, SOLID CORE WOOD
10 11 12 13 14 15	FG.2 WD.4 WD.4 WD.5 WD.1 WD.1	HM.1 AL.2 AL.3 AL.4 AL.4 AL.4 AL.4	3'-0" 3'-0" 6'-0" 3'-0" 3'-0"	6'-8" 6'-8" 6'-8" 6'-8" 6'-8"	1-3/4" 1-3/4" 1-3/4" 1-3/4" 1-3/4" 1-3/4"	8 8 11 8 10 13	ACCESSIBLE LOCKING PASSAGE, SOLID CORE WOOD, SINGLE LITE, TEMPERED ACCESSIBLE LOCKING PASSAGE, SOLID CORE WOOD, SINGLE LITE, TEMPERED ACCESSIBLE STOREROOM, SOLID CORE WOOD ACCESSIBLE LOCKING PASSAGE, SOLID CORE WOOD ACCESSIBLE RESTROOM, SOLID CORE WOOD ACCESSIBLE RESTROOM, SOLID CORE WOOD
10 11 12 13 14 15 16 17	FG.2 WD.4 WD.4 WD.5 WD.1 WD.1 WD.1 WD.5	DOORS HM.1 AL.2 AL.3 AL.4 AL.4 AL.4 AL.4 AL.4 AL.4	3'-0" 3'-0" 6'-0" 3'-0" 3'-0" 5'-0"	6'-8" 6'-8" 6'-8" 6'-8" 6'-8"	1-3/4" 1-3/4" 1-3/4" 1-3/4" 1-3/4" 1-3/4"	8 8 11 8 10 13	ACCESSIBLE LOCKING PASSAGE, SOLID CORE WOOD, SINGLE LITE, TEMPERED ACCESSIBLE LOCKING PASSAGE, SOLID CORE WOOD, SINGLE LITE, TEMPERED ACCESSIBLE STOREROOM, SOLID CORE WOOD ACCESSIBLE LOCKING PASSAGE, SOLID CORE WOOD ACCESSIBLE RESTROOM, SOLID CORE WOOD ACCESSIBLE RESTROOM, SOLID CORE WOOD EQUIPMENT ROOM PASSAGE, SOLID CORE WOOD
10 11 12 13 14 15 16 17 18	FG.2 WD.4 WD.4 WD.5 WD.1 WD.1 WD.1 WD.5 WD.5	DOORS HM.1 AL.2 AL.3 AL.4 AL.4 AL.4 AL.4 AL.4 AL.4 AL.4	3'-0" 3'-0" 6'-0" 3'-0" 3'-0" 5'-0"	6'-8" 6'-8" 6'-8" 6'-8" 6'-8" 6'-8"	1-3/4" 1-3/4" 1-3/4" 1-3/4" 1-3/4" 1-3/4" 1-3/4"	8 8 11 8 10 13 11	ACCESSIBLE LOCKING PASSAGE, SOLID CORE WOOD, SINGLE LITE, TEMPERED ACCESSIBLE LOCKING PASSAGE, SOLID CORE WOOD, SINGLE LITE, TEMPERED ACCESSIBLE STOREROOM, SOLID CORE WOOD ACCESSIBLE LOCKING PASSAGE, SOLID CORE WOOD ACCESSIBLE RESTROOM, SOLID CORE WOOD ACCESSIBLE RESTROOM, SOLID CORE WOOD EQUIPMENT ROOM PASSAGE, SOLID CORE WOOD ACCESSIBLE STOREROOM, SOLID CORE WOOD

HARDWARE SCHEDULE

G	ROI	UP	1

Hinges: 3, standard duty residential (Stanley F179/US26D or equivalent) Lockset: standard duty entry function, lever handle (Schlage AL53PD/Saturn/626 or equivalent) <u>Viewer:</u> 120 degree, thru-door viewer (Ives 700/US26D or equivalent) Door Bottom: full width shoe with vinyl sweep (Pemko 217AV or equivalent) Seals: aluminum/vinyl gasket, head and jambs (Pemko 292 PAV or equivalent)

Hinges: 3, standard duty residential (Stanley RD741/US26D or equivalent) Lockset: standard duty privacy function, lever handle (Schlage F40/Elan/626 or equivalent) Stop: wall base stop (Ives 61/626 or equivalent)

GROUP 3

Hinges: 3, standard duty residential (Stanley RD741/US26D or equivalent) <u>Latchset:</u> standard duty passage function, lever handle (Schlage F10/Elan/626 or equivalent) Stop: wall base stop (Ives 61/626 or equivalent)

Hinges: 3, standard duty residential (Stanley RD741/US26D or equivalent) <u>Lockset:</u> standard duty privacy function, lever handle (Schlage F40/Elan/626 or equivalent) Stop: wall base stop (Ives 61/626 or equivalent)

Hinges and Track: standard duty hardware set (Stanley 402032 at Door 5, 404042 at Door 9, white or equivalent)

GROUP 6

Track Set: standard duty hardware set (Stanley 1755/white or equivalent)

Pulls: 2, recessed rectangular flush pulls (Ives 227B/satin nickel or equivalent)

<u>Hinges:</u> 3, ball bearing standard duty (Stanley FBB179/US26D or equivalent) Lockset: heavy duty entry function, lever handle (Schlage AL53PD/SAT/626 or equivalent) Closer: inside surface mount (LCN 4110 or equivalent) <u>Door Bottom:</u> aluminum shoe, vinyl bulb smoke seal (Pemko 217DV or equivalent) Threshold: accessible saddle, full width (Pemko 270D or equivalent) Seals: silicone bulb, all sides (Pemko S88 or equivalent)

Hinges: 3, ball bearing standard duty (Stanley FBB179/US26D or equivalent) Lockset: heavy duty entry function, lever handle (Schlage AL53PD/SAT/626 or equivalent) Closer: inside surface mount (LCN 4110 or equivalent)

Stops: wall surface stop (Ives WS401/626 or equivalent) Seals: silicone bulb, all sides (Pemko S88 or equivalent)

Hinges: 3, standard duty (Stanley F179/US26D or equivalent) <u>Lockset:</u> medium duty classroom function (Schlage AL70PD/SAT/626 or equivalent) Stops: wall surface stop (Ives WS401/626 or equivalent)

Hinges: 3, standard duty (Stanley F179/US26D or equivalent) <u>Lockset:</u> medium duty privacy function (Schlage AL40S/SAT/626 or equivalent) Stops: wall surface stop (Ives WS401/626 or equivalent) Seals: silicone bulb, all sides (Pemko S88 or equivalent)

Hinges: 3, standard duty (Stanley F179/US26D or equivalent) <u>Lockset:</u> medium duty storeroom function (Schlage AL80PD/SAT/626 or equivalent) Dummy Trim: medium duty single dummy trim (Schlage AL170/SAT/626 or equivalent) Flush Bolts: manual flush bolts, top and bottom, inactive leaf (Ives FB358/626 or equivalent) Stops: wall surface stop (Ives WS401/626 or equivalent) Seals (Door 17 only): silicone bulb, all sides (Pemko S88 or equivalent)

GROUP 12

Hinges: 3, standard duty (Stanley F179/US26D or equivalent) <u>Lockset:</u> medium duty classroom function,(Schlage AL70PD/SAT/626 or equivalent) Stops: wall surface stop (Ives WS401/626 or equivalent) Seals: silicone bulb, all sides (Pemko S88 or equivalent)

GROUP 13

Hinges: 3, standard duty (Stanley F179/US26D or equivalent) Lockset: medium duty deadbolt & thumbturn with "Occupied" indicator Stops: wall surface stop (Ives WS401/626 or equivalent) Seals: silicone bulb, all sides (Pemko S88 or equivalent)

FINISH SCHEDULES

UNITS

ROOM NAME	FLOOR	BASE	WALLS/CEILING	REMARKS
LIVING	CAR-1	WD-1	GB-1	
DINING	VPF-1	WD-1	GB-1	
KITCHEN	VPF-1	RB-1	GB-1	
PANTRY	VPF-1	RB-1	GB-1	
HALLS	VPF-1	RB-1	GB-1	
BATHROOMS	VPF-1	RB-1	GB-1	
BEDROOMS	CAR-1	WD-1	GB-1	
BEDROOM / LINEN	CAR-1	WD-1	GB-1	
EQUIPMENT CLOSETS	VPF-1	WD-1	GB-2	

COMMON BUILDINGS

ROOM NAME	FLOOR	BASE	WALLS/CEILING	CEILING
ENTRY VESTIBULE	RF-4	RB-1	GB-1	
OFFICE	CAR-2	RB-2	GB-1	
ACTIVITY SPACE	RF-3,4,5	RB-1	GB-1	REFER TO SHEET A2.1 FOR FLOOR PATTERN
STORAGE	RF-4	RB-1	GB-1	
CLASSROOM	CAR-2	RB-2	GB-1	
WARMING KITCHEN	RF-4	RB-1	GB-1	
MEN'S RESTROOM	CT-1	CT-2	GB-1, CT-3	
WOMEN'S RESTROOM	CT-1	CT-2	GB-1, CT-3	
MECHANICAL/JANITOR	SC-1	RB-1	GB-1, FRP-1	FRP TO 4'-0" A.F.F. @ MOP SINK
HALLS	RF-4	RB-1	GB-1	
LAUNDRY	RF-3	RB-1	GB-1	
FILE, CHAIR STORAGE	RF-4	RB-1	GB-2	

FINISH LEGEND

	FLOOR
VPF-1	VINYL PLANK FLOORING
RF-2	SHEET RESILIENT FLOORING
RF-3	12"x12" COMMERCIAL GRADE VINYL COMPOSITION TILE
RF-4	12"x12" COMMERCIAL GRADE VINYL COMPOSITION TILE
RF-5	12"x12" COMMERCIAL GRADE VINYL COMPOSITION TILE
CAR-1	LEVEL LOOP CARPET WITH PAD, 20 OZ.
CAR-2	LEVEL LOOP CARPET, 26 OZ.
CT-1	6"x6" CERAMIC TILE
SC-1	SEALED CONCRETE

	BASE
CB-1	RESILIENT FLOORING COVE BASE
RB-1	4" COVED RESILIENT WALL BASE
RB-2	4" STRAIGHT RESILIENT WALL BASE
CT-2	COVED CERAMIC TILE BASE
WD-1	2 1/2" PAINTED WOOD BASE

	WALLS AND CEILING	
GB-1	GYPSUM BOARD, TEXTURED, SEMI-GLOSS PAINT	
GB-2	GYPSUM BOARD, TAPED ONLY, FLAT PAINT	
CT-3	6"x6" CERAMIC TILE	
FRP-1	FIBERGLASS REINFORCED PANEL	


GENERAL FINISH NOTES:


- Residential finishes in the Finish Schedule describe only those items to be replaced; refer to Contractor's replacement matrix to determine where these items apply.
- Any replacement gypsum board shall be type X firecode rated when applied to party wall conditions.
- During removal of existing finishes any potential evidence of mold within construction assemblies shall be brought to the attention of a qualified professional, and mitigated as directed prior to re-enclosure.
- Prior to installation confirm that interior finish materials do not exceed the maximum flame spread for classifications based on occupancy per CBC Table 803.5.
- The maximum pile height of carpet shall be 1/2".


DOOR NOTES:


- 1. Residential unit doors and hardware in the Door Schedule describe only those items to be replaced; refer to Contractor's replacement matrix to determine where these items apply.
- 2. The unlatching of any exit door shall not require more than one
- 3. All exit doors shall be operable from the inside without the use of a key or any special knowledge.
- 4. Hardware at doors accessible to the physically disabled shall be centerd between 30 and 44 inches above the finished floor or landing, and shall be operable without the requirement to grasp the operating hardware.
- Exterior and interior door thresholds along an accessible path of travel shall be no more than 1/2 inch above adjacent floor levels, with no single vertical face exceeding 1/4 inch and sloping at a minimum of 2 horizontal to 1 vertical between 1/4 inch and 1/2 inch rise.
- 6. The pressure exerted by door closers shall not exceed 5
- 7. The bottom 10 inches of all accessible doors shall be a smooth, uninterrupted surface.
- 8. All glazing in doors shall be tempered safety glass.

DOOR TYPES

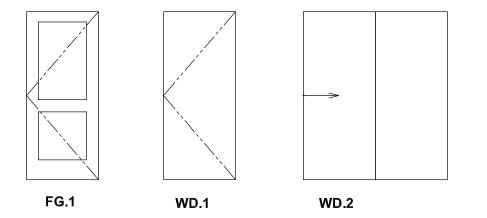

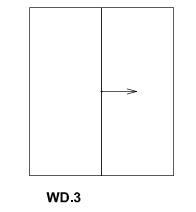

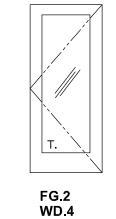

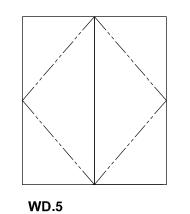

PROJECT

MADONNA ROAD APARTMENTS

A RENOVATION AND **UPGRADE PROJECT**

1550 MADONNA ROAD SAN LUIS OBISPO, CA

CLIENT JOB#

ARCHITECT JOB# 1207



971 OSOS STREET SAN LUIS OBISPO CALIFORNIA 93401

805-544-6161

www.fraserseiplearchitects.com

PROJECT MANAGER BDF

DRAWN BY DDL

08-08-2012 1st SUBMITTAL 09-19-2012 1st RE-SUBMITTAL 10-05-2012 FOR CONSTRUCTION

SIGNED


The use of these plans and specifications shall be restricted the original site for which they were prepared and publication thereof is expressly limited to such use. Reproduction or publication by any method, in whole or in part, is prohibited. Title to these plans and specifications remain with the architect without prejudice. Visual contact with these plans

and specifications shall constitute prima facie evidence of ne acceptance of these restrictions. Written dimensions on these drawings shall have precedence over scaled dimensions. Contractors shall verify and be responsible for all dimensions and existing conditions on the

job and shall report any discrepancies to the architect for resolution prior to commencing work.

SHEET TITLE

DOOR, WINDOW & FINISH SCHEDULES

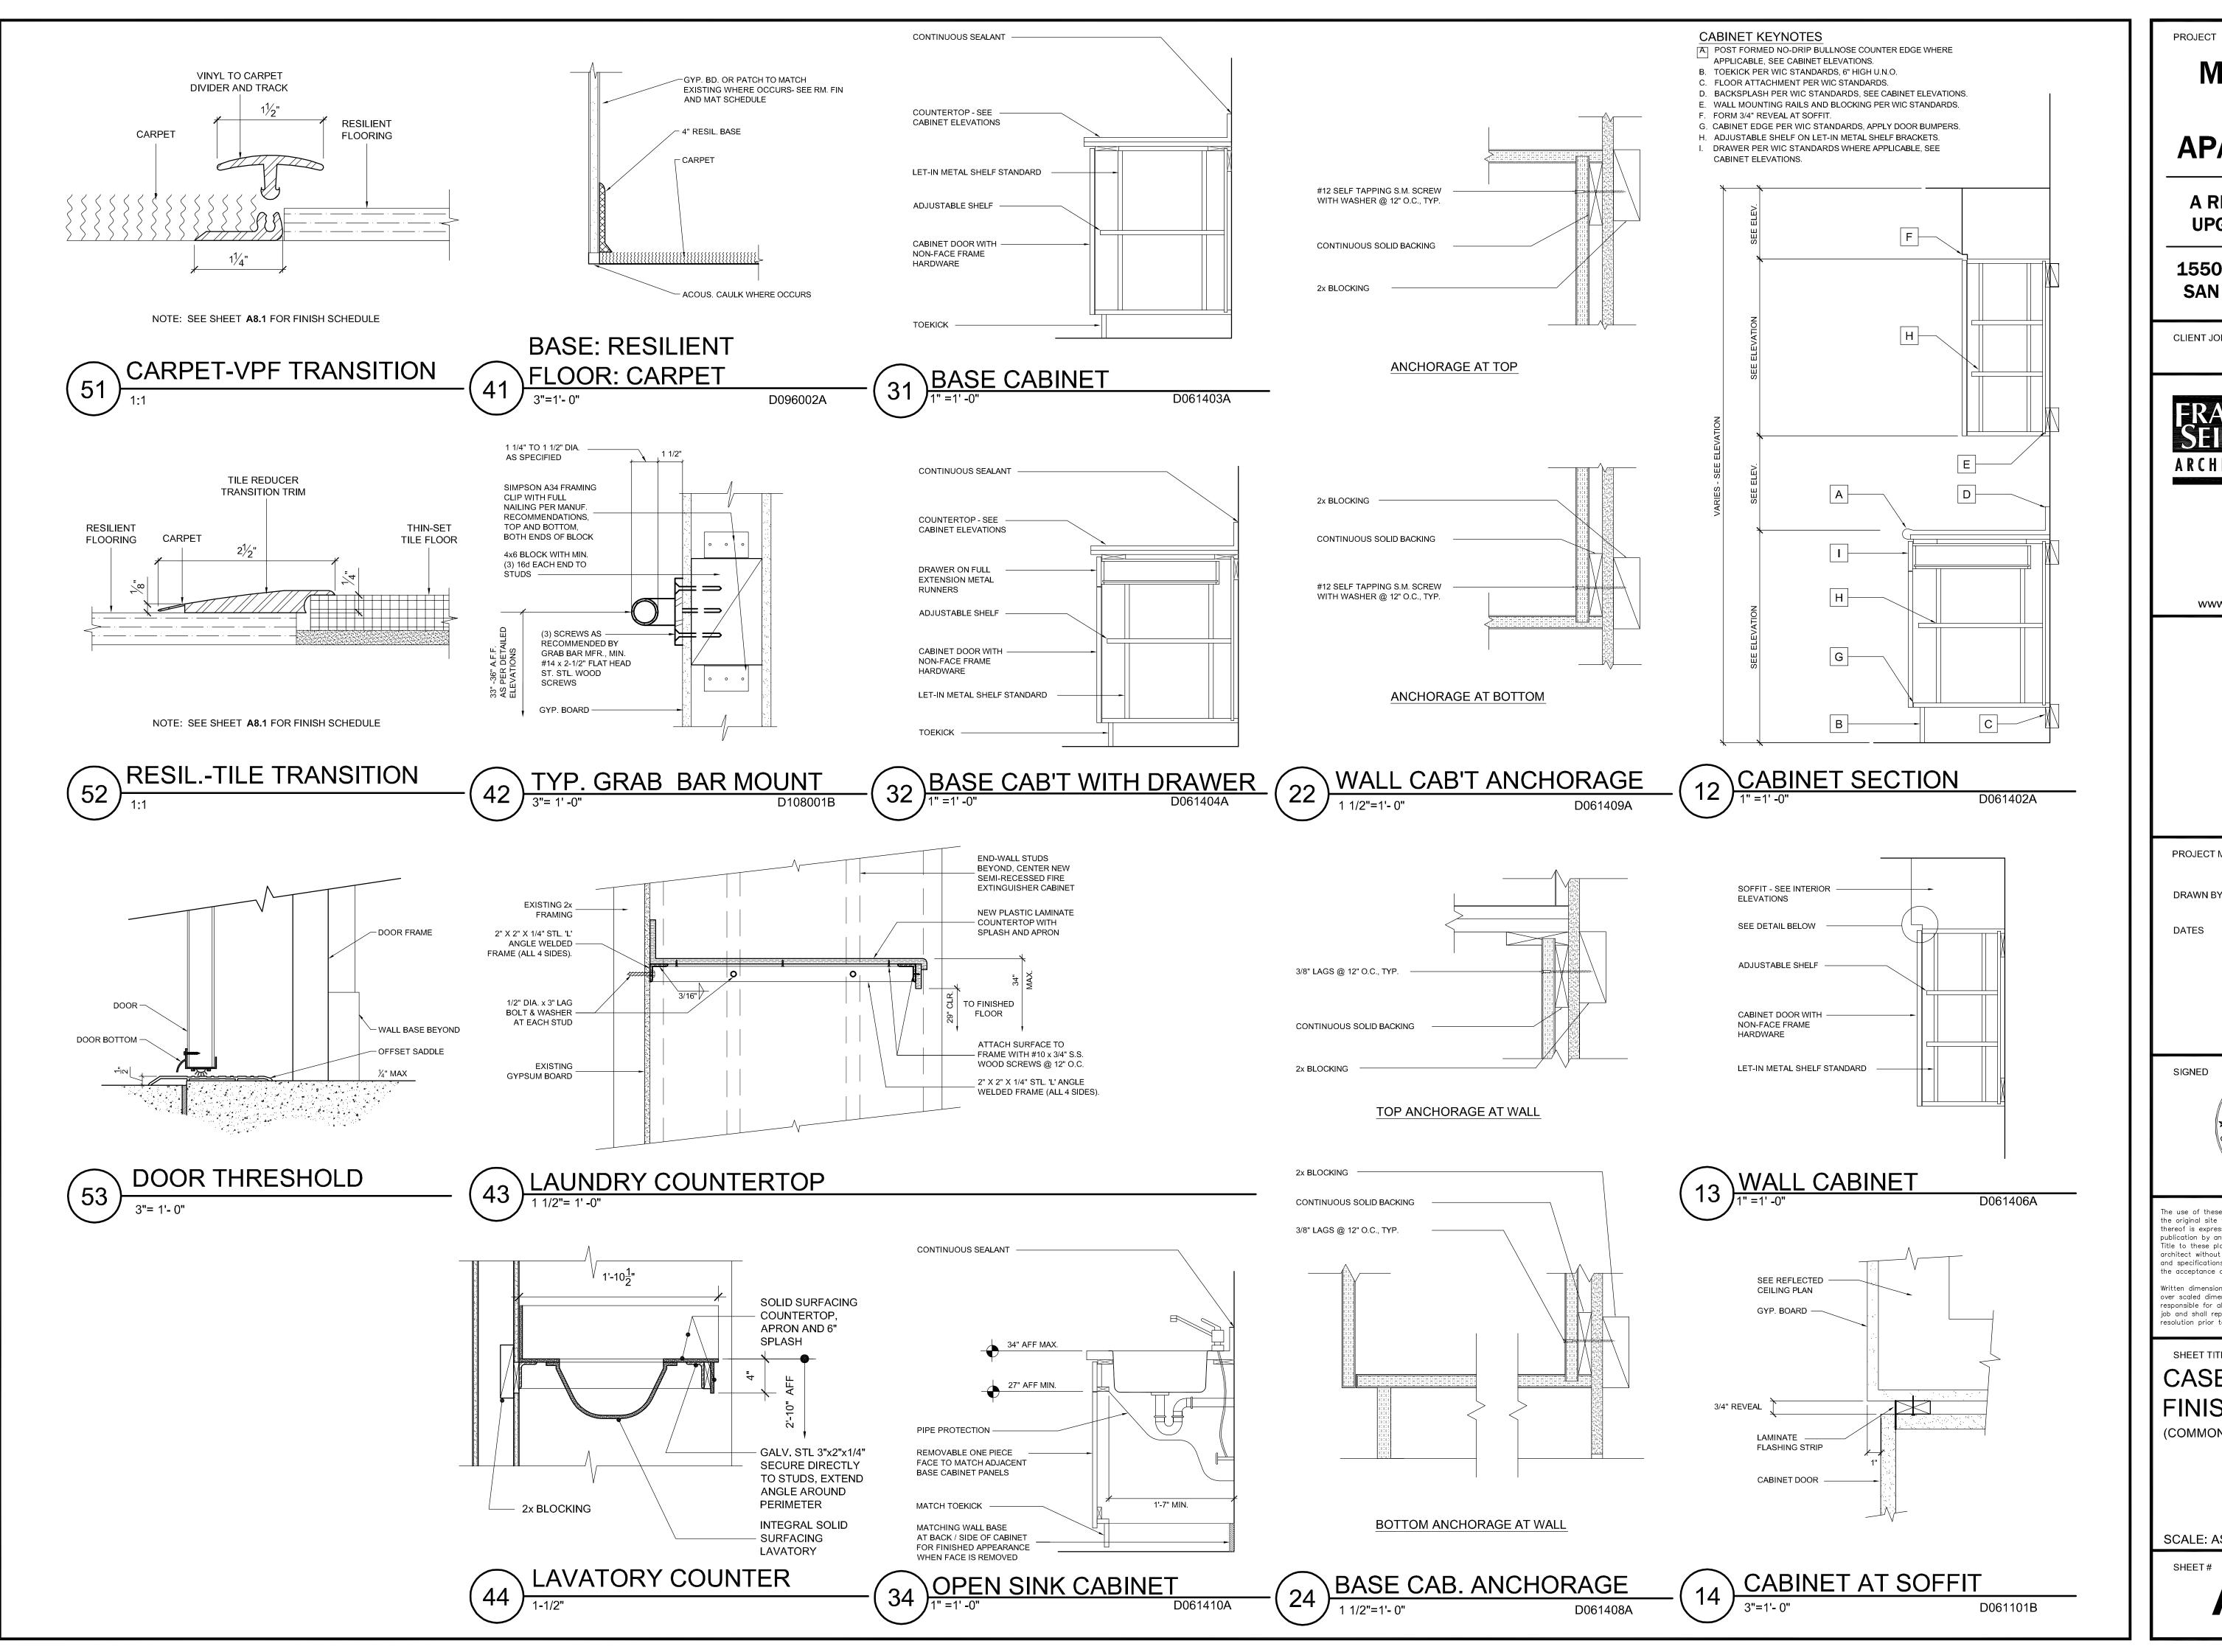

MADONNA ROAD APARTMENTS

A RENOVATION AND **UPGRADE PROJECT**

1550 MADONNA ROAD SAN LUIS OBISPO, CA

CLIENT JOB# ARCHITECT JOB# 1207



971 OSOS STREET SAN LUIS OBISPO CALIFORNIA 93401

805-544-6161

www.fraserseiplearchitects.com

PROJECT MANAGER BDF

DRAWN BY DDL

08-08-2012 1st SUBMITTAL 09-19-2012 1st RE-SUBMITTAL

10-05-2012 FOR CONSTRUCTION

The use of these plans and specifications shall be restricted the original site for which they were prepared and publication thereof is expressly limited to such use. Reproduction or publication by any method, in whole or in part, is prohibited Title to these plans and specifications remain with the architect without prejudice. Visual contact with these plans and specifications shall constitute prima facie evidence of e acceptance of these restrictions. Written dimensions on these drawings shall have precedence

over scaled dimensions. Contractors shall verify and be responsible for all dimensions and existing conditions on the job and shall report any discrepancies to the architect for resolution prior to commencing work.

SHEET TITLE

CASEWORK & FINISH DETAILS

(COMMON BUILDINGS & RESIDENTIAL

SCALE: AS NOTED